

CAMERON PLAN 1853

ELEV. '1	' AREA	ELEV. '2	' AREA	ELEV. '3	B' AREA	ELEV. '4	' AREA
Name	Area	Name	Area	Name	Area	Name	Area
FIRST FLOOR	747 SF						
SECOND FLOOR	1106 SF	SECOND FLOOR	1092 SF	SECOND FLOOR	1092 SF	SECOND FLOOR	1104 SF
HEATED	1853 SF	HEATED	1839 SF	HEATED	1839 SF	HEATED	1851 SF
GARAGE	414 SF						
PATIO / SCREENED PORCH	100 SF						
PORCH	42 SF	PORCH	84 SF	PORCH	111 SF	PORCH	81 SF
UNHEATED	556 SF	UNHEATED	598 SF	UNHEATED	625 SF	UNHEATED	595 SF

GENERAL NOTES:

THESE DOCUMENTS ARE THE PROPERTY OF THE DESIGNER AND SHALL NOT BE COPIED, DUPLICATED, ALTERED, MODIFIED OR REVISED IN ANY WAY WITHOUT THE EXPRESSED WRITTEN APPROVAL OF THE DESIGNER.

CONTRACTOR SHALL VERIFY ALL CONDITIONS AND DIMENSIONS AT THE SITE AND ALL INCONSISTENCES SHALL BE BROUGHT TO THE ATTENTION OF THE DEVELOPER AND THE DESIGNER BEFORE PROCEEDING WITH WORK.

ANY ERRORS OR OMISSIONS FOUND IN THESE DRAWINGS SHALL BE BROUGHT TO DEVELOPERS AND DESIGNERS ATTENTION IMMEDIATELY.

DO NOT SCALE DRAWINGS. WRITTEN DIMENSIONS TAKE PRECEDENCE OVER SCALED

DIMENSIONS.
ALL DIMENSIONS ARE TO FACE OF STUD OR TO FACE OF FRAMING UNLESS

OTHERWISE NOTED.

ALL TRUSS DRAWINGS TO BE REVIEWED AND APPROVED BY THE STRUCTURAL ENGINEER PRIOR TO ISSUANCE OF BUILDING PERMIT.

ALL OR EQUAL SUBSTITUTIONS MUST BE SUBMITTED TO AND APPROVED BY CITY BUILDING OFFICIAL PRIOR TO INSTALLATION.

ALL ANGLED PARTITIONS ARE 45 DEGREES UNLESS OTHERWISE NOTED PROVIDE FIREBLOCKING. (PER LOCAL CODES.)

ALL ELECTRICAL AND MECHANICAL EQUIPMENT AND METERS ARE SUBJECT TO RELOCATION DUE TO FIELD CONDITIONS, CONTRACTOR TO VERIFY.

PROVIDE BLOCKING ANDIOR BACKING AT ALL TOWEL BAR, TOWEL RING ANDIOR TOILET PAPER HOLDER LOCATIONS, AS SHOWN PER PLAN. TYPICAL AT ALL BATHROOMS AND POWDER ROOMS. VERIFY LOCATIONS AT FRAMING WALK. FLASTOMERIC SHEFT WATERPROOFING: FLIRNISH AND INSTALL ALL WATERPROOFING.

COMPLETE. A 40 MIL. SELF-ADHERING MEMBRANE OF RUBBERIZED ASPHALT INTEGRALLY BONDED TO POLYETHYLENE SHEETING, OR EQUAL. INSTALL PER MANUFACTURES AND TRADE ASSOCIATIONS PRINTED INSTALL LATING INSTRUCTIONS. 6° MINIMUM LAP AT ALL ADJACENT WALL SURFACES.

TO THE BEST OF THE DESIGNER'S KNOWLEDGE THESE DOCUMENTS ARE IN CONFORMANCE WITH THE REQUIREMENTS OF THE BUILDING AUTHORITIES HAVING JURISDICTION OVER THIS TYPE OF CONSTRUCTION AND OCCUPANCY.

SHOP DRAWING REVIEW AND DISTRIBUSTION, ALONG WITH PRODUCT SUBMITTALS,

REQUESTED IN THE CONSTRUCTION DOCUMENTS, SHALL BE THE SOLE RESPONSIBILITY OF THE GENERAL CONTRACTOR, UNLESS DIRECTED OTHERWISE UNDER A SEPARATE AGREEMENT.

DEVIATIONS FROM THESE DOCUMENTS IN THE CONSTRUCTION PHASE SHALL BE

DEVIATIONS FROM THESE DOCUMENTS IN THE CONSTRUCTION PHASE SHALL BE REVIEWED BY THE DESIGNER AND THE OWNER PRIOR TO THE START OF WORK IN QUESTION. ANY DEVIATIONS FROM THESE DOCUMENTS WITHOUT PRIOR REVIEW, SHALL BE THE SOLE RESPONSIBILITY OF THE GENERAL CONTRACTOR.

THE GENERAL CONTRACTOR SHALL BE RESPONSIBLE FOR ALL WORK AND MATERIALS REPRESENTED ON THESE DOCUMENTS INCLUDING THE WORK AND MATERIALS FURNISHED BY SUBCONTRACTORS AND VENDORS.

THE OWNER SHALL FURNISH ANY AND ALL REPORTS RECEIVED FROM THE GEOTECHNICAL ENGINEER, GOILS REPORT), ON THE STUDY OF THE PROPOSED SITE, TO THE DESIGNER, STRUCTURAL ENGINEER, AND GENERAL CONTRACTOR. IN THE EVENT THE GEOTECHNICAL REPORTS DO NOT EXIST, THE SOILS CONDITION SHALL BE ASSUMED TO BE A MINIMUM DESIGN SOIL PRESSURE STATED BY THE STRUCTURAL ENGINEER OF RECORD FOR THE PURPOSE OF STRUCTURAL DESIGN. GENERAL CONTRACTOR SHALL ASSURE THE SOIL CONDITIONS MEET OR EXCEED THE CRITERIA.

ALL WORK PERFORMED BY THE GENERAL CONTRACTOR SHALL COMPLY AND CONFORM WITH LOCAL AND STATE BUILDING CODES, ORDINANCES AND REGULATIONS, ALONG WITH ALL OTHER AUTHORITIES HAVING SURISDICTION. THE GENERAL CONTRCATOR IS RESPONSIBLE TO BE AWARE OF THESE REQUIREMENTS AND GOVERNING REGULATIONS.

PROVIDE AN APPROVED WASHER DRAIN PAN AT SECOND FLOOR ONLY THAT DRAINS TO EXTERIOR

WINDOW SUPPLIER TO VERIFY AT LEAST ONE WINDOW IN ALL BEDROOMS TO HAVE A CLEAR OPENABLE AREA OF 4.0 S Q FT. THE MINIMUM NET CLEAR OPENING HEIGHT SHALL BE 22" AND THE MINIMUM NET CLEAR OPENING WIDTH SHALL BE 22" GLAZING TOTAL AREA OF NOT LESS THAN 5.0 SQ FT IN THE CASE OF A GROUND WINDOW AND NOT LESS THAN 5.7 SQ FT IN THE CASE OF A UPPER STORY WINDOW, (PER NOFC SECTION R 1901.1)

CASE OF AN UPPER STORY WINDOW. (PER NORC SECTION R39:0.1.1)
ALL HANDRAIL BALLUSTERS TO BE SPACED SUCH THAT A 4" SPHERE CANNOT PASS BETWEEN BALLUSTERS. (PER LOCAL CODES.)
PROVIDE STAIR HANDRAILS AND GUARDRAILS PER

LOCAL CODES.

BUILDER SET:

THE SCOPE OF THIS SET OF PLANS IS TO PROVIDE A "BUILDER'S SET"
OF CONSTRUCTION DOCUMENTS AND GENERAL NOTES HEREINAFTER REFERRED TO AS "PLANS".
THIS SET OF PLANS IS SUFFICIENT TO DETAIN A BUILDING PERMIT-HOWEVER, ALL MATERIALS
AND METHODS OF CONSTRUCTION NECESSARY TO COMPLETE THE PROJECT ARE NOT
NECESSARILY DESCRIBED. THE PLANS DELINEATE AND DESCRIBE ONLY LOCATIONS,
DIMENSIONS, TYPES OF MATERIALS, AND GENERAL METHODS OF ASSEMBLING OR FASTENING,
THEY ARE NOT INTENDED TO SPECIFY PARTICULAR PRODUCTS OR OTHER METHODS OF ANY
SPECIFIC MATERIALS, PRODUCT OR METHOD. THE IMPLEMENTATION OF THE PLANS REQUIRES A
CLIENT /CONTRACTOR THOROUGHLY KNOWLEDGEABLE WITH THE APPLICABLE BUILDING CODES
AND METHODS OF CONSTRUCTION SPECIFIC TO THIS PRODUCT TYPE AND TYPE OF CONSTRUCTION.

CONSTRUCTION REQUIREMENTS AND QUALITY: PROVIDE WORK OF THE SPECIFIC QUALITY; WHERE QUALITY LEVEL IS NOT INDICATED, PROVIDE WORK OF QUALITY CUSTOMARY IN SIMILAR TYPES OF WORK, WHERE THE PLANS AND SPECIFICATIONS, CODES, LAWS, REGULATIONS, MANUFACTURERS RECOMMENDATIONS OF INDUSTRY STANDARDS REQUIRE WORK OF HIGHER QUALITY OR PERFORMANCE, PROVIDE WORK COMPLYING WITH THOSE REQUIREMENTS AND QUALITY, WHERE TWO OR MORE QUALITY PROVISIONS OF THOSE REQUIREMENTS CONFLICT WITH THE MOST STRINGENT REQUIREMENT; WHERE REQUIREMENTS ARE DIFFERENT BUT APPARENTLY EQUAL, AND WHERE IT IS UNCENTAINLY MEDICATION SOFT STRINGENT, OBTAIN CLARIFICATION FROM THE ARCHITECT BEFORE PROCEEDING.



NORTH CAROLINA OFFICE 102 FOUNTAIN BROOK CIRCLE SUITE C CARY, NC 27511 PHONE: (919) 320-3022

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L	NO:	DATE:	REVISION:

PROFESSIONAL SEAL

PROJECT TITLE:

QUACKENBUSH HOMES LLC 9220 FAIRBANKS DR SUITE 240 RALEIGH, NC 27613

CONSTRUCTION SET

CLIENTS NAME

QUACKENBUSH HOMES

PROJECT NO: GMD16003RAL

SHEET TITLE:

COVER SHEET

PRINT DATE: 10.19.16

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IRRIGATION SYSTEM SHALL BE DESIGNED TO PREVENT THE SATURATION OF SOIL ADJACENT TO BUILDING.

THIS PERIMETER DIMENSION PLAN IS FOR DIMENSIONAL INFORMATION ONLY.

SLOPE ALL STOOPS AND HARDSCAPE MATERIAL AWAY FROM BUILDING - TYPICAL.

SLOPE GARAGE FLOOR 1/8" PER FOOT TO GARAGE DOOR OPENING.

VERIFY CURB CUT BLOCKOUT WITH GARAGE DOOR MANUFACTURER

REFER TO CIVIL DRAWINGS FOR FINISH SURFACE ELEVATIONS.

FINISH GRADE SHALL PROVIDE POSITIVE DRAINAGE AWAY FROM BUILDING. REFER TO SOILS REPORT FOR ANY SPECIFIC REQUIREMENTS.

REFER TO STRUCTURAL DRAWINGS FOR HOLDDOWNS, FOOTING DETAILS, CURB THICKNESS, AND INFORMATION NOT SHOWN ON THIS PLAN.

PLUMBING FIXTURES, VENT LOCATIONS, ETC. ARE APPROXIMATE. CONTRACTOR TO VERIFY COUNT AND LOCATION

VERIFY THE SUPPLY FOR SEPARATE CONDUITS TO ANY ISLAND FOR GAS, WATER OR ELECTRIC.

VERIFY ALL DOOR THRESHOLD HEIGHTS TO HARD SURFACES. 8 1/4" MAX AT INSWING DOORS. (PER NCRC SECTION R311.3.1.)

TYP STOOP AT INSWING/SLIDER DOORS: 36" DEEP BY THE WIDTH OF THE DOOR SERVED, MINIMUM. (PER NCRC SECTION R311.3.) PROVIDE A SLIP-RESISTANT FINISH.


FOR THE USE OF EXPOSED GAS WATER HEATERS IN THE GARAGE, PROTECT THE WATER HEATER WITH 3" DIA CONCRETE FILLED STEEL PIPE EMBEDDED INTO CONCRETE FOOTING.

SOILS TREATMENT:
BORACARE TERMITE TO BE APPLIED TO FRAMING PER PRODUCT SPECIFICATIONS.
(PROVIDE CHEMICAL TREATMENT FOR PROTECTION FROM TERMITE INFESTATION
ACCORDING TO THE STANDARDS OF THE NC DEPT OF AGRICULTURE.)

WOOD CONTACTING CONCRETE OR MASONRY OR LESS THAN CODE REQUIRED SEPARATION TO GRADE SHALL BE PRESSURE TREATED OR FOUNDATION GRADE REDWOOD. SET ALL EXTERIOR WALL SILLS IN MASTIC.

REFER TO STRUCTURAL DRAWINGS FOR ALL FOUNDATION DIMENSIONS

FOUNDATION KEYNOTE LEGEND			
F1	LINE OF SLAB ABOVE		
F2	LINE OF FRAMED WALL ABOVE		
F6	TYPICAL CRAWL FOUNDATION WALL SHALL BE 8" CMU OR A COMBINATION OF 4" CMU WITH NOMINAL 4" BRICK. SEE STRUCTURAL DRAWINGS FOR ALL STRUCTURAL ATTACHMENTS. ALL BLOCK CELLS AND SPACE BETWEEN BLOCK AND BRICK SHALL BE FILLED WITH SOLID CONCRETE. FOUNDATION WALL WITH FULL HEIGHT BRICKVENEER SHALL CONSIST OF 8" CMU WITH NOMINAL 4" BRICK. SEE STRUCTURAL DRAWINGS FOR ALL STRUCTURAL ATTACHMENTS AND BRICK TIE SPACING. FILL VOIDS SOLID TO TOP OF CMU WALL. (MUST COMPLY WITH NORC SECTION R404, TABLE R404.1.1(1) THROUGH R404.1.1(4) AND APPLICABLE SECTIONS OF R606, R607, R608), VERIFY WITH STRUCTURAL DRAWINGS FOR WALL FOOTING SIZE AND DEPTH.		

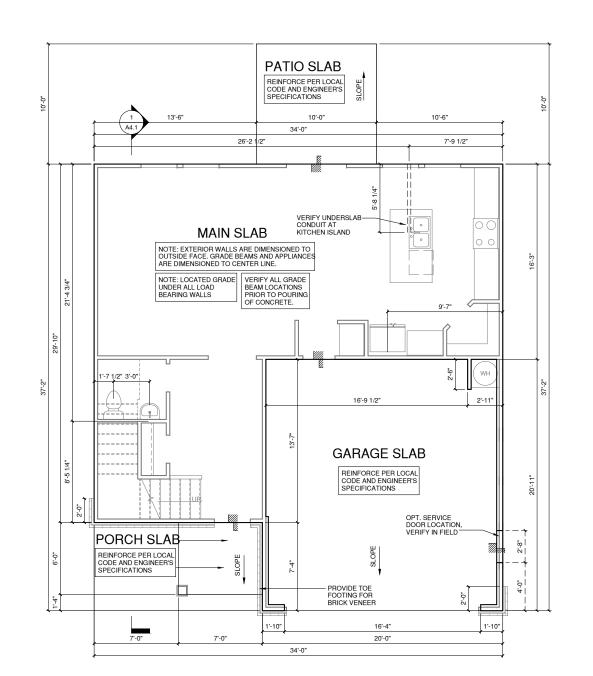

SLAB ELEV '1'



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NO:	DATE:	REVISION:

PROFESSIONAL SEAL:

PROJECT TITLE:

QUACKENBUSH HOMES LLC 9220 FAIRBANKS DR SUITE 240 RALEIGH, NC 27613 919-741-7993

CONSTRUCTION SET

CLIENTS NAME:

QUACKENBUSH HOMES

PROJECT NO:

GMD16003RAL SHEET TITLE:

SLAB ELEV '1'

PRINT DATE:

10.19.16

SHEET NO: A0.1.1

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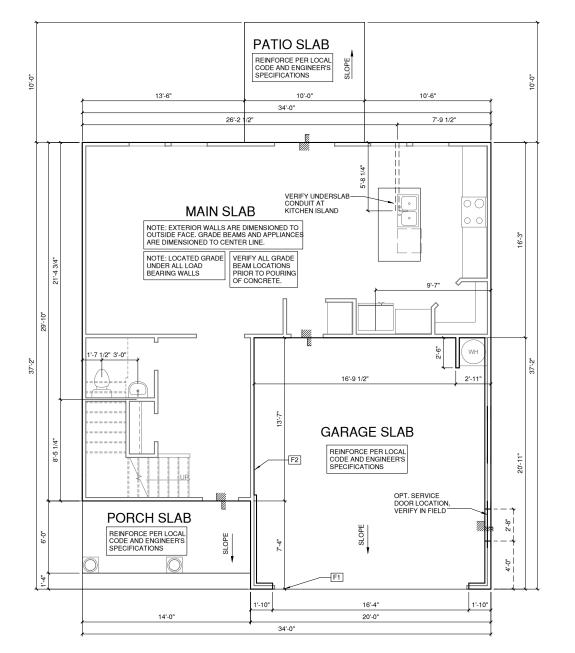
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① SLAB ELEV '2'

1/4" = 1'-0" AT 22"X34" LAYOUT 1/8"= 1'-0" AT 11" X 17" LAYOUT



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CONSTRUCTION SET

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QUACKENBUSH HOMES

PROJECT NO:

GMD16003RAL SHEET TITLE:

SLAB ELEV '2'

PRINT DATE:

10.19.16

SHEET NO: A0.1.2

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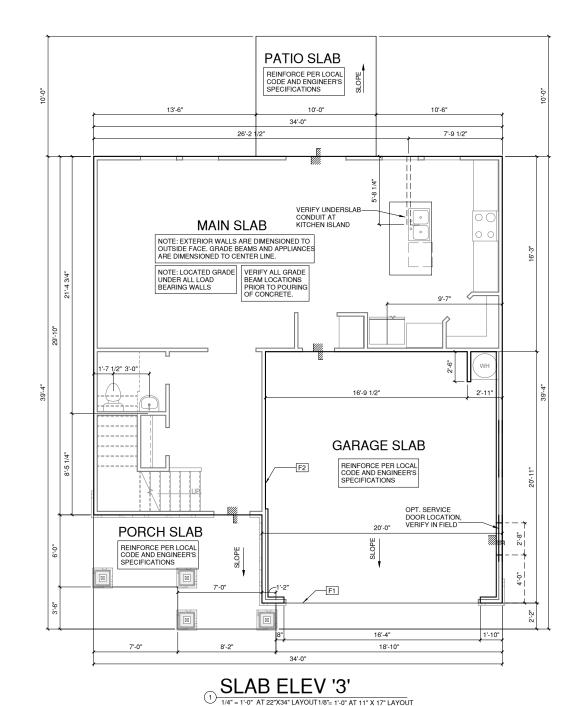
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CONSTRUCTION SET

CLIENTS NAME:

QUACKENBUSH HOMES

PROJECT NO:

GMD16003RAL SHEET TITLE:

SLAB ELEV '3'

PRINT DATE:

10.19.16

SHEET NO:

A0.1.3

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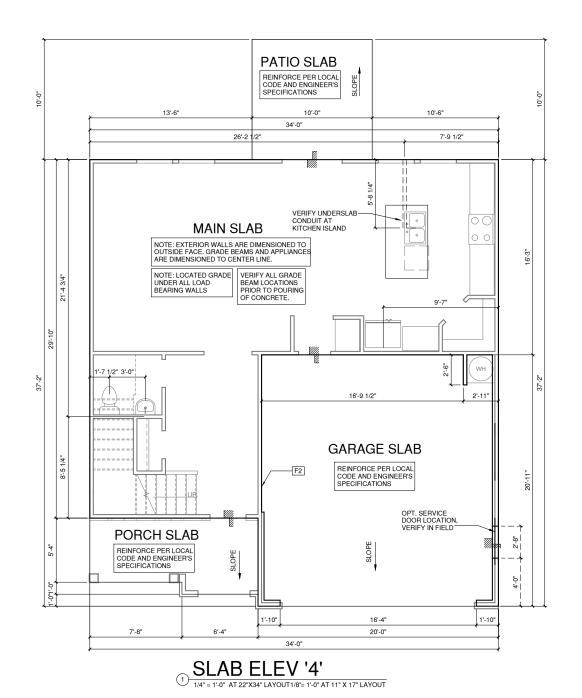
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CONSTRUCTION SET

CLIENTS NAME:

QUACKENBUSH HOMES

PROJECT NO:

GMD16003RAL SHEET TITLE:

SLAB ELEV '4'

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SHEET NO:

A0.1.4

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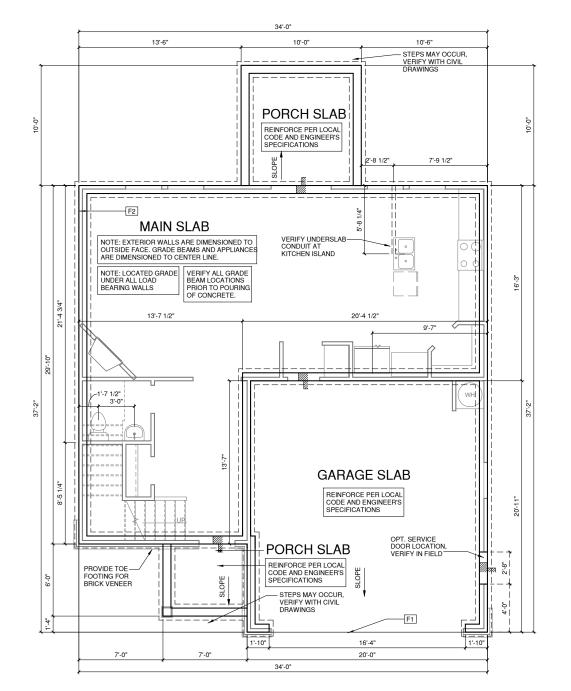
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F2	LINE OF FRAMED WALL ABOVE				
F6	TYPICAL CRAWL FOUNDATION WALL SHALL BE 8" CMU OR A COMBINATION OF 4" CMU WITH NOMINAL 4" BRICK. SEE STRUCTURAL DRAWINGS FOR ALL STRUCTURAL ATTACHMENTS. ALL BLOCK CELLS AND SPACE BETWEEN BLOCK AND BRICK SHALL BE FILLED WITH SOLID CONCRETE. FOUNDATION WALL WITH FULL HEIGHT BRICKVENEER SHALL CONSIST OF 8" CMU WITH NOMINAL 4" BRICK. SEE STRUCTURAL DRAWINGS FOR ALL STRUCTURAL ATTACHMENTS AND BRICK TIE SPACING. FILL VOIDS SOLID TO FOE CMU WALL. (MUST COMPLY WITH NORC SECTION R404, TABLE R404.1.1(1) THROUGH R404.1.1(4) AND APPLICABLE SECTIONS OF R606, R607, R606), VERIFY WITH STRUCTURAL DRAWINGS FOR WALL FOOTING SIZE AND DEFTH.				



② STEMWALL ELEV '1'

1/4" = 1'-0" AT 22"X34" LAYOUT 1/8" = 1'-0" AT 11" X 17" LAYOUT



NORTH CAROLINA OFFICE 102 FOUNTAIN BROOK CIRCLE CARY, NC 27511 PHONE: (919) 320-3022

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NO:	DATE:	REVISION:
PROFESSIONAL SEAL:		

PROJECT TITLE:

QUACKENBUSH HOMES LLC 9220 FAIRBANKS DR SUITE 240 RALEIGH, NC 27613 919-741-7993

CONSTRUCTION SET

CLIENTS NAME:

QUACKENBUSH HOMES

PROJECT NO:

GMD16003RAL SHEET TITLE:

STEMWALL ELEV '1'

PRINT DATE:

10.19.16

SHEET NO:

IRRIGATION SYSTEM SHALL BE DESIGNED TO PREVENT THE SATURATION OF SOIL ADJACENT TO BUILDING.

THIS PERIMETER DIMENSION PLAN IS FOR DIMENSIONAL INFORMATION ONLY.

SLOPE ALL STOOPS AND HARDSCAPE MATERIAL AWAY FROM BUILDING - TYPICAL

SLOPE GARAGE FLOOR 1/8" PER FOOT TO GARAGE DOOR OPENING.

VERIFY CURB CUT BLOCKOUT WITH GARAGE DOOR MANUFACTURER.

REFER TO CIVIL DRAWINGS FOR FINISH SURFACE ELEVATIONS.

FINISH GRADE SHALL PROVIDE POSITIVE DRAINAGE AWAY FROM BUILDING, REFER TO SOILS REPORT FOR ANY SPECIFIC REQUIREMENTS.

REFER TO STRUCTURAL DRAWINGS FOR HOLDDOWNS, FOOTING DETAILS, CURB THICKNESS, AND INFORMATION NOT SHOWN ON THIS PLAN.

PLUMBING FIXTURES, VENT LOCATIONS, ETC. ARE APPROXIMATE. CONTRACTOR TO VERIFY COUNT AND LOCATION

VERIFY THE SUPPLY FOR SEPARATE CONDUITS TO ANY ISLAND FOR GAS, WATER OR ELECTRIC.

VERIFY ALL DOOR THRESHOLD HEIGHTS TO HARD SURFACES. 8 1/4" MAX AT INSWING DOORS. (PER NCRC SECTION R311.3.1.)

TYP STOOP AT INSWING/SLIDER DOORS: 36" DEEP BY THE WIDTH OF THE DOOR SERVED, MINIMUM. (PER NCRC SECTION R311.3.) PROVIDE A SLIP-RESISTANT FINISH.

FOR THE USE OF EXPOSED GAS WATER HEATERS IN THE GARAGE, PROTECT THE WATER HEATER WITH 3" DIA CONCRETE FILLED STEEL PIPE EMBEDDED INTO CONCRETE FOOTING.


SOILS TREATMENT:
BORACARE TERMITE TO BE APPLIED TO FRAMING PER PRODUCT SPECIFICATIONS

(PROVIDE CHEMICAL TREATMENT FOR PROTECTION FROM TERMITE INFESTATION ACCORDING TO THE STANDARDS OF THE NC DEPT OF AGRICULTURE.)

WOOD CONTACTING CONCRETE OR MASONRY OR LESS THAN CODE REQUIRED SEPARATION TO GRADE SHALL BE PRESSURE TREATED OR FOUNDATION GRADE REDWOOD. SET ALL EXTERIOR WALL SILLS IN MASTIC.

REFER TO STRUCTURAL DRAWINGS FOR ALL FOUNDATION DIMENSIONS

FOU	FOUNDATION KEYNOTE LEGEND		
F1	LINE OF SLAB ABOVE		
F2	LINE OF FRAMED WALL ABOVE		
F6	TYPICAL CRAWL FOUNDATION WALL SHALL BE 8" CMU OR A COMBINATION OF 4" CMU WITH NOMINAL 4" BRICK. SEE STRUCTURAL DRAWINGS FOR ALL STRUCTURAL ATTACHMENTS. ALL BLOCK CELLS AND SPACE BETWEEN BLOCK AND BRICK SHALL BE FILLED WITH SOLID CONCRETE. FOUNDATION WALL WITH FULL HEIGHT BRICKVENEER SHALL CONSIST OF 8" CMU WITH NOMINAL 4" BRICK. SEE STRUCTURAL DRAWINGS FOR ALL STRUCTURAL ATTACHMENTS AND BRICK TIE SPACING. FILL VOIDS SOLID TO TOP OF CMU WALL. (MUST COMPLY WITH NORC SECTION R404, TABLE R404.1.1(1) THROUGH R404.1.1(4) AND APPLICABLE SECTIONS OF R606, R607, R608). VERIFY WITH STRUCTURAL DRAWINGS FOR WALL FOOTING SIZE AND DEPTH.		

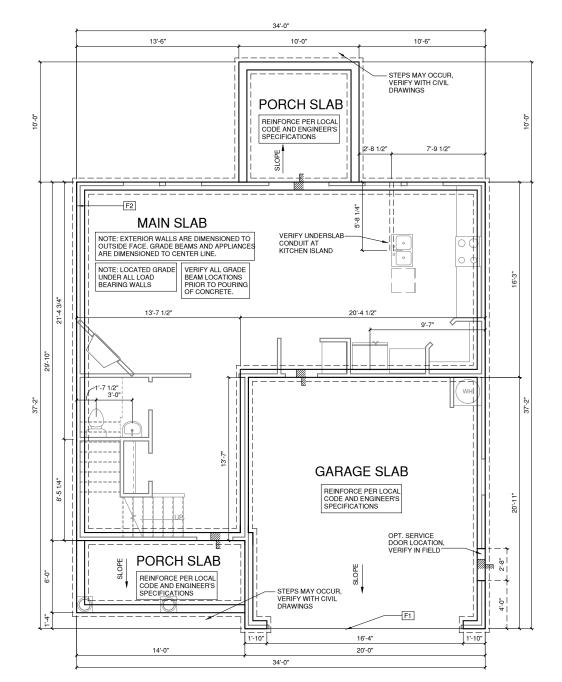

② STEMWALL ELEV '2'

1/4" = 1'-0" AT 22"X34" LAYOUT1/8"= 1'-0" AT 11" X 17" LAYOUT



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NO:	DATE:	REVISION:

PROFESSIONAL SEAL:

PROJECT TITLE:

QUACKENBUSH HOMES LLC 9220 FAIRBANKS DR SUITE 240 RALEIGH, NC 27613 919-741-7993

CONSTRUCTION SET

CLIENTS NAME:

QUACKENBUSH HOMES

PROJECT NO: GMD16003RAL

SHEET TITLE:

STEMWALL ELEV '2'

PRINT DATE:

10.19.16

SHEET NO:

RRIGATION SYSTEM SHALL BE DESIGNED TO PREVENT THE SATURATION OF SOIL ADJACENT TO BUILDING.

SLOPE ALL STOOPS AND HARDSCAPE MATERIAL AWAY FROM BUILDING - TYPICAL.

SLOPE GARAGE FLOOR 1/8" PER FOOT TO GARAGE DOOR OPENING.

VERIFY CURB CUT BLOCKOUT WITH GARAGE DOOR MANUFACTURER

REFER TO CIVIL DRAWINGS FOR FINISH SURFACE ELEVATIONS.

FINISH GRADE SHALL PROVIDE POSITIVE DRAINAGE AWAY FROM BUILDING. REFER TO SOILS REPORT FOR ANY SPECIFIC REQUIREMENTS.

REFER TO STRUCTURAL DRAWINGS FOR HOLDDOWNS, FOOTING DETAILS, CURB THICKNESS, AND INFORMATION NOT SHOWN ON THIS PLAN.

PLUMBING FIXTURES, VENT LOCATIONS, ETC. ARE APPROXIMATE. CONTRACTOR TO VERIFY COUNT AND LOCATION.

VERIFY THE SUPPLY FOR SEPARATE CONDUITS TO ANY ISLAND FOR GAS, WATER OR ELECTRIC

TYP STOOP AT INSWING/SLIDER DOORS: 36" DEEP BY THE WIDTH OF THE DOOR SERVED, MINIMUM

(PER NCRC SECTION R311.3.) PROVIDE A SLIP-RESISTANT FINISH.


FOR THE USE OF EXPOSED GAS WATER HEATERS IN THE GARAGE, PROTECT THE WATER HEATER WITH

SOILS TREATMENT:
BORACARE TERMITE TO BE APPLIED TO FRAMING PER PRODUCT SPECIFICATIONS. (PROVIDE CHEMICAL TREATMENT FOR PROTECTION FROM TERMITE INFESTATION ACCORDING TO THE STANDARDS OF THE NC DEPT OF AGRICULTURE.)

WOOD CONTACTING CONCRETE OR MASONRY OR LESS THAN CODE REQUIRED SEPARATION TO GRADE SHALL BE PRESSURE TREATED OR FOUNDATION GRADE REDWOOD. SET ALL EXTERIOR WALL SILLS IN MASTIC.

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STEMWALL ELEV '3'

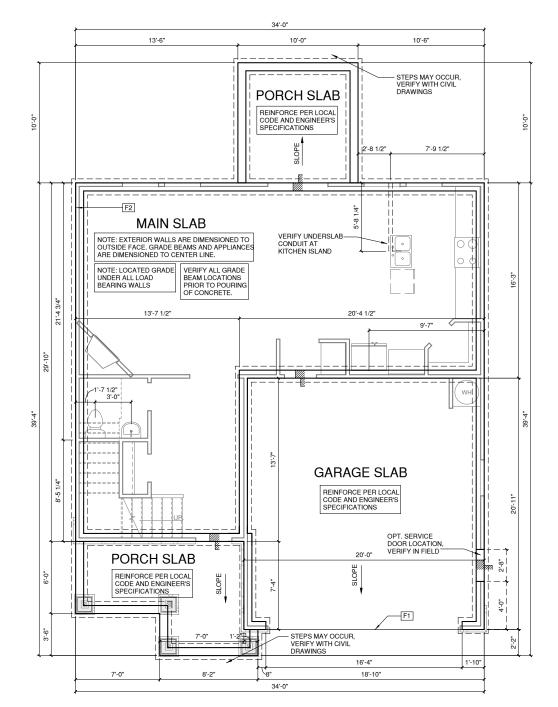

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NO:	DATE:	REVISION:

PROFESSIONAL SEAL:

PROJECT TITLE:

QUACKENBUSH HOMES LLC 9220 FAIRBANKS DR SUITE 240 RALEIGH, NC 27613 919-741-7993

CONSTRUCTION SET

CLIENTS NAME:

QUACKENBUSH HOMES

PROJECT NO:

GMD16003RAI SHEET TITLE:

STEMWALL ELEV '3'

PRINT DATE:

10.19.16

SHEET NO:

IRRIGATION SYSTEM SHALL BE DESIGNED TO PREVENT THE SATURATION OF SOIL ADJACENT TO BUILDING.

THIS PERIMETER DIMENSION PLAN IS FOR DIMENSIONAL INFORMATION ONLY.

SLOPE ALL STOOPS AND HARDSCAPE MATERIAL AWAY FROM BUILDING - TYPICAL.

SLOPE GARAGE FLOOR 1/8" PER FOOT TO GARAGE DOOR OPENING

VERIFY CURB CUT BLOCKOUT WITH GARAGE DOOR MANUFACTURER

REFER TO CIVIL DRAWINGS FOR FINISH SURFACE ELEVATIONS.

- FINISH GRADE SHALL PROVIDE POSITIVE DRAINAGE AWAY FROM BUILDING. REFER TO SOILS REPORT FOR ANY SPECIFIC REQUIREMENTS.

- REFER TO STRUCTURAL DRAWINGS FOR HOLDDOWNS, FOOTING DETAILS, CURB THICKNESS, AND

PLUMBING FIXTURES, VENT LOCATIONS, ETC. ARE APPROXIMATE. CONTRACTOR TO VERIFY COUNT AND LOCATION

VERIFY THE SUPPLY FOR SEPARATE CONDUITS TO ANY ISLAND FOR GAS, WATER OR ELECTRIC.

- VERIFY ALL DOOR THRESHOLD HEIGHTS TO HARD SURFACES. 8 1/4" MAX AT INSWING DOORS. (PER NCRC SECTION R311.3.1.)

TYP STOOP AT INSWING/SLIDER DOORS: 36" DEEP BY THE WIDTH OF THE DOOR SERVED, MINIMUM.

(PER NCRC SECTION R311.3.) PROVIDE A SLIP-RESISTANT FINISH.


- FOR THE USE OF EXPOSED GAS WATER HEATERS IN THE GARAGE, PROTECT THE WATER HEATER WITH 3" DIA CONCRETE FILLED STEEL PIPE EMBEDDED INTO CONCRETE FOOTING.

- SOILS TREATMENT: BORACARE TERMITE TO BE APPLIED TO FRAMING PER PRODUCT SPECIFICATIONS. (PROVIDE CHEMICAL TREATMENT FOR PROTECTION FROM TERMITE INFESTATION ACCORDING TO THE STANDARDS OF THE NC DEPT OF AGRICULTURE.)

WOOD CONTACTING CONCRETE OR MASONRY OR LESS THAN CODE REQUIRED SEPARATION TO GRADE SHALL BE PRESSURE TREATED OR FOUNDATION GRADE REDWOOD. SET ALL EXTERIOR WALL SILLS IN MASTIC.

REFER TO STRUCTURAL DRAWINGS FOR ALL FOUNDATION DIMENSIONS

FOU
F1
F2
F6

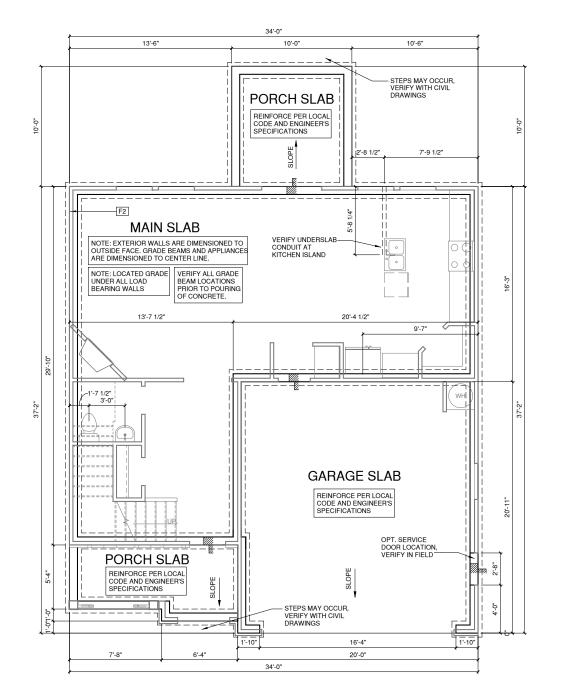

STEMWALL ELEV '4'



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NO:	DATE:	REVISION:

PROFESSIONAL SEAL:

PROJECT TITLE:

QUACKENBUSH HOMES LLC 9220 FAIRBANKS DR SUITE 240 RALEIGH, NC 27613 919-741-7993

CONSTRUCTION SET

CLIENTS NAME:

QUACKENBUSH HOMES

PROJECT NO:

GMD16003RAL SHEET TITLE:

STEMWALL ELEV '4'

PRINT DATE:

10.19.16

SHEET NO:

REFER TO STRUCTURAL DRAWINGS FOR INFORMATION NOT SHOWN ON THIS PLAN.

FOR ADDITIONAL NOTES SEE GENERAL NOTES ON TITLE SHEET AND DETAILS.

PROVIDE FIREBLOCKING. (PER NCRC SECTION R602.8)

-ALL ELECTRICAL AND MECHANICAL EQUIPMENT AND METERS ARE SUBJECT TO RELOCATION DUE TO FIELD CONDITIONS, CONTRACTOR TO VERIFY.

-VERIFY ALL DOOR THRESHOLD HEIGHTS TO HARD S URFACES. 8 1/4" MAX AT INSWING DOORS. (PER NCRC SECTION R311.3.1)

SLOPE ALL STOOPS AND HARDSCAPE MATERIAL AWAY FROM BUILDING - TYPICAL

SLOPE GARAGE FLOOR 1/8" PER FOOT TO GARAGE DOOR OPENING.

VERIFY CURB CUT BLOCKOUT WITH GARAGE DOOR MANUFACTURER.

REFER TO CIVIL DRAWINGS FOR FINISH SURFACE ELEVATIONS.

-TYP, STOOP AT INSWING/SLIDER DOORS: 36" DEEP BY THE WIDTH OF THE DOOR SERVED.

NIMUM (PER NCRC SECTIONS R311.3) PROVIDE A SLIP-RESISTANT FINISH

-SOILS TREATMENT:
BORACARE TERMITE TO BE APPLIED TO FRAMING PER PRODUCT SPECIFICATIONS. (PROVIDE CHEMICAL TREATMENT FOR PROTECTION
FROM TERMITE INVESTATION ACCORDING TO THE STANDARDS OF THE NCDEPT. OF AGRICULTURE.)

APPLY AN APPROVED VAPOR RETARDER OR EQUIVALENT, 6 MIL POLY-VINYL, GROUND COVER OVER FINISH GRADE OR CRAWL SPACE PER NCRC SECTION 408.2


PROVIDE VENTS SPACED AROUND PERIMETER TO PROMOTE CROSS VENTILATION AT A RATE OF 1 SF VENT FOR EVERY 1500 SF OF CRAWL FLOOR AREA. ONE VENT MUST BE LOCATED WITHIN 3-0" OF EACH CORNER OF THE BUILDING AND LOCATED TO ALLOW FOR CROSS VENTILATION. (PER NCRC SECTION R408.1.1 EXCEPTION.)

-PROVIDE AN ACCESS OPENING, MINIMUM SIZE OF 18"X24" FOR CRAWL ACCESS. COORDINATE WITH MECHANICAL CONTRACTOR FOR LARGER SIZE REQUIREMENTS IF MECHANICAL EQUIPMENT IS LOCATED IN CRAWL. (PER NCRC SECTION 408.8)

-WOOD CONTACTING CONCRETE OR MASONRY OR LESS THAN CODE REQUIRED SEPARATION TO GRADE SHALL BE PRESSURE TREATED OR FOUNDATION GRADE REDWOOD. SET ALL EXTERIOR WALL SILLS IN MASTIC.

REFER TO STRUCTURAL DRAWINGS FOR ALL FOUNDATION DIMENSIONS

FOU	FOUNDATION KEYNOTE LEGEND		
F1	LINE OF SLAB ABOVE		
F2	LINE OF FRAMED WALL ABOVE		
F6	TYPICAL CRAWL FOUNDATION WALL SHALL BE 8" CMU OR A COMBINATION OF 4" CMU WITH NOMINAL 4" BRICK. SEE STRUCTURAL DRAWINGS FOR ALL STRUCTURAL ATTACHMENTS. ALL BLOCK CELLS AND SPACE BETWEEN BLOCK AND BRICK SHALL BE FILLED WITH SOLID CONCRETE. FOUNDATION WALL WITH FULL HEIGHT BRICKVENEER SHALL CONSIST OF 8" CMU WITH NOMINAL 4" BRICK. SEE STRUCTURAL DRAWINGS FOR ALL STRUCTURAL ATTACHMENTS AND BRICK TIE SPACING. FILL VOIDS SOLID TO TOP OF CMU WALL. (MUST COMPLY WITH NCRC SECTION R404, TABLE R404.1.1(1) THROUGH R404.1.1(4) AND APPLICABLE SECTIONS OF R606, R607, R608). VERIFY WITH STRUCTURAL DRAWINGS FOR WALL FOOTING SIZE AND DEPTH.		

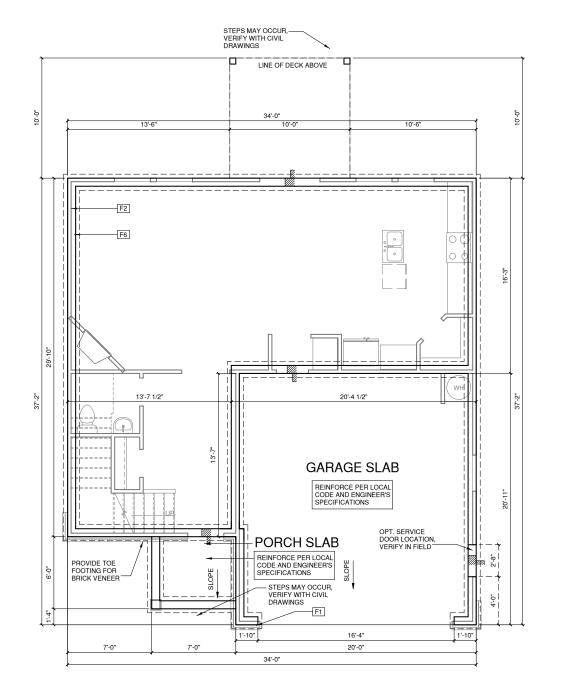





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NO:	DATE:	REVISION:

PROFESSIONAL SEAL:

PROJECT TITLE:

QUACKENBUSH HOMES LLC 9220 FAIRBANKS DR SUITE 240 RALEIGH, NC 27613 919-741-7993

CONSTRUCTION SET

CLIENTS NAME:

QUACKENBUSH HOMES

PROJECT NO:

GMD16003RAL SHEET TITLE:

CRAWL SPACE ELEV '1'

PRINT DATE:

10.19.16

SHEET NO: A0.3.1

REFER TO STRUCTURAL DRAWINGS FOR INFORMATION NOT SHOWN ON THIS PLAN.

FOR ADDITIONAL NOTES SEE GENERAL NOTES ON TITLE SHEET AND DETAILS.

PROVIDE FIREBLOCKING. (PER NCRC SECTION R602.8)

ALL ELECTRICAL AND MECHANICAL EQUIPMENT AND METERS ARE SUBJECT TO RELOCATION DUE TO FIELD CONDITIONS, CONTRACTOR

VERIFY ALL DOOR THRESHOLD HEIGHTS TO HARD S URFACES 8 1/4" MAX AT INSWING DOORS, (PER NCRC SECTION R311,3,1)

SLOPE ALL STOOPS AND HARDSCAPE MATERIAL AWAY FROM BUILDING - TYPICAL

SLOPE GARAGE FLOOR 1/8" PER FOOT TO GARAGE DOOR OPENING.

VERIFY CURB CUT BLOCKOUT WITH GARAGE DOOR MANUFACTURER.

REFER TO CIVIL DRAWINGS FOR FINISH SURFACE ELEVATIONS.

TYP, STOOP AT INSWING/SLIDER DOORS: 36" DEEP BY THE WIDTH OF THE DOOR SERVED

MINIMUM (PER NORC SECTIONS R311.3) PROVIDE A SLIP-RESISTANT FINISH

SOILS THEATMENT:
SORACARE TERMITE TO BE APPLIED TO FRAMING PER PRODUCT SPECIFICATIONS. (PROVIDE CHEMICAL TREATMENT FOR PROTECTION FROM TERMITE INVESTATION ACCORDING TO THE STANDARDS OF THE NCDEPT. OF AGRICULTURE.)

APPLY AN APPROVED VAPOR RETARDER OR EQUIVALENT, 6 MIL POLY-VINYL, GROUND COVER OVER FINISH GRADE OR CRAWL SPACE PER NCRO SECTION 408.2


PROVIDE VENTS SPACED AROUND PERIMETER TO PROMOTE CROSS VENTILATION AT A RATE OF 1 SF VENT FOR EVERY 1500 SF OF CRAWL FLOOR AREA. ONE VENT MUST BE LOCATED WITHIN 3-0" OF EACH CORNER OF THE BUILDING AND LOCATED TO ALLOW FOR CROSS VENTILATION. (PER NCRC SECTION R408.1.1 EXCEPTION.)

PROVIDE AN ACCESS OPENING, MINIMUM SIZE OF 18"X24" FOR CRAWL ACCESS. COORDINATE WITH MECHANICAL CONTRACTOR FOR ARGER SIZE REQUIREMENTS IF MECHANICAL EQUIPMENT IS LOCATED IN CRAWL. (PER NCRC SECTION 408.8)

-WOOD CONTACTING CONCRETE OR MASONRY OR LESS THAN CODE REQUIRED SEPARATION TO GRADE SHALL BE PRESSURE TREATED OR FOUNDATION GRADE REDWOOD. SET ALL EXTERIOR WALL SILLS IN MASTIC.

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F1	LINE OF SLAB ABOVE
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NO:	DATE:	REVISION:

PROFESSIONAL SEAL:

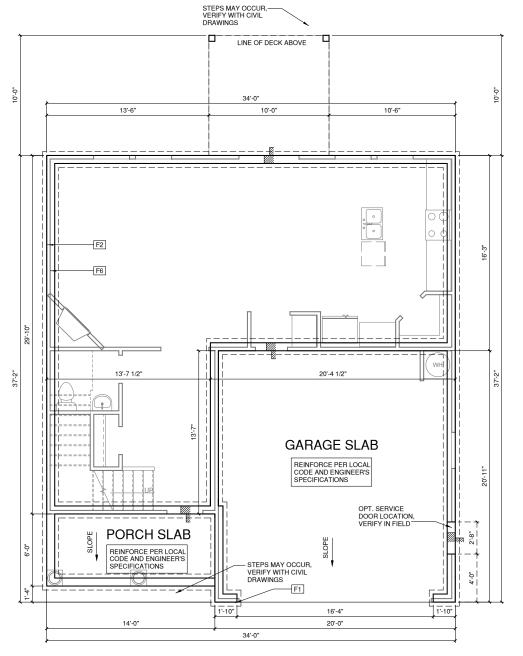PROJECT TITLE:

QUACKENBUSH HOMES LLC 9220 FAIRBANKS DR SUITE 240 RALEIGH, NC 27613 919-741-7993

CONSTRUCTION SET

CLIENTS NAME:

QUACKENBUSH HOMES

PROJECT NO:

GMD16003RAL SHEET TITLE:

CRAWL SPACE ELEV '2'

PRINT DATE:

10.19.16

A0.3.2

REFER TO STRUCTURAL DRAWINGS FOR INFORMATION NOT SHOWN ON THIS PLAN

FOR ADDITIONAL NOTES SEE GENERAL NOTES ON TITLE SHEET AND DETAILS.

-ALL ELECTRICAL AND MECHANICAL EQUIPMENT AND METERS ARE SUBJECT TO RELOCATION DUE TO FIELD CONDITIONS. CONTRACTOR

VERIEV ALL DOOR THRESHOLD HEIGHTS TO HARD SURFACES

SLOPE ALL STOOPS AND HARDSCAPE MATERIAL AWAY FROM BUILDING - TYPICAL

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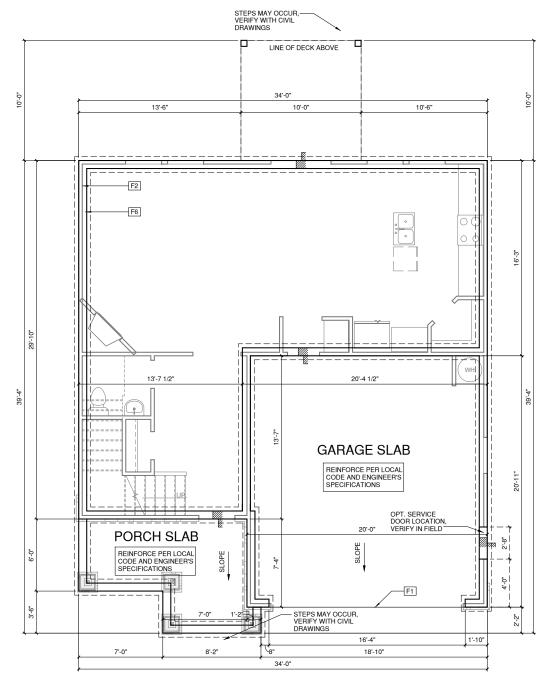
PROVIDE VENTS SPACED AROUND PERIMETER TO PROMOTE CROSS VENTILATION AT A RATE OF 1 SF VENT FOR EVERY 1500 SF OF CRAWL FLOOR AREA. ONE VENT MUST BE LOCATED WITHIN 3'-0" OF EACH CORNER OF THE BUILDING AND LOCATED TO ALLOW FOR CROSS VENTILATION. (PER NCRC SECTION R408.1.1 EXCEPTION.)

PROVIDE AN ACCESS OPENING, MINIMUM SIZE OF 18"X24" FOR CRAWL ACCESS, COORDINATE WITH MECHANICAL CONTRACTOR FOR LARGER SIZE REQUIREMENTS IF MECHANICAL EQUIPMENT IS LOCATED IN CRAWL. (PER NCRC SECTION 408.8)

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CRAWL SPACE ELEV '3'



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PROFESSIONAL SEAL:

PROJECT TITLE:

QUACKENBUSH HOMES LLC 9220 FAIRBANKS DR SUITE 240 RALEIGH, NC 27613 919-741-7993

CONSTRUCTION SET

CLIENTS NAME:

QUACKENBUSH HOMES

PROJECT NO:

GMD16003RAL SHEET TITLE:

CRAWL SPACE ELEV '3'

PRINT DATE: 10.19.16

SHEET NO:

A0.3.3

FOR ADDITIONAL NOTES SEE GENERAL NOTES ON TITLE SHEET AND DETAILS.

PROVIDE FIRERI OCKING (PER NORC SECTION B602.8)

-ALL ELECTRICAL AND MECHANICAL EQUIPMENT AND METERS ARE SUBJECT TO RELOCATION DUE TO FIELD CONDITIONS, CONTRACTOR TO VERIFY.

VERIFY ALL DOOR THRESHOLD HEIGHTS TO HARD S URFACES. 8 1/4" MAX AT INSWING DOORS. (PER NCRC SECTION R311.3.1)

SLOPE ALL STOOPS AND HARDSCAPE MATERIAL AWAY FROM BUILDING - TYPICAL

SLOPE GARAGE FLOOR 1/8" PER FOOT TO GARAGE DOOR OPENING

VERIFY CURB CUT BLOCKOUT WITH GARAGE DOOR MANUFACTURER.

REFER TO CIVIL DRAWINGS FOR FINISH SURFACE ELEVATIONS.

TYP. STOOP AT INSWING/SLIDER DOORS: 36" DEEP BY THE WIDTH OF THE DOOR SERVED,

-SOILS TREATMENT: BORACARE TERMITE TO BE APPLIED TO FRAMING PER PRODUCT SPECIFICATIONS. (PROVIDE CHEMICAL TREATMENT FOR PROTECTION FROM TERMITE INVESTATION ACCORDING TO THE STANDARDS OF THE NCDEPT. OF AGRICULTURE.)

AT VENTED CRAWL SPACE: IPPLY AN APPROVED VAPOR RETARDER OR EQUIVALENT, 6 MIL POLY-VINYL, GROUND COVER OVER FINISH GRADE OR CRAWL SPACE PER NCRC SECTION 408.2


PROVIDE VENTS SPACED AROUND PERIMETER TO PROMOTE CROSS VENTILATION AT A RATE OF 1 SF VENT FOR EVERY 1500 SF OF CRAWL FLOOR AREA. ONE VENT MUST BE LOCATED WITHIN 3-0° OF EACH CORNER OF THE BUILDING AND LOCATED TO ALLOW FOR ROSS VENTILATION. (PER NCRC SECTION R408.1.1 EXCEPTION.)

PROVIDE AN ACCESS OPENING, MINIMUM SIZE OF 18"X24" FOR CRAWL ACCESS, COORDINATE WITH MECHANICAL CONTRACTOR FOR ARGER SIZE REQUIREMENTS IF MECHANICAL EQUIPMENT IS LOCATED IN CRAWL. (PER NCRC SECTION 408.8)

WOOD CONTACTING CONCRETE OR MASONRY OR LESS THAN CODE REQUIRED SEPARATION TO GRADE SHALL BE PRESSURE TREATED OR FOUNDATION GRADE REDWOOD. SET ALL EXTERIOR WALL SILLS IN MASTIC.

REFER TO STRUCTURAL DRAWINGS FOR ALL FOUNDATION DIMENSIONS

FOU	NDATION KEYNOTE LEGEND
F1	LINE OF SLAB ABOVE
F2	LINE OF FRAMED WALL ABOVE
F6	TYPICAL CRAWL FOUNDATION WALL SHALL BE 8" CMU OR A COMBINATION OF 4" CMU WITH NOMINAL 4" BRICK. SEE STRUCTURAL DRAWINGS FOR ALL STRUCTURAL ATTACHMENTS. ALL BLOCK COLLS AND SPACE BETWEEN BLOCK AND BRICK SHALL BE FILLED WITH SOLID CONCRETE. FOUNDATION WALL WITH FULL HEIGHT BRICKVENEER SHALL CONSIST OF 8" CMU WITH NOMINAL 4" BRICK. SEE STRUCTURAL DRAWINGS FOR ALL STRUCTURAL ATTACHMENTS AND BRICK TIE SPACHIOG. FILL VOIDS SOLID TO TOP OF CMU WALL. (MUST COMPLY WITH NCRC SECTION R404, TABLE R404.1.1(1) THROUGH R404.1.1(4) AND APPLICABLE SECTIONS OF R606, R607, R608.) VERIFY WITH STRUCTURAL DRAWINGS FOR WALL FOOTING SIZE AND DEFTH.

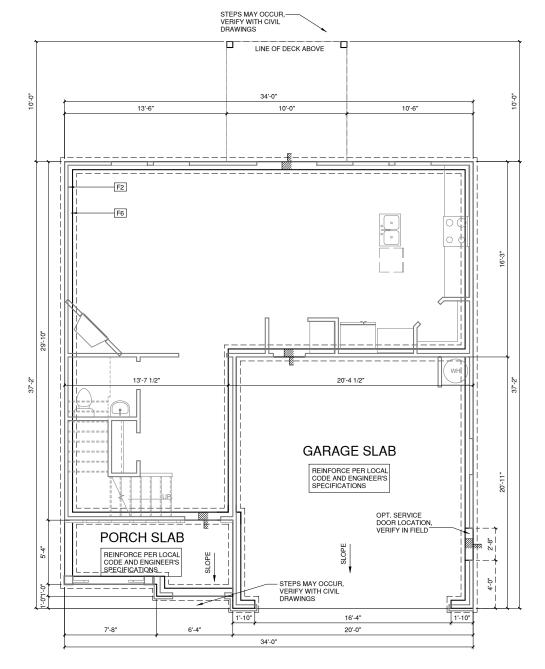

① CRAWL SPACE ELEV '4'

1/4" = 1'-0" AT 22"X34" LAYOUT 1/8" = 1'-0" AT 11" X 17" LAYOUT



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PROFESSIONAL SEAL:

PROJECT TITLE:

QUACKENBUSH HOMES LLC 9220 FAIRBANKS DR SUITE 240 RALEIGH, NC 27613 919-741-7993

CONSTRUCTION SET

CLIENTS NAME:

QUACKENBUSH HOMES

PROJECT NO:

GMD16003RAL SHEET TITLE:


CRAWL SPACE ELEV '4'

PRINT DATE:


10.19.16


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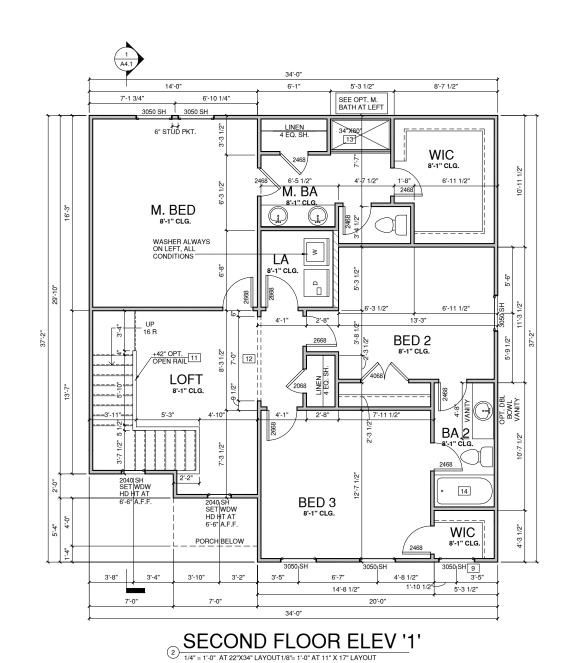
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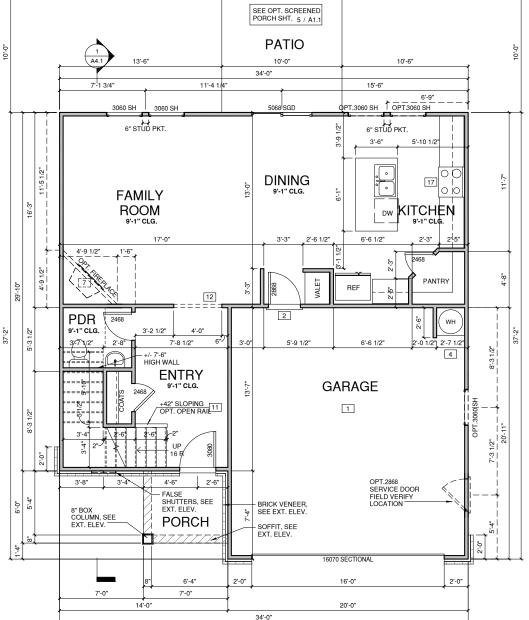




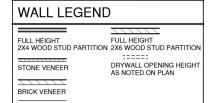



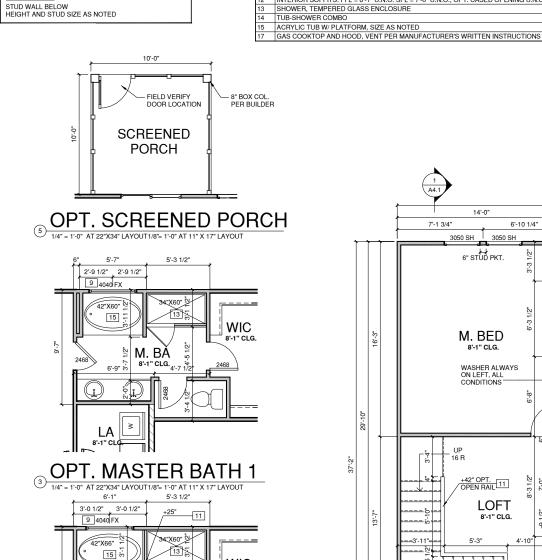

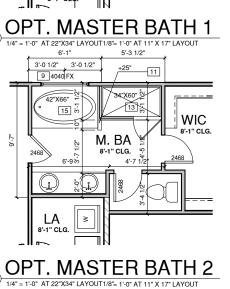

FIRST FLOOR ELEV '1'

1/4" = 1'-0" AT 22"X34" LAYOUT1/8"= 1'-0" AT 11" X 17" LAYOUT



CONSTRUCTION SET

PROJECT NO:

GMD16003RAL SHEET TITLE:

FLOOR PLANS | ELEV '1'

PRINT DATE: 10.19.16

SHEET NO:

A1.1

WALL LEGEND

FULL HEIGHT FULL HEIGHT 2X4 WOOD STUD PARTITION 2X6 WOOD STUD PARTITION

DRYWALL OPENING HEIGHT AS NOTED ON PLAN STONE VENEER

BRICK VENEER

STUD WALL BELOW HEIGHT AND STUD SIZE AS NOTED


FLOOR PLAN KEYNOTE LEGEND

- HOUSE TO GARAGE FIRE SEPARATION, GARAGE/HOUSE SEPARATION AT VERTICAL SURFACES SHALL BE PROTECTED WITH ONE (1) LAYER 1/2" GYPSUM BOARD, GARAGE/HOUSE SEPARATION AT HORIZONTAL SURFACES SHALL BE PROTECTED WITH ONE (1) LAYER 5/8" TYPE "X" GYPSUM BOARD HOUSE TO GARAGE DOOR SEPARATION. PROVIDE 1 3/8" SOLID CORE DOOR OR APPROVED 20 MINUT RATED DOOR

- RATED DOOR

 GAS WATER HEATER ON 18" HIGH PLATFORM

 PRE-FABRICATED METAL FIREPLACE, INSTALL PER MANUFACTURER WRITTEN INSTRUCTIONS
- TEMPERED SAFETY GLASS
- HALF WALL, HEIGHT AS NOTED
- INTERIOR SOFFITS: FFL = 8'-1" U.N.O. SFL = 7'-6" U.N.O., OPT. CASED OPENING U.N.O. SHOWER, TEMPERED GLASS ENCLOSURE
- TUB-SHOWER COMBO
- 15 ACRYLIC TUB W/ PLATFORM, SIZE AS NOTED
- GAS COOKTOP AND HOOD, VENT PER MANUFACTURER'S WRITTEN INSTRUCTIONS

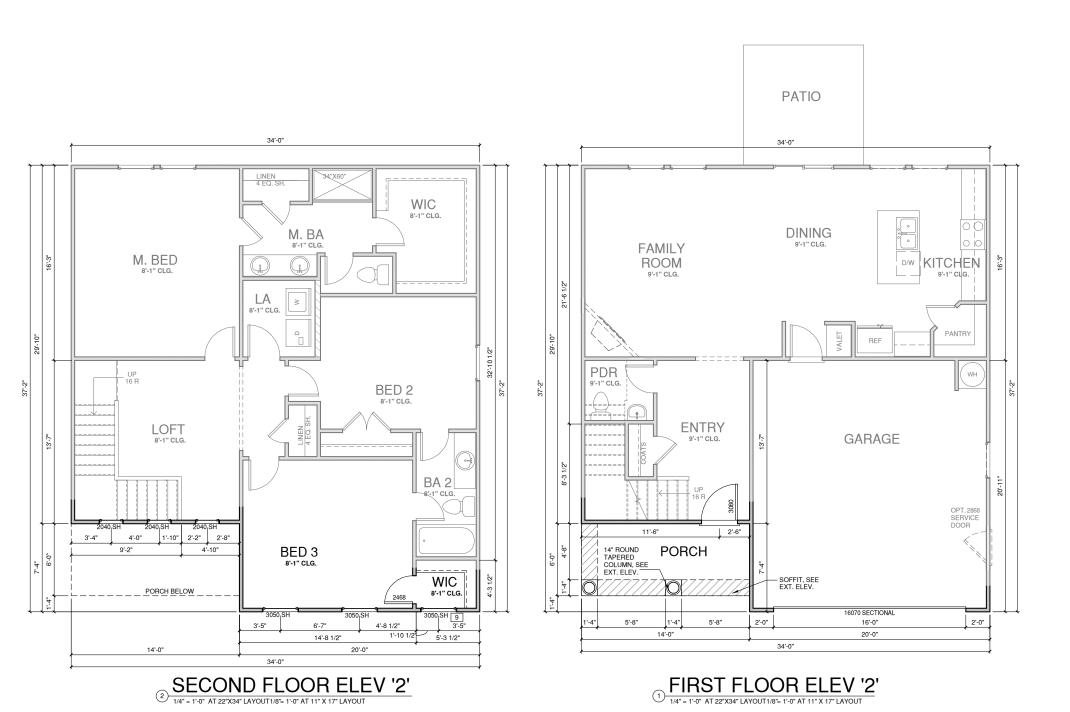



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CONSTRUCTION SET

CLIENTS NAME:

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PROJECT NO:

GMD16003RAL SHEET TITLE:

FLOOR PLANS ELEV '2'

PRINT DATE: 10.19.16

SHEET NO: A1.2

WALL LEGEND


FULL HEIGHT FULL HEIGHT 2X4 WOOD STUD PARTITION 2X6 WOOD STUD PARTITION

DRYWALL OPENING HEIGHT AS NOTED ON PLAN STONE VENEER

BRICK VENEER

STUD WALL BELOW HEIGHT AND STUD SIZE AS NOTED

	FLOOR PLAN KEYNOTE LEGEND
1	HOUSE TO GARAGE FIRE SEPARATION, GARAGE/HOUSE SEPARATION AT VERTICAL SURFACES SHAL BE PROTECTED WITH ONE (1) LAYER 1/2° GYPSUM BOARD. GARAGE/HOUSE SEPARATION AT HORIZONTAL SURFACES SHALL BE PROTECTED WITH ONE (1) LAYER 5/8° TYPE "X" GYPSUM BOARD
2	HOUSE TO GARAGE DOOR SEPARATION. PROVIDE 1 3/8" SOLID CORE DOOR OR APPROVED 20 MINUT RATED DOOR
4	GAS WATER HEATER ON 18" HIGH PLATFORM
7	PRE-FABRICATED METAL FIREPLACE, INSTALL PER MANUFACTURER WRITTEN INSTRUCTIONS
9	TEMPERED SAFETY GLASS
11	HALF WALL, HEIGHT AS NOTED
12	INTERIOR SOFFITS: FFL = 8'-1" U.N.O. SFL = 7'-6" U.N.O., OPT. CASED OPENING U.N.O.
13	SHOWER, TEMPERED GLASS ENCLOSURE
14	TUB-SHOWER COMBO
15	ACRYLIC TUB W/ PLATFORM, SIZE AS NOTED
17	GAS COOKTOP AND HOOD, VENT PER MANUFACTURER'S WRITTEN INSTRUCTIONS

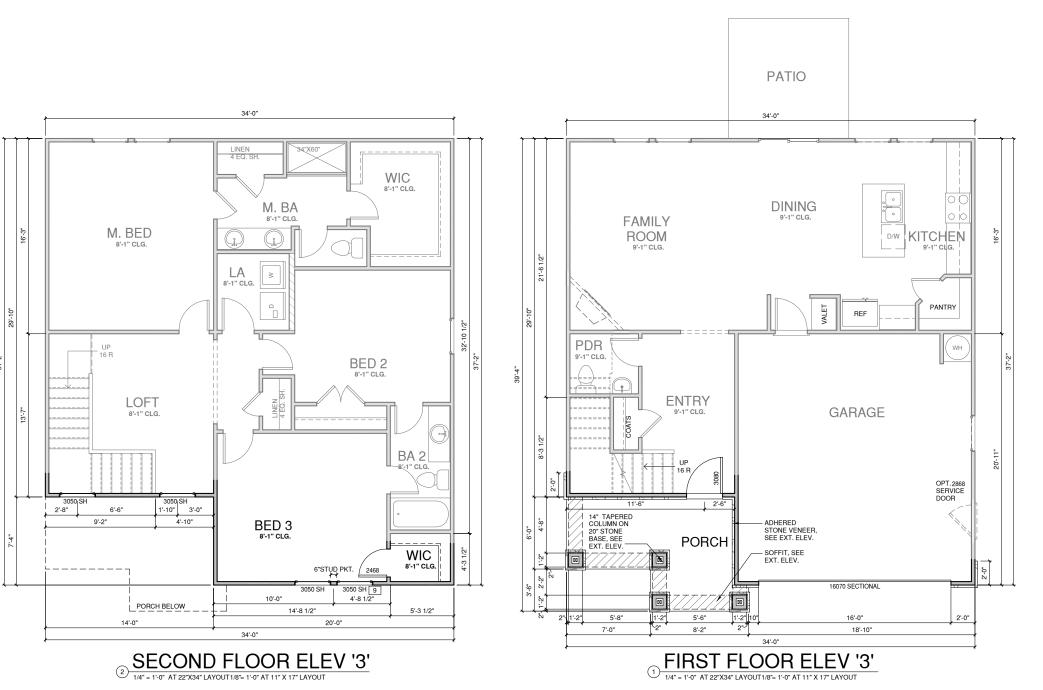



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CONSTRUCTION SET

CLIENTS NAME:

QUACKENBUSH HOMES

PROJECT NO:

GMD16003RAL

SHEET TITLE:

FLOOR PLANS ELEV '3'

PRINT DATE: 10.19.16

SHEET NO:

A1.3

WALL LEGEND

FULL HEIGHT

FULL HEIGHT


2X4 WOOD STUD PARTITION 2X6 WOOD STUD PARTITION

DRYWALL OPENING HEIGHT AS NOTED ON PLAN STONE VENEER

BRICK VENEER

STUD WALL BELOW HEIGHT AND STUD SIZE AS NOTED

FLOOR PLAN KEYNOTE LEGEND HOUSE TO GARAGE FIRE SEPARATION, GARAGE/HOUSE SEPARATION AT VERTICAL SURFACES SHA BE PROTECTED WITH ONE (1) LAYER 1/2" GYPSUM BOARD, GARAGE/HOUSE SEPARATION AT VEHTICAL SURFACES SHALL BE PROTECTED WITH ONE (1) LAYER 1/2" GYPSUM BOARD, GARAGE/HOUSE SEPARATION AT HORIZONTAL SURFACES SHALL BE PROTECTED WITH ONE (1) LAYER 5/8" TYPE "X" GYPSUM BOARD HOUSE TO GARAGE DOOR SEPARATION. PROVIDE 1 3/8" SOLID CORE DOOR OR APPROVED 20 MINUT RATED DOOR GAS WATER HEATER ON 18" HIGH PLATFORM PRE-FABRICATED METAL FIREPLACE, INSTALL PER MANUFACTURER WRITTEN INSTRUCTIONS TEMPERED SAFETY GLASS INTERIOR SOFFITS: FIG. 8-1" U.N.O. SFL = 7-6" U.N.O., OPT. CASED OPENING U.N.O. SHOWER, TEMPERED GLASS ENCLOSURE TUB-SHOWER COMBO ACRYLIC TUB W/ PLATFORM, SIZE AS NOTED GAS COOKTOP AND HOOD, VENT PER MANUFACTURER'S WRITTEN INSTRUCTIONS

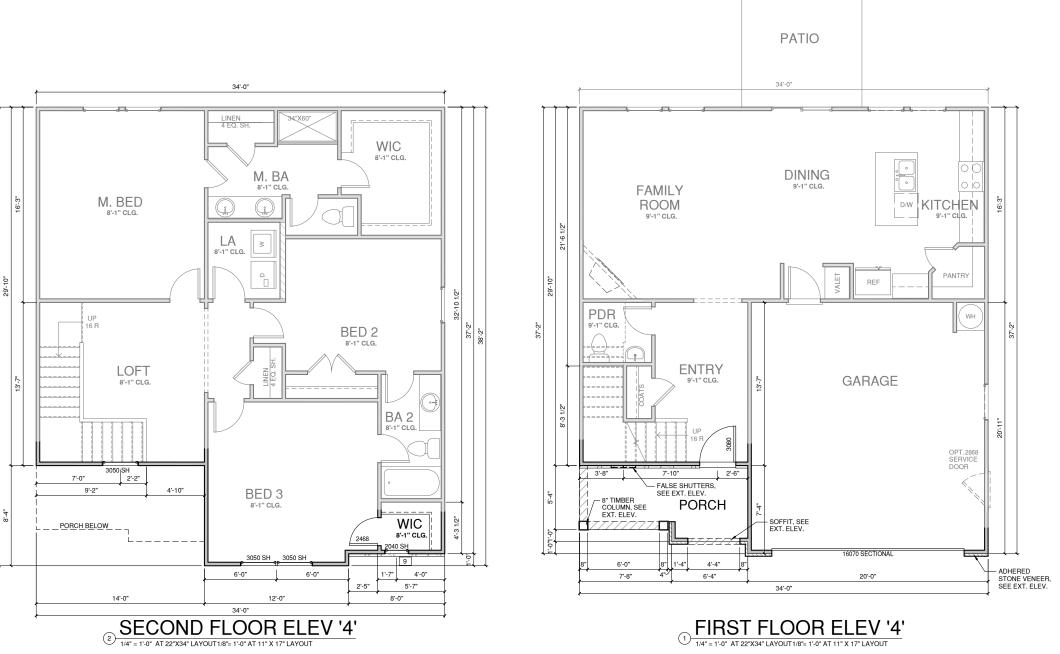



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PROJECT NO: GMD16003RAL


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FLOOR PLANS ELEV '4'

PRINT DATE: 10.19.16

SHEET NO:

A1.4

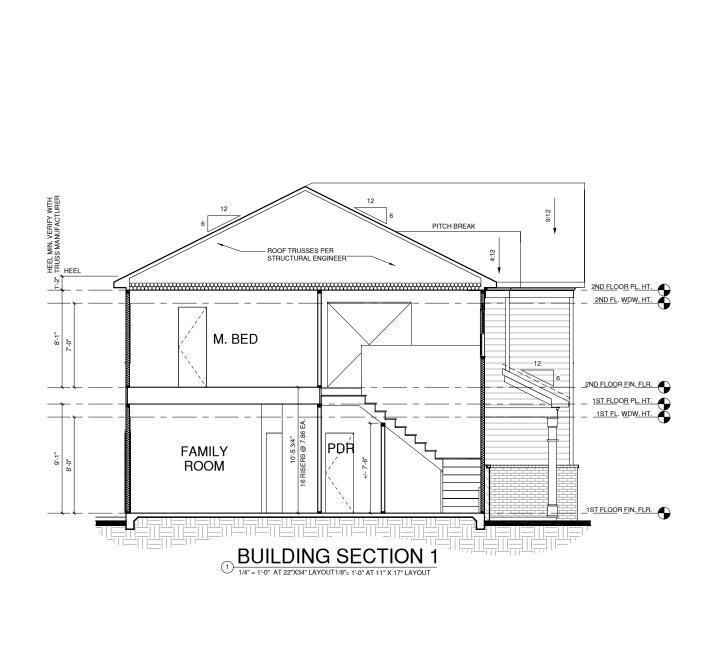

group

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CONSTRUCTION SET

CLIENTS NAME:

QUACKENBUSH HOMES

PROJECT NO:

GMD16003RAL SHEET TITLE:

SECTIONS

PRINT DATE:

10.19.16 SHEET NO:

A4.1

ALL WINDOWS WHOSE OPENING IS LESS THAN 24" ABOVE THE FINISH FLOOR AND WHOSE OPENING IS GREATER THA 72" ABOVE THE OUTSIDE WALKING SURFACE MUST HAVE WINDOW OPENING LIMITING DEVICES COMPLYING WITH T 2012 IRC SECTION R312.2.

NOTES:

-GRADE CONDITIONS MAY VARY FOR INDIVIDUAL SITE FROM THAT SHOWN. BUILDER SHALL VERIFY AND COORDINATE PER ACTUAL SITE CONDITIONS

WINDOW HEAD HEIGHTS: -WINDOW HEAD HEIGHTS: 1ST FLOOR = 8"-0" U.N.O. ON ELEVATIONS 2ND FLOOR = 7"-0" U.N.O. ON ELEVATIONS 3RD FLOOR = 7"-0" U.N.O. ON ELEVATIONS.

ROOFING: PITCHED SHINGLES PER BUILDER.

WINDOWS: MANUFACTURER PER BUILDER. DIVIDED LITES AS SHOWN ON THE EXTERIOR ELEVATIONS

ENTRY DOOR: AS SELECTED BY BUILDER

-CHIMNEY AS OCCURS: TOP OF CHIMNEYS TO BE A MINIMUM OF 24" ABOVE ANY ROOF WITHIN 10'-0" OF CHIMNEY.

ALL EXTERIOR MATERIALS TO BE INSTALLED PER MANUFACTURER'S WRITTEN INSTRUCTIONS. E16 FASCIA HEEL 2ND FLOOR PL. HT. 2ND FL. WDW. HT. 2ND FLOOR FIN. FLR. 1ST FLOOR PL. HT. 1ST FL. WDW. HT. 10" E16 E13

ELEVATION KEYNOTE LEGEND ADHERED STONE VENEER AS SELECTED BY DEVELOPER, HEIGHT AS NOTED

CORROSION RESISTANT ROOF TO WALL FLASHING, CODE COMPLIANT FLASHING MUST BE INSTALLED AT ALL ROOF/WALL INTERSECTIONS

FIBER CEMENT PANEL SIDING W/ 1X3 BATTS AT 12" O.C. (VINYL BOARD AND BATTEN

OPT. STANDING SEAM METAL ROOF, INSTALL PER MANUFACTURER'S WRITTEN INSTRUCTIONS 12 FIBER CEMENT SHAKE SIDING PER DEVELOPER W/ 5/4x4 CORNER TRIM BOARDS

13 FIBER CEMENT LAP SIDING PER DEVELOPER W/ 5/4x4 CORNER TRIM BOARDS

| SIDING) | E16 | 1X FIBER CEMENT TRIM OR EQUAL, U.N.O. SIZE AS NOTED E16 IT FIBER CEMENT I THIM OF EQUAL, U.N.O. SIZE AS NOTED E17 FALSE WOOD/VINYL SHUTTERS, TYPE AS SHOWN, SIZE AS NOTED E18 PROVIDE GUARDRAIL PER NCRC SECTION R312

MASONRY FULL BRICK AS SELECTED BY DEVELOPER, HEIGHT AS NOTED

ROWLOCK COURSE

3 LEFT ELEVATION '1' FASCIA E16 2ND FLOOR PL. HT. _2N<u>D FL. W</u>D<u>W</u>. H<u>T.</u> 2ND FLOOR FIN. FLR. 1ST FLOOR PL. HT. _1ST FL. WDW. HT. -OPT. WINDOW E13 OPT. SERVICE DOOR 1ST FLOOR FIN. FLR.

1ST FLOOR FIN. FLR.



FRONT ELEVATION '1' 1/4" = 1'-0" AT 22"X34" LAYOUT1/8"= 1'-0" AT 11" X 17" LAYOUT

WINDOW AT OPT. M. BATH FASCIA E16 12ND FLOOR PL. HT. 2ND FL. WDW. HT. 2ND FLOOR FIN. FLR. 1ST FLOOR PL. HT. _ 1<u>ST FL. WDW</u>. <u>HT.</u> 1ST FLOOR FIN. FLR.

② REAR ELEVATION '1'

1/4" = 1'-0" AT 22"X34" LAYOUT 1/8" = 1'-0" AT 11" X 17" LAYOUT



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CONSTRUCTION SET

CLIENTS NAME:

QUACKENBUSH HOMES

PROJECT NO:

GMD16003RAL SHEET TITLE:

ELEVATIONS

PRINT DATE: 10.19.16

SHEET NO: **A5.1**

RIGHT ELEVATION '1'

ALL WINDOWS WHOSE OPENING IS LESS THAN 24" ABOVE THE FINISH FLOOR AND WHOSE OPENING IS GREATER THA 72" ABOVE THE OUTSIDE WALKING SURFACE MUST HAVE VINDOW OPENING LIMITING DEVICES COMPLYING WITH T 1012 IRC SECTION R312.2.

-GRADE CONDITIONS MAY VARY FOR INDIVIDUAL SITE FROM THAT SHOWN BUILDER SHALL VERIFY AND COORDINATE PER ACTUAL SITE CONDITIONS

-WINDOW HEAD HEIGHTS: 1ST FLOOR = 8'-0" U.N.O. ON ELEVATIONS 2ND FLOOR = 7'-0" U.N.O. ON ELEVATIONS 3RD FLOOR = 7'-0" U.N.O. ON ELEVATIONS.

ROOFING: PITCHED SHINGLES PER BUILDER.

-WINDOWS: MANUFACTURER PER BUILDER. DIVIDED LITES AS SHOWN ON THE EXTERIOR ELEVATIONS

-ENTRY DOOR: AS SELECTED BY BUILDER

-CHIMNEY AS OCCURS: TOP OF CHIMNEYS TO BE A MINIMUM OF 24" ABOVE

-ALL EXTERIOR MATERIALS TO BE INSTALLED PER MANUFACTURER'S WRITTEN INSTRUCTIONS.

ELEVATION KEYNOTE LEGEND


- ADHERED STONE VENEER AS SELECTED BY DEVELOPER, HEIGHT AS NOTED
- MASONRY FULL BRICK AS SELECTED BY DEVELOPER, HEIGHT AS NOTED
- CORROSION RESISTANT ROOF TO WALL FLASHING, CODE COMPLIANT FLASHING MUST BE INSTALLED AT ALL ROOF/WALL INTERSECTIONS
- OPT. STANDING SEAM METAL ROOF, INSTALL PER MANUFACTURER'S WRITTEN INSTRUCTIONS
- INSTRUCTIONS

 112 FIBER CEMENT SHAKE SIDING PER DEVELOPER W/ 5/4x4 CORNER TRIM BOARDS

 113 FIBER CEMENT LAP SIDING PER DEVELOPER W/ 5/4x4 CORNER TRIM BOARDS
- FIBER CEMENT PANEL SIDING W/ 1X3 BATTS AT 12" O.C. (VINYL BOARD AND BATTEN
- SIDING)
 E16 1X FIBER CEMENT TRIM OR EQUAL, U.N.O. SIZE AS NOTED
- E16 IT FIBER CEMENT I THIM OF EQUAL, U.N.O. SIZE AS NOTED E17 FALSE WOOD/VINYL SHUTTERS, TYPE AS SHOWN, SIZE AS NOTED E18 PROVIDE GUARDRAIL PER NCRC SECTION R312



REAR ELEVATION OPT. SCREENED PORCH

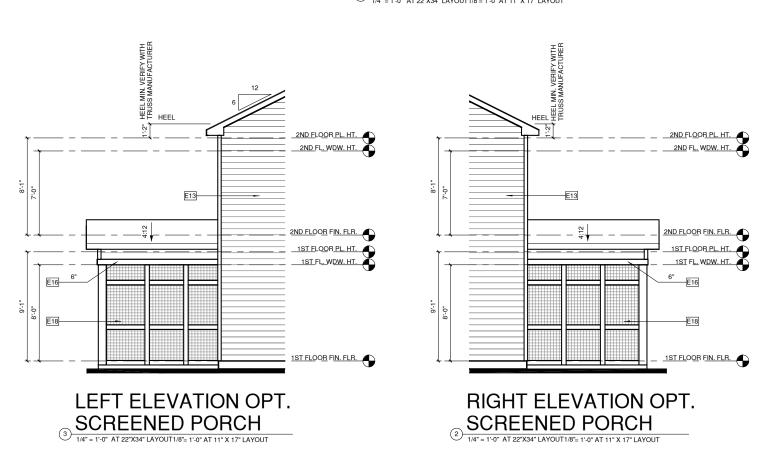



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CONSTRUCTION SET

CLIENTS NAME:

QUACKENBUSH HOMES

PROJECT NO:

GMD16003RAI SHEET TITLE:

ELEVATION OPTIONS

PRINT DATE: 10.19.16

SHEET NO:

A5.1.1

1/150 RATIO:

GENERAL CONTRACTOR SHALL VERIFY THE
NET FREE VENTILATION OF THE VENT PRODUCT
SELECTED BY OWNER. VERIFY WITH
MANUFACTURER OF HIGH AND LOW VENTS TO
BE USED FOR MINIMUM CALCULATED VENTS REQUIRED. THE REQUIRED VENTILATION SHALL BE MAINTAINED. PROVIDE INSULATION STOP SUCH THAT INSULATION DOES NOT OBSTRUCT FREE AIR MOVEMENT AS REQUIRED BY THE BUILDING OFFICIAL.

ALL OVERLAP FRAMED ROOF AREAS SHALL HAVE OPENINGS BETWEEN THE ADJACENT ATTICS IN THE ROOF SHEATHING (AS ALLOWED BY THE STRUCTURAL ENGINEER) TO ALLOW PASSAGE AND ATTIC VENTILATION BETWEEN THE TWO OR ISOLATED ATTIC SPACES SHALL BE VENTED INDEPENDENTLY TO CBC REQUIREMENTS.

PER DEVELOPER, AT ALL CANTILEVERED FLOORS, CANTILEVERED ARCHITECTURAL POP-OUTS, AND ANY DOUBLE FRAMING PROJECTIONS THAT ARE SEPARATED FROM THE VENTING CALCULATIONS SHOWN ABOVE, PROVIDE A CONTINUOUS 2" CORROSION RESISTANT SOFFIT VENT AT UNDERSIDE OF FRAMED ELEMENT.

1/300 RATIO:

AS AN ALTERNATE TO THE 1/150 RATIO LISTED, THE NET FREE CROSS-VENTILATION AREA MAY BE REDUCED TO 1/300 WHEN A VAPOR BARRIER IS HAVING A TRANSMISSION RATE NOT EXCEEDING I-PERM INSTALLED ON THE WARM-IN-WINTER SIDE OF THE CEILING.

GENERAL CONTRACTOR SHALL VERIFY THE NET FREE GENERAL CONTRACTOR SHALL VERIFY THE NET FREE VENTILATION OF THE VENT PRODUCT SELECTED BY OWNER. VERIFY WITH MANUFACTURER OF HIGH AND LOW VENTS TO BE USED FOR MINIMUM CALCULATED VENTS REQUIRED. THE REQUIRED VENTILATION SHALL BE MAINTAINED. PROVIDE INSULATION STOP SUCH THAT INSULATION DOES NOT OBSTRUCT FREE AIR MOVEMENT AS REQUIRED BY THE BUILDING OFFICIAL.


ALL OVERLAP FRAMED ROOF AREAS SHALL HAVE OPENINGS BETWEEN THE ADJACENT ATTICS IN THE ROOF SHEATHING (AS ALLOWED BY THE STRUCTURAL ENGINEER) TO ALLOW PASSAGE AND ATTIC VENTILATION BETWEEN THE TWO OR ISOLATED ATTIC SPACES SHALL BE VENTED INDEPENDENTLY TO CBC REQUIREMENTS.

PER DEVELOPER, AT ALL CANTILEVERED FLOORS, CANTILEVERED ARCHITECTURAL POP-OUTS, AND ANY DOUBLE FRAMING PROJECTIONS THAT ARE SEPARATED FROM THE VENTING CALCULATIONS SHOWN ABOVE, PROVIDE A CONTINGUOLS 2" CORROSION RESISTANT SOFFIT VENT AT UNDERSIDE OF FRAMED ELEMENT.

NOTES:

- ALL ROOF DRAINAGE SHALL BE PIPED TO STREET OR APPROVED DRAINAGE FACILITY.
 DASHED LINES INDICATE WALL BELOW.
 LOCATE GUTTER AND DOWNSPOUTS PER
- BUILDER.
 PITCHED ROOFS AS NOTED.
- TRUSS MANUFACTURER SHALL SUBMIT STRUCTURAL CALCS AN SHOP DRAWING TO THE BUILDER'S GENERAL CONTRACTOR AND BUILDING DEPARTMENT FOR REVIEW PRIOR TO FABRICATIONS. ALL PLUMBING VENTS SHALL BE COMBINED INTO A MINIMUM AMOUNT OF ROOF PENETRATIONS. ALL ROOF PENETRATIONS SHALL OCCUR TO THE REAR OF THE MAIN RIDGE.

ROOF VENT CALC. ELEV. '1'			
Name	Area	1/300 RATIO AT HIGH & LOW	1/150 RATIO AT HIGH & LOW
AREA 1	1175 SF	282.00 in ²	564.00 in ²
AREA 2	28 SF	6.72 in ²	13.44 in ²

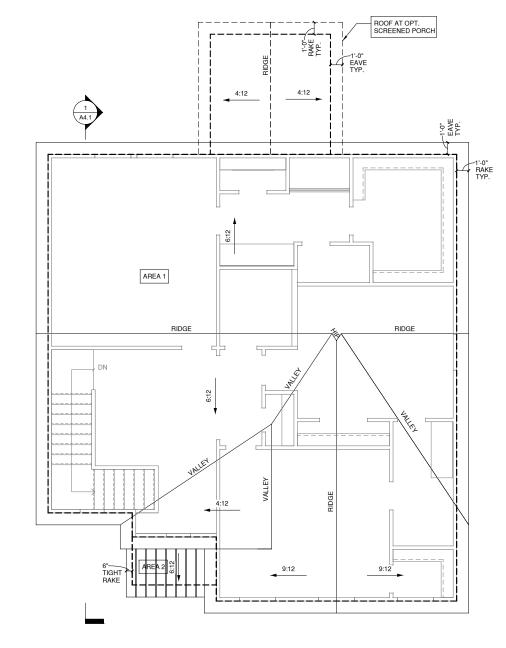

ROOF PLAN '1' 1/4" = 1'-0" AT 22"X34" LAYOUT1/8"= 1'-0" AT 11" X 17" LAYOUT group

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CONSTRUCTION SET

CLIENTS NAME:

QUACKENBUSH HOMES

PROJECT NO:

GMD16003RAL SHEET TITLE:

ROOF PLAN '1'

PRINT DATE:

10.19.16

SHEET NO:

A5.1.2

ALL WINDOWS WHOSE OPENING IS LESS THAN 24" ABOVE THE FINISH FLOOR AND WHOSE OPENING IS GREATER THAY 72" ABOVE THE OUTSIDE WALKING SURFACE MUST HAVE WINDOW OPENING LIMITING DEVICES COMPLYING WITH THE 2012 IRC SECTION R312.2.

NOTES:

-GRADE CONDITIONS MAY VARY FOR INDIVIDUAL SITE FROM THAT SHOWN. BUILDER SHALL VERIFY AND COORDINATE PER ACTUAL SITE CONDITIONS

-WINDOW HEAD HEIGHTS: 1ST FLOOR = 8'-0" U.N.O. ON ELEVATIONS 2ND FLOOR = 7'-0" U.N.O. ON ELEVATIONS 3RD FLOOR = 7'-0" U.N.O. ON ELEVATIONS.


ROOFING: PITCHED SHINGLES PER BUILDER.


-WINDOWS: MANUFACTURER PER BUILDER. DIVIDED LITES AS SHOWN ON THE EXTERIOR ELEVATIONS

-ENTRY DOOR: AS SELECTED BY BUILDER


-CHIMNEY AS OCCURS: TOP OF CHIMNEYS TO BE A MINIMUM OF 24" ABOVE ANY ROOF WITHIN 10'-0" OF CHIMNEY.

-ALL EXTERIOR MATERIALS TO BE INSTALLED PER MANUFACTURER'S WRITTEN INSTRUCTIONS.

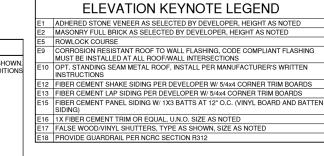

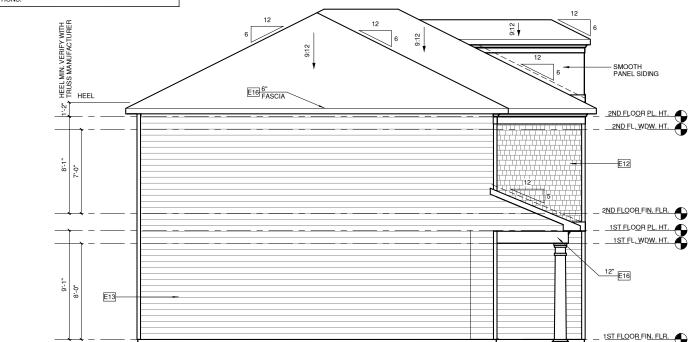



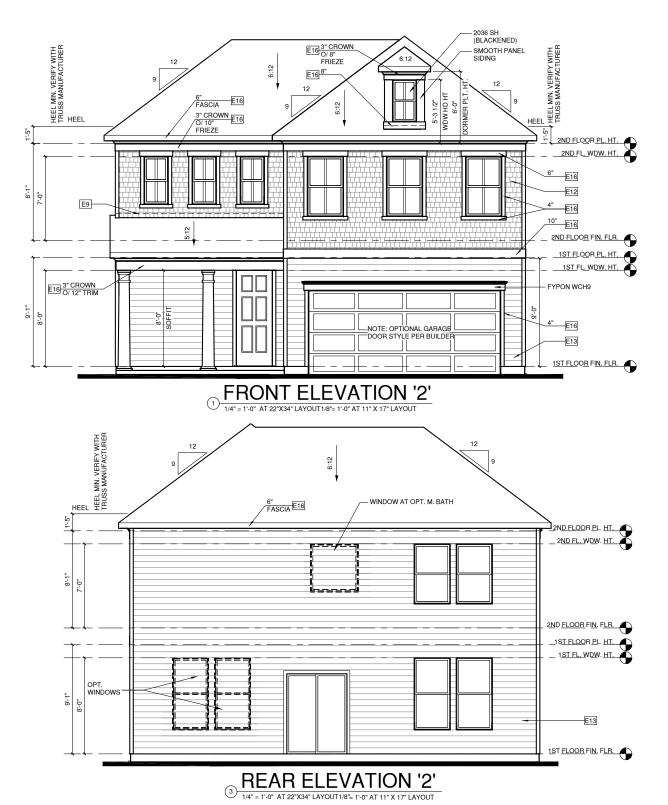

group

NORTH CAROLINA OFFICE 102 FOUNTAIN BROOK CIRCLE SUITE C CARY, NC 27511 PHONE: (919) 320-3022

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NO: DATE: REVISION:

PROJECT TITLE:

PROFESSIONAL SEAL:

QUACKENBUSH HOMES LLC 9220 FAIRBANKS DR SUITE 240 RALEIGH, NC 27613 919-741-7993

CONSTRUCTION SET

CLIENTS NAME:

QUACKENBUSH HOMES

PROJECT NO: GMD16003RAL

SHEET TITLE:

ELEVATIONS '2'

PRINT DATE: 10.19.16

SHEET NO:

A5.2

1/150 RATIO:

GENERAL CONTRACTOR SHALL VERIFY THE NET FREE VENTILATION OF THE VENT PRODUCT SELECTED BY OWNER. VERIFY WITH MANUFACTURER OF HIGH AND LOW VENTS TO MANUFACTURER OF HIGH AND LOW VENTS TO BE USED FOR MINIMUM CALCULATED VENTS REQUIRED. THE REQUIRED VENTILATION SHALL BE MAINTAINED. PROVIDE INSULATION STOP SUCH THAT INSULATION DOES NOT OBSTRUCT FREE AIR MOVEMENT AS REQUIRED BY THE PUBLISHING OFFICIAL OF THE PROVINCE OF THE PROVIN BUILDING OFFICIAL.

ALL OVERLAP FRAMED ROOF AREAS SHALL HAVE OPENINGS BETWEEN THE ADJACENT ATTICS IN THE ROOF SHEATHING (AS ALLOWED BY THE STRUCTURAL ENGINEER) TO ALLOW PASSAGE AND ATTIC VENTILATION BETWEEN THE TWO OR ISOLATED ATTIC SPACES SHALL BE VENTED INDEPENDENTLY TO CBC REQUIREMENTS.

PER DEVELOPER, AT ALL CANTILEVERED FLOORS, CANTILEVERED ARCHITECTURAL POPOUTS, AND ANY DOUBLE FRAMING PROJECTIONS THAT ARE SEPARATED FROM THE VENTING CALCULATIONS SHOWN ABOVE, PROVIDE A CONTINUOUS 2" CORROSION RESISTANT SOFFIT VENT AT UNDERSIDE OF FRAMED ELEMENT.

1/300 RATIO:

AS AN ALTERNATE TO THE 1/150 RATIO LISTED, THE NET FREE CROSS-VENTILATION AREA MAY BE REDUCED TO 1/300 WHEN A VAPOR BARRIER IS HAVING A TRANSMISSION RATE NOT EXCEEDING I-PERM INSTALLED ON THE WARM-IN-WINTER SIDE OF THE CEILING.

GENERAL CONTRACTOR SHALL VERIFY THE NET FREE VENTILATION OF THE VENT PRODUCT SELECTED BY OWNER. VERIFY WITH MANUFACTURER OF HIGH AND LOW VENTS TO BE USED FOR MINIMUM CALCULATED VENTS REQUIRED. THE REQUIRED VENTILATION SHALL BE MAINTAINED. PROVIDE INSULATION STOP SUCH THAT INSULATION DOES NOT OBSTRUCT FREE AIR MOVEMENT AS REQUIRED BY THE BUILD DING GETCIAL


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NOTES:

- ALL ROOF DRAINAGE SHALL BE PIPED TO STREET OR APPROVED DRAINAGE FACILITY.
 DASHED LINES INDICATE WALL BELOW.
 LOCATE GUTTER AND DOWNSPOUTS PER
 DEW STEEL STREET
- BUILDER. PITCHED ROOFS AS NOTED.
- TRUSS MANUFACTURER SHALL SUBMIT STRUCTURAL CALCS AN SHOP DRAWING TO THE BUILDER'S GENERAL CONTRACTOR AND BUILDING DEPARTHENT FOR REVIEW PRIOR TO FABRICATIONS.
 ALL PLUMBING VENTS SHALL BE COMBINED INTO A MINIMUM AMOUNT OF ROOP PENETRATIONS. ALL ROOF PENETRATIONS SHALL OCCUR TO THE REAR OF THE MAIN RIDGE.

ROOF VENT CALC. ELEV. '2'			.EV. '2'
Name	Area	1/300 RATIO AT HIGH & LOW	1/150 RATIO AT HIGH & LOW
AREA 1	1161 SF	278.64 in ²	557.28 in ²
AREA 2	84 SF	20.16 in ²	40.32 in ²



① ROOF PLAN '2'

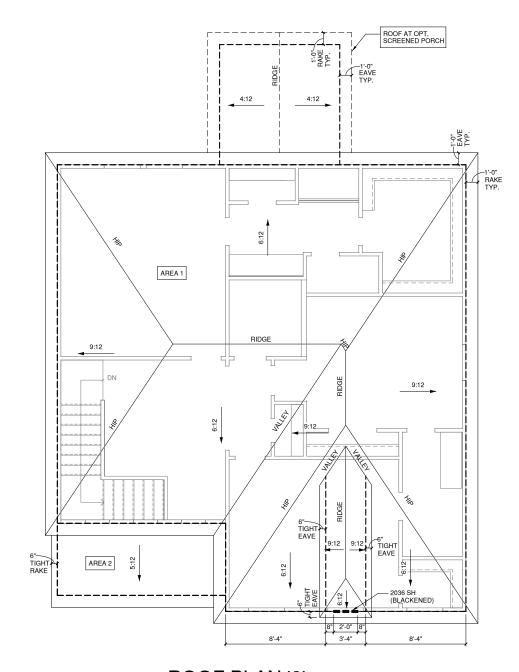1/4" = 1'-0" AT 22"X34" LAYOUT 1/8" = 1'-0" AT 11" X 17" LAYOUT

group

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NO:	DATE:	REVISION:

PROFESSIONAL SEAL:

PROJECT TITLE:

QUACKENBUSH HOMES LLC 9220 FAIRBANKS DR SUITE 240 RALEIGH, NC 27613 919-741-7993

CONSTRUCTION SET

CLIENTS NAME:

QUACKENBUSH HOMES

PROJECT NO:


GMD16003RAL SHEET TITLE:

ROOF PLAN '2'

PRINT DATE:

10.19.16

SHEET NO: A5.2.1

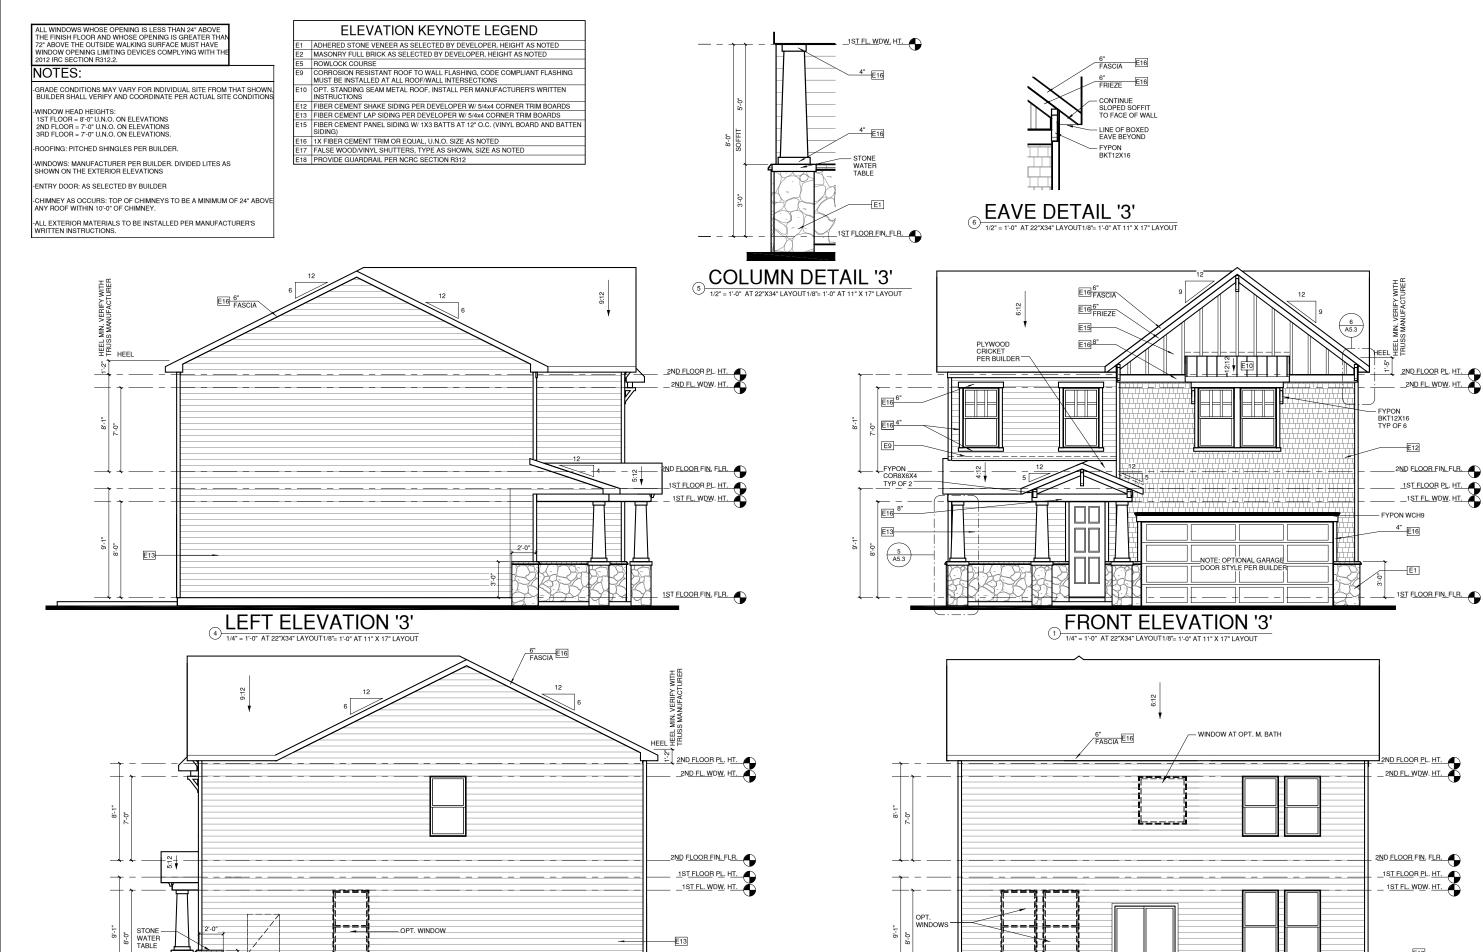

1ST FLOOR FIN. FLR.

gma design se group group

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NO: DATE: REVISION:

PROFESSIONAL SEAL:

PROJECT TITLE:

QUACKENBUSH HOMES LLC 9220 FAIRBANKS DR SUITE 240 RALEIGH, NC 27613 919-741-7993

CONSTRUCTION SET

CLIENTS NAME:

QUACKENBUSH HOMES

PROJECT NO:

GMD16003RAI

ELEVATIONS '3'

PRINT DATE: 10.19.16

SHEET NO:

1ST FLOOR FIN. FLR.

A5.3

RIGHT ELEVATION '3'

1/4" = 1'-0" AT 22"X34" LAYOUT1/8" = 1'-0" AT 11" X 17" LAYOUT

OPT. SERVICE DOOR

E1 -

REAR ELEVATION '3'

1/4" = 1'-0" AT 22"X34" LAYOUT1/8" = 1'-0" AT 11" X 17" LAYOUT

1/150 RATIO:

GENERAL CONTRACTOR.

GENERAL CONTRACTOR SHALL VERIFY THE NET FREE VENTILATION OF THE VENT PRODUCT SELECTED BY OWNER. VERIFY WITH MANUFACTURER OF HIGH AND LOW VENTS TO BE USED FOR MINIMUM CALCULATED VENTS REQUIRED. THE REQUIRED VENTILATION SHALL BE MAINTAINED. PROVIDE INSULATION STOP SUCH THAT INSULATION DOES NOT OBSTRUCT FREE AIR MOYEMENT AS REQUIRED BY THE BUILDING OFFICIAL.

ALL OVERLAP FRAMED ROOF AREAS SHALL HAVE OPENINGS BETWEEN THE ADJACENT ATTICS IN THE ROOF SHEATHING (AS ALLOWED BY THE STRUCTURAL ENGINEER) TO ALLOW PASSAGE AND ATTIC VENTILATION BETWEEN THE TWO OR ISOLATED ATTIC SPACES SHALL BE VENTED INDEPENDENTLY TO CBC REQUIREMENTS.

PER DEVELOPER, AT ALL CANTILEVERED FLOORS, CANTILEVERED ARCHITECTURAL POPOUTS, AND ANY DOUBLE FRAMING PROJECTIONS THAT ARE SEPARATED FROM THE VENTING CALCULATIONS SHOWN ABOVE, PROVIDE A CONTINUOUS 2" CORROSION RESISTANT SOFFIT VENT AT UNDERSIDE OF FRAMED ELEMENT.

1/300 RATIO:

AS AN ALTERNATE TO THE 1/150 RATIO LISTED, THE NET FREE CROSS-VENTILATION AREA MAY BE REDUCED TO 1/300 WHEN A VAPOR BARRIER IS HAVING A TRANSMISSION RATE NOT EXCEEDING I-PERM INSTALLED ON THE WARM-IN-WINTER SIDE OF THE CEILING.

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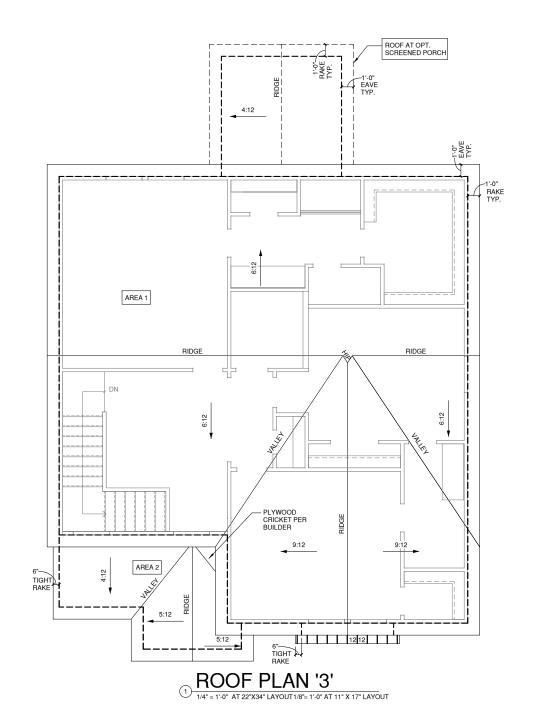
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NOTES:

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 DASHED LINES INDICATE WALL BELOW.
 LOCATE GUTTER AND DOWNSPOUTS PER
- BUILDER. PITCHED ROOFS AS NOTED.
- TRUSS MANUFACTURER SHALL SUBMIT STRUCTURAL CALCS AN SHOP DRAWING TO THE BUILDER'S GENERAL CONTRACTOR AND BUILDING DEPARTMENT FOR REVIEW PRIOR TO FABRICATIONS. ALL PLUMBING VENTS SHALL BE COMBINED INTO A MINIMUM AMOUNT OF ROOF PENETRATIONS, ALL ROOF PENETRATIONS SHALL OCCUR TO THE REAR OF THE MAIN RIDGE.

	ROOF VENT CALC. ELEV. '3'			
Name	Area	1/300 RATIO AT HIGH & LOW	1/150 RATIO AT HIGH & LOW	
AREA 1	1161 SF	278.64 in ²	557.28 in ²	
AREA 2	111 SF	26.60 in ²	53.21 in ²	



group

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NO:	DATE:	REVISION:

PROFESSIONAL SEAL:

PROJECT TITLE:

QUACKENBUSH HOMES LLC 9220 FAIRBANKS DR SUITE 240 RALEIGH, NC 27613 919-741-7993

CONSTRUCTION SET

CLIENTS NAME:

QUACKENBUSH HOMES

PROJECT NO:

GMD16003RAL

SHEET TITLE:

ROOF PLAN '3'

PRINT DATE:

10.19.16

SHEET NO: A5.3.1 ALL WINDOWS WHOSE OPENING IS LESS THAN 24" ABOVE THE FINISH FLOOR AND WHOSE OPENING IS GREATER THA 72" ABOVE THE OUTSIDE WALKING SURFACE MUST HAVE WINDOW OPENING LIMITING DEVICES COMPLYING WITH TH 2012 IRC SECTION R312.2.

NOTES:

-GRADE CONDITIONS MAY VARY FOR INDIVIDUAL SITE FROM THAT SHOWN, BUILDER SHALL VERIFY AND COORDINATE PER ACTUAL SITE CONDITIONS

-WINDOW HEAD HEIGHTS: 1ST FLOOR = 8'-0" U.N.O. ON ELEVATIONS 2ND FLOOR = 7'-0" U.N.O. ON ELEVATIONS 3RD FLOOR = 7'-0" U.N.O. ON ELEVATIONS.

ROOFING: PITCHED SHINGLES PER BUILDER.

WINDOWS: MANUFACTURER PER BUILDER. DIVIDED LITES AS SHOWN ON THE EXTERIOR ELEVATIONS


ENTRY DOOR: AS SELECTED BY BUILDER


CHIMNEY AS OCCURS: TOP OF CHIMNEYS TO BE A MINIMUM OF 24" ABOVE ANY ROOF WITHIN 10'-0" OF CHIMNEY.

-ALL EXTERIOR MATERIALS TO BE INSTALLED PER MANUFACTURER'S WRITTEN INSTRUCTIONS.


	ELEVATION KEYNOTE LEGEND
	ADHERED STONE VENEER AS SELECTED BY DEVELOPER, HEIGHT AS NOTED
2	MASONRY FULL BRICK AS SELECTED BY DEVELOPER, HEIGHT AS NOTED

- ROWLOCK COURSE
 CORROSION RESISTANT ROOF TO WALL FLASHING, CODE COMPLIANT FLASHING
 MUST BE INSTALLED AT ALL ROOF/WALL INTERSECTIONS
- OPT. STANDING SEAM METAL ROOF, INSTALL PER MANUFACTURER'S WRITTEN INSTRUCTIONS 2 FIBER CEMENT SHAKE SIDING PER DEVELOPER W/ 5/4x4 CORNER TRIM BOARDS
- E13 FIBER CEMENT LAP SIDING PER DEVELOPER W/ 5/4x4 CORNER TRIM BOARDS
 E15 FIBER CEMENT PANEL SIDING W/ 1X3 BATTS AT 12* O.C. (VINYL BOARD AND BATTEN SIDING)
- E16 14 FIBER CEMENT TRIM OR EQUAL, U.N.O. SIZE AS NOTED E17 FALSE WOOD/VINYL SHUTTERS, TYPE AS SHOWN, SIZE AS NOTED
- E18 PROVIDE GUARDRAIL PER NCRC SECTION R312

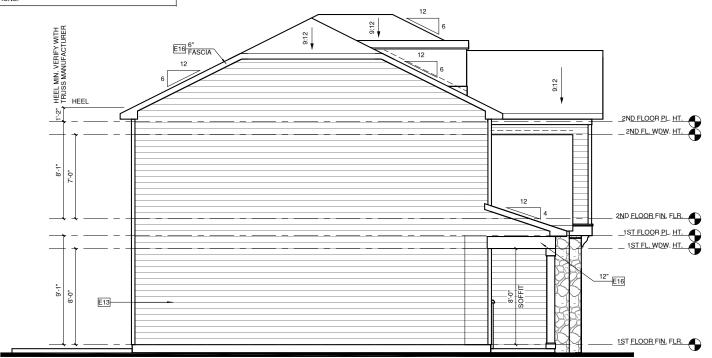

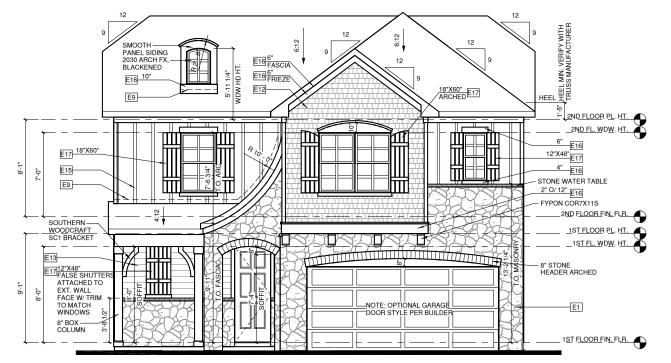

LEFT ELEVATION '4' 3 1/4" = 1'-0" AT 22"X34" LAYOUT 1/8"= 1'-0" AT 11" X 17" LAYOUT FASCIA E16 2ND FLOOR PL. HT. 2ND FL. WDW. HT. 2ND FLOOR FIN. FLR. 1ST FLOOR PL. HT. _1ST FL. WDW. HT. -OPT. WINDOW E13 OPT. SERVICE DOOR 1ST FLOOR FIN. FLR.

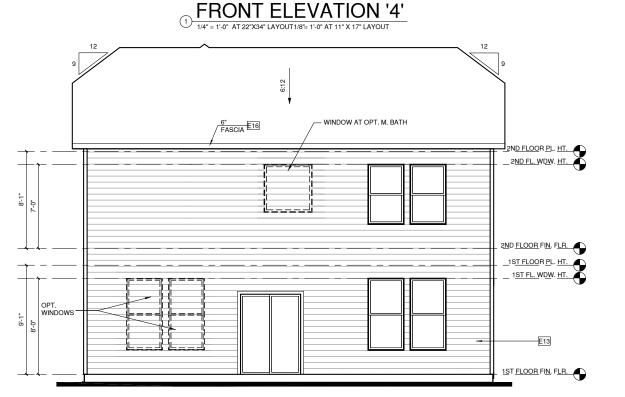

RIGHT ELEVATION '4'

REAR ELEVATION '4'



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PROJECT TITLE:

QUACKENBUSH HOMES LLC 9220 FAIRBANKS DR SUITE 240 RALEIGH, NC 27613 919-741-7993

CONSTRUCTION SET

CLIENTS NAME:

QUACKENBUSH HOMES

PROJECT NO:

GMD16003RAL SHEET TITLE:

ELEVATIONS '4'

PRINT DATE: 10.19.16

SHEET NO:

A5.4

1/150 RATIO:

GENERAL CONTRACTOR SHALL VERIFY THE NET FREE VENTILATION OF THE VENT PRODUCT SELECTED BY OWNER. VERIFY WITH MANUFACTURER OF HIGH AND LOW VENTS TO MANUFACTURER OF HIGH AND LOW VEHISTO
BE USED FOR MINIMUM CALCULATED VENTS
REQUIRED. THE REQUIRED VENTILATION SHALL
BE MAINTAINED. PROVIDE INSULATION STOP
SUCH THAT INSULATION DOES NOT OBSTRUCT
FREE AIR MOVEMENT AS REQUIRED BY THE BUILDING OFFICIAL.

ALL OVERLAP FRAMED ROOF AREAS SHALL ALL OVERLAP FRAMED ROOF AREAS SHALL HAVE OPENINGS BETWEEN THE ADJACENT ATTICS IN THE ROOF SHEATHING (AS ALLOWED BY THE STRUCTURAL ENGINEER) TO ALLOW PASSAGE AND ATTIC VENTILATION BETWEEN THE TWO OR ISOLATED ATTIC SPACES SHALL BE VENTED INDEPENDENTLY TO CBC BEGUIREMENTS. REQUIREMENTS.

PER DEVELOPER, AT ALL CANTILEVERED FLOORS, CANTILEVERED ARCHITECTURAL POP-OUTS, AND ANY DOUBLE FRAMING OUTS, AND ANY DOUBLE FRAMING
PROJECTIONS THAT ARE SEPARATED FROM
THE VENTING CALCULATIONS SHOWN ABOVE,
PROVIDE A CONTINUOUS 2° CORROSION
RESISTANT SOFFIT VENT AT UNDERSIDE OF
FRAMED ELEMENT.

1/300 RATIO:

AS AN ALTERNATE TO THE 1/150 RATIO LISTED, THE NET FREE CROSS-VENTILATION AREA MAY BE REDUCED TO 1/300 WHEN A VAPOR BARRIER IS HAVING A TRANSMISSION RATE NOT EXCEEDING I-PERM INSTALLED ON THE WARM-IN-WINTER SIDE OF THE CEILING.

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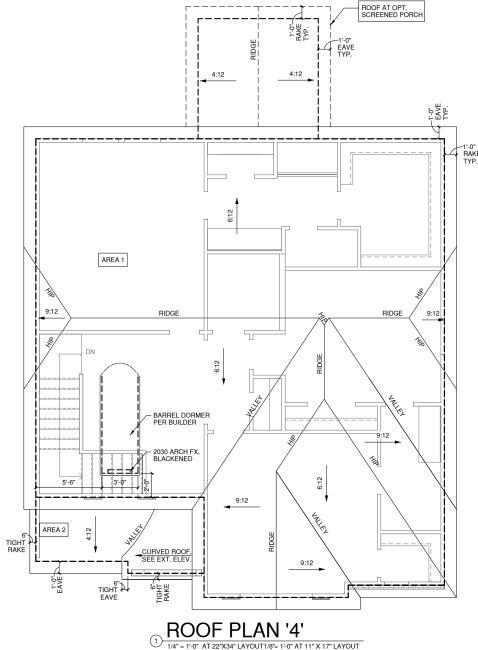
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PER DEVELOPER, AT ALL CANTILEVERED FLOORS, CANTILEVERED ARCHITECTURAL POP-OUTS, AND ANY DOUBLE FRAMING PROJECTIONS THAT ARE SEPARATED FROM THE VENTING CALCULATIONS SHOWN ABOVE, PROVIDE A CONTINUOUS 2" CORROSION RESISTANT SOFFIT VENT AT UNDERSIDE OF FRAMED ELEMENT.

NOTES:

- ALL ROOF DRAINAGE SHALL BE PIPED TO STREET OR APPROVED DRAINAGE FACILITY.
 DASHED LINES INDICATE WALL BELOW.
 LOCATE GUTTER AND DOWNSPOUTS PER DRIVERS.
- BUILDER. PITCHED ROOFS AS NOTED.
- TRUSS MANUFACTURER SHALL SUBMIT STRUCTURAL CALCS AN SHOP DRAWING TO THE BUILDER'S GENERAL CONTRACTOR AND BUILDING DEPARTMENT FOR REVIEW PRIOR TO FABRICATIONS.
 ALL PLUMBING VENTS SHALL BE COMBINED INTO A MINIMUM AMOUNT OF ROOP PENETRATIONS. ALL ROOF PENETRATIONS SHALL OCCUR TO THE REAR OF THE MAIN RIDGE.

ROOF VENT CALC. ELEV. '4'			
Name	Area	1/300 RATIO AT HIGH & LOW	1/150 RATIO AT HIGH & LOW
AREA 1	1173 SF	281.52 in ²	563.04 in ²
AREA 2	81 SF	19.44 in ²	38.88 in ²



1/4" = 1'-0" AT 22"X34" LAYOUT1/8"= 1'-0" AT 11" X 17" LAYOUT

group

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NO:	DATE:	REVISION:

PROFESSIONAL SEAL:

PROJECT TITLE:

QUACKENBUSH HOMES LLC 9220 FAIRBANKS DR SUITE 240 RALEIGH, NC 27613 919-741-7993

CONSTRUCTION SET

CLIENTS NAME:

QUACKENBUSH HOMES

PROJECT NO:

GMD16003RAL SHEET TITLE:


ROOF PLAN '4'

10.19.16


SHEET NO:

PRINT DATE:

A5.4.1

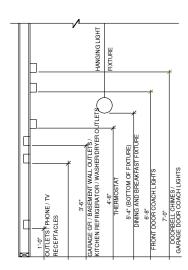

STANDARD ELECTRICAL BOX HEIGHTS

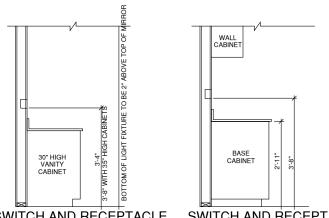

SWITCH AND RECEPTACLE SWITCH AND RECEPTACLE BOXES OVER BATH CABINETS BOXES OVER KITCHEN CABINETS

NOTES:

-PROVIDE GROUNDING ELECTRICAL ROD PER LOCAL CODES.

-PROVIDE AND INSTALL ARC FAULT CIRCUIT-INTERRUPTERS (AFCI) AS REQUIRED BY NATIONAL ELECTRICAL CODE (NEC) AND MEETING THE REQURIEMENTS OF ALL GOVERNING CODES.

ALL EXHAUST FANS SHALL HAVE BACKDRAFT DAMPERS

FAN/LIGHTS IN WET/DAMP LOCATIONS SHALL BE LABLED "SUITABLE FOR WET OR DAMP LOCATIONS."

-ELECTRICAL SYSTEMS ARE SHOWN FOR INTENT ONLY. THESE SYSTEMS SHALL BE ENGINEERED BY

-PROVIDE AND INSTALL LOCALLY CERTIFIED SMOKE DETECTORS AND CO2 DETECTORS AS REQUIRED BY NATIONAL FIRE PROTECTION ASSOCIATION (NFPA) AND MEETING THE REQUIREMENTS OF ALL GOVERNING CODES

-PROVIDE AND INSTALL GROUND FAULT CIRCUIT-INTERRUPTERS (GFI) AS REQUIRED BY NATIONAL ELECTRICAL CODE (NEC) AND MEETING THE REQUIREMENTS OF ALL GOVERNING CODES.


-ELECTRICAL CONTRACTOR TO PROVIDE REQURIED DIRECT HOOK-UPS/CUTOFFS.

-HVAC CONTRACTOR TO VERIFY THERMOSTAT LOCATIONS.


-ALL ELECTRICAL AND MECHANICAL EQUIPMENT (FURNACES, A/C UNITS, ELECTRICAL PANELS, SANITARY SUMP PITS DRAING TILE SUMP, AND WATER HEATERS) ARE SUBJECT TO RELOCATOIN DUE TO FIELD CONDITIONS.


-PROVIDE POWER, LIGHT AND SWITCH AS REQUIRED FOR ATTIC FURNACE PER CODE AND MANUFACTURER'S WRITTEN INSTRUCTIONS.

LEGE	ND:			
Ф	DUPLEX OUTLET	$-\phi$	CEILING MOUNTED INCANDESCENT LIGHT FIXTURE	
∯wp/gfi	WEATHERPROOF GFI DUPLEX OUTLET	 	WALL MOUNTED INCANDESCENT LIGHT FIXUTRE	
P _{GFI}	GROUND-FAULT CIRCUIT- INTERRUPTER DUPLEX OUTLET	 	RECESSED INCANDESCENT LIGHT FIXTURE	
ρ	HALF-SWITCHED DUPLEX OUTLET	74	(VP) = VAPOR PROOF	
P 220V	220 VOLT OUTLET		EXHAUST FAN (VENT TO EXTERIOR)	
①	REINFORCED JUNCTION BOX		EXHAUST FAN/LIGHT COMBINATION (VENT TO EXTERIOR)	
\$	WALL SWITCH	<u> </u>	•	
\$3	THREE-WAY SWITCH	\sim	1 FLUORESCENT LIGHT FIXTURE	
\$4	FOUR-WAY SWITCH		L TECH HUB SYSTEM	
СН	CHIMES		CEILING FAN	
9	PUSHBUTTON SWITCH		(PROVIDE ADEQUATE SUPPORT)	
®	110V SMOKE DETECTOR W/ BATTERY BACKUP	\$4	CEILING FAN WITH INCANDESCENT LIGHT FIXTURE	
60	CO2 DETECTOR		(PROVIDE ADEQUATE SUPPORT)	
T	THERMOSTAT		GAS SUPPLY WITH VALVE	
PH	TELEPHONE	<u> </u>		
TV	TELEVISION	THE	HOSE BIBB	
	ELECTRIC METER	-tcv	u 1/4" WATER STUB OUT	
<u> </u>	ELECTRIC PANEL	<u>₩</u>	WALL SCONCE	
	DISCONNECT SWITCH	Н	11/122 0001102	

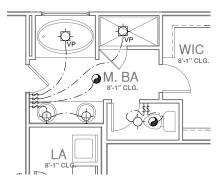

OPT. MASTER BATH 1

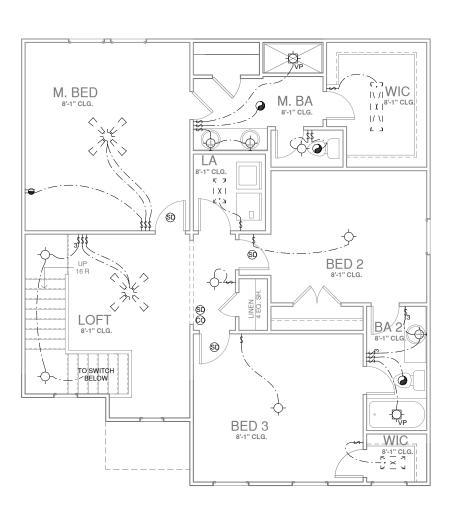

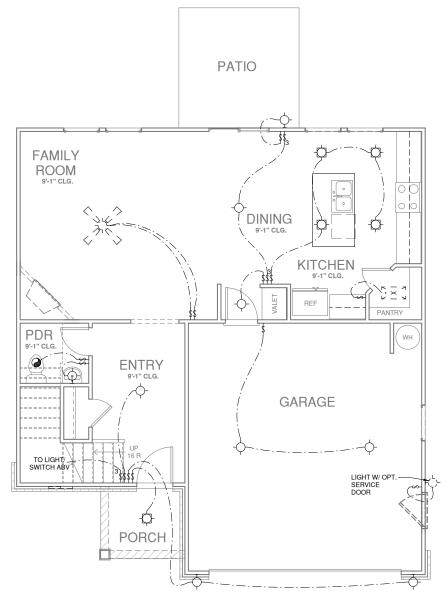

FIRST FLOOR PLAN '1'

group

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PROFESSIONAL SEAL:		

PROJECT TITLE:

QUACKENBUSH HOMES LLC 9220 FAIRBANKS DR SUITE 240 RALEIGH, NC 27613 919-741-7993

CONSTRUCTION SET

CLIENTS NAME:

QUACKENBUSH HOMES

PROJECT NO:

GMD16003RAL

SHEET TITLE:

UTILITY PLANS

PRINT DATE:

10.19.16

SHEET NO: E1.0