

# JACKSON PLAN 1971

ELEV. '1	'AREA	ELEV. '2	' AREA	ELEV. '3	' AREA	ELEV. '4	' AREA
Name	Area	Name	Area	Name	Area	Name	Area
FIRST FLOOR	1143 SF	FIRST FLOOR	1145 SF	FIRST FLOOR	1145 SF	FIRST FLOOR	1145 SF
SECOND FLOOR	828 SF	SECOND FLOOR	787 SF	SECOND FLOOR	787 SF	SECOND FLOOR	802 SF
HEATED	1971 SF	HEATED	1932 SF	HEATED	1932 SF	HEATED	1946 SF
GARAGE	387 SF	GARAGE	385 SF	GARAGE	385 SF	GARAGE	385 SF
PORCH	90 SF						
UNHEATED	477 SF	UNHEATED	475 SF	UNHEATED	475 SF	UNHEATED	475 SF

## GENERAL NOTES:

THESE DOCUMENTS ARE THE PROPERTY OF THE DESIGNER AND SHALL NOT BE COPIED, DUPLICATED, ALTERED, MODIFIED OR REVISED IN ANY WAY WITHOUT THE EXPRESSED WRITTEN APPROVAL OF THE DESIGNER.

CONTRACTOR SHALL VERIFY ALL CONDITIONS AND DIMENSIONS AT THE SITE AND

CONTINACTOR SHALL VEHIFY ALL CONDITIONS AND DIMENSIONS AT THE STIE AND ALL INCONSISTENCES SHALL BE BROUGHT TO THE ATTENTION OF THE DEVELOPER AND THE DESIGNER BEFORE PROCEEDING WITH WORK.

ANY ERRORS OR OMISSIONS FOUND IN THESE DRAWINGS SHALL BE BROUGHT TO DEVELOPERS AND DESIGNERS ATTENTION IMMEDIATELY.

DO NOT SCALE DRAWINGS. WRITTEN DIMENSIONS TAKE PRECEDENCE OVER SCALED DIMENSIONS.

ALL DIMENSIONS ARE TO FACE OF STUD OR TO FACE OF FRAMING UNLESS OTHERWISE NOTED.

ALL TRUSS DRAWINGS TO BE REVIEWED AND APPROVED BY THE STRUCTURAL ENGINEER PRIOR TO ISSUANCE OF BUILDING PERMIT.

ALL OR EQUAL SUBSTITUTIONS MUST BE SUBMITTED TO AND APPROVED BY CITY BUILDING OFFICIAL PRIOR TO INSTALLATION.

ALL ANGLED PARTITIONS ARE 45 DEGREES UNLESS OTHERWISE NOTED. PROVIDE FIREBLOCKING. (PER LOCAL CODES.)

PROVIDE FIREBLOCKING. (PER LOCAL CODES.)

ALL ELECTRICAL AND MECHANICAL EQUIPMENT AND METERS ARE SUBJECT TO RELOCATION DUE TO FIELD CONDITIONS. CONTRACTOR TO VERIFY.

PROVIDE BLOCKING ANDIOR BACKING AT ALL TOWEL BAR, TOWEL RING ANDIOR TOILET PAPER HOLDER LOCATIONS, AS SHOWN PER PLAN. TYPICAL AT ALL BATHROOMS AND POWDER ROOMS. VERIFY LOCATIONS AT FRAMING WALK.

ELASTOMERIC SHEET WATERPROOFING: FURNISH AND INSTALL ALL WATERPROOFING COMPLETE. A 40 MIL. SELF-ADHERING MEMBRANE OF RUBBERIZED ASPHALT INTEGRALLY BONDED TO POLYETHYLENE SHEETING. OR EQUAL INSTALL PER MANUFACTURIES AND TRADE ASSOCIATIONS PRINTED INSTALLATION INSTRUCTIONS. OF MINIMIMUL AP A TALL ADJACENT WALL SURFACES.

TO THE BEST OF THE DESIGNER'S KNOWLEDGE THESE DOCUMENTS ARE IN CONFORMANCE WITH THE REQUIREMENTS OF THE BUILDING AUTHORITIES HAVING JURISDICTION OVER THIS TYPE OF CONSTRUCTION AND OCCUPANCY.

SHOP DRAWING REVIEW AND DISTRIBUSTION, ALONG WITH PRODUCT SUBMITTALS, REQUESTED IN THE CONSTRUCTION DOCUMENTS, SHALL BE THE SOLE RESPONSIBILITY OF THE GENERAL CONTRACTOR, UNLESS DIRECTED OTHERWISE UNDER A SEPARATE AGREEMENT.

DEVIATIONS FROM THESE DOCUMENTS IN THE CONSTRUCTION PHASE SHALL BE REVIEWED BY THE DESIGNER AND THE OWNER PRIOR TO THE START OF WORK IN QUESTION. ANY DEVIATIONS FROM THESE DOCUMENTS WITHOUT PRIOR REVIEW, SHALL BE THE SOLE RESPONSIBILITY OF THE GENERAL CONTRACTOR.

THE GENERAL CONTRACTOR SHALL BE RESPONSIBLE FOR ALL WORK AND MATERIALS REPRESENTED ON THESE DOCUMENTS INCLUDING THE WORK AND MATERIALS FURNISHED BY SUBCONTRACTORS AND VENDORS.

THE OWNER SHALL FURNISH ANY AND ALL REPORTS RECEIVED FROM THE GEOTECHNICAL ENGINEER (SOILS REPORT), ON THE STUDY OF THE PROPOSED SITE, TO THE DESIGNER, STRUCTURAL ENGINEER, AND GENERAL CONTRACTOR, IN THE EVENT THE GEOTECHNICAL REPORTS DO NOT EXIST, THE SOILS CONDITION SHALL BE ASSUMED TO BE A MINIMUM DESIGN SOIL PRESSURE STATED BY THE STRUCTURAL GENIGER OF RECORD FOR THE PURPOSE OF STRUCTURAL DESIGN, GENERAL CONTRACTOR SHALL ASSURE THE SOIL CONDITIONS MEET OR EXCEED

ALL WORK PERFORMED BY THE GENERAL CONTRACTOR SHALL COMPLY AND CONFORM WITH LOCAL AND STATE BUILDING CODES, ORDINANCES AND REGULATIONS, ALONG WITH ALL OTHER AUTHORITIES HAVING JURISDICTION. THE GENERAL CONTROATOR IS RESPONSIBLE TO BE AWARE OF THESE REQUIREMENTS AND GOVERNING REGULATIONS.

PROVIDE AN APPROVED WASHER DRAIN PAN AT SECOND FLOOR ONLY THAT DRAINS TO EXTERIOR.

THE CRITERIA.

LOCAL CODES.

WINDOW SUPPLIER TO VERIFY AT LEAST ONE WINDOW IN ALL BEDROOMS TO HAVE A CLEAR OPENABLE AREA OF 4.0 SO FT. THE WINIMIMUM NET CLEAR OPENING HIGHEIT SHALL BE 22° GLAZINE TOTAL AREA OF NOT LESS THAN S.0 SO FT IN THE CASE OF A GROUND WINDOW AND NOT LESS THAN 5.7 SQ FT IN THE CASE OF AN UPPER STORY WINDOW, (PER NORCE SECTION R 1910.1.1)
ALL HANDRAIL BALLUSTERS TO BE SPACED SUCH THAT A 4° SPHERE CANNOT PASS BETWEEN BALLUSTERS, (PER LOCAL CODES.)
PROVIDE STAIR HANDRAILS AND GUARDRAILS PER

## **BUILDER SET:**

THE SCOPE OF THIS SET OF PLANS IS TO PROVIDE A "BUILDER'S SET"
OF CONSTRUCTION DOCUMENTS AND GENERAL NOTSE HEREINATER REFERRED TO AS "PLANS".
THIS SET OF PLANS IS SUPFICIENT TO OBTAIN A BUILDING PERMIT; HOWEVER, ALL MATERIALS
AND METHODS OF CONSTRUCTION NECESSARY TO COMPLETE THE PROJECT ARE NOT
NECESSARILY DESCRIBLED. THE PLANS DELINEATE AND DESCRIBE ONLY LOCATIONS.
DIMENSIONS, TYPES OF MATERIALS, AND GENERAL METHODS OF ASSEMBLING OR FASTENING.
THEY ARE NOT INTENDED TO SPECIFY PARTICULAR PRODUCTS OR OTHER METHODS OF ANY
SPECIFIC MATERIALS, PRODUCT OF METHOD. THE MIPLEMENTATION OF THE PLANS REQUIRES A
CLIENT / CONTRACTOR THOROUGHLY KNOWLEDGEABLE WITH THE APPLICABLE BUILDING CODES
AND METHODS OF CONSTRUCTION SPECIFIC TO THIS PRODUCT TYPE AND TYPE OF CONSTRUCTION.

CONSTRUCTION REQUIREMENTS AND QUALITY: PROVIDE WORK OF THE SPECIFIC QUALITY;
WHERE QUALITY LEVEL IS NOT INDICATED. PROVIDE WORK OF QUALITY CUSTOMARY IN SIMILAR
TYPES OF WORK. WHERE THE PLANS AND SPECIFICATIONS, CODES, LAWS, REGULATIONS,
AMAUFACTURERS RECOMMENDATIONS OR INDUSTRY STANDARDS REQUIRE WORK OF HIGHER
QUALITY OR PERFORMANCE, PROVIDE WORK COMPLYING WITH THOSE REQUIREMENTS AND QUALITY,
WHERE TWO OR MORE QUALITY PROVISIONS OF THOSE REQUIREMENTS CONTEXT BUT APPARENTLY
CQUAL, AND WHERE IT IS UNCERTAIN WHICH REQUIREMENTS ARE DIFFERENT BUT APPARENTLY
CQUAL, AND WHERE IT IS UNCERTAIN WHICH REQUIREMENTS.



NORTH CAROLINA OFFICE 102 FOUNTAIN BROOK CIRCL SUITE C CARY, NC 27511 PHONE: (919) 320-3022

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NO:	DATE:	REVISION:

PROFESSIONAL SEAL:

PROJECT TITLE:

QUACKENBUSH HOMES LLC 9220 FAIRBANKS DR SUITE 24 RALEIGH, NC 27613 919-741-7993

CONSTRUCTION SET

CLIENTS NAME

QUACKENBUSH HOMES

PROJECT NO JACKSON

SHEET TITLE:

**COVER SHEET** 

PRINT DATE:

01.03.17

SHEET NO:

T-1

IRRIGATION SYSTEM SHALL BE DESIGNED TO PREVENT THE SATURATION OF SOIL ADJACENT TO BUILDING

THIS PERIMETER DIMENSION PLAN IS FOR DIMENSIONAL INFORMATION ONLY.

SLOPE ALL STOOPS AND HARDSCAPE MATERIAL AWAY FROM BUILDING - TYPICAL.

SLOPE GARAGE FLOOR 1/8" PER FOOT TO GARAGE DOOR OPENING.

VERIFY CURB CUT BLOCKOUT WITH GARAGE DOOR MANUFACTURER.

- REFER TO CIVIL DRAWINGS FOR FINISH SURFACE ELEVATIONS.

- FINISH GRADE SHALL PROVIDE POSITIVE DRAINAGE AWAY FROM BUILDING. REFER TO SOILS REPORT FOR ANY SPECIFIC REQUIREMENTS.

REFER TO STRUCTURAL DRAWINGS FOR HOLDDOWNS, FOOTING DETAILS, CURB THICKNESS, AND

INFORMATION NOT SHOWN ON THIS PLAN.

- PLUMBING FIXTURES, VENT LOCATIONS, ETC. ARE APPROXIMATE. CONTRACTOR TO VERIFY COUNT AND LOCATION.

VERIFY THE SUPPLY FOR SEPARATE CONDUITS TO ANY ISLAND FOR GAS, WATER OR ELECTRIC.

VERIFY ALL DOOR THRESHOLD HEIGHTS TO HARD SURFACES.

8 1/4" MAX AT INSWING DOORS. (PER NCRC SECTION R311.3.1.)

TYP STOOP AT INSWING/SLIDER DOORS: 36" DEEP BY THE WIDTH OF THE DOOR SERVED, MINIMUM. (PER NCRC SECTION R311.3.) PROVIDE A SLIP-RESISTANT FINISH.


FOR THE USE OF EXPOSED GAS WATER HEATERS IN THE GARAGE, PROTECT THE WATER HEATER WITH 3" DIA CONCRETE FILLED STEEL PIPE EMBEDDED INTO CONCRETE FOOTING.

SOILS TREATMENT:
BORACARE TERMITE TO BE APPLIED TO FRAMING PER PRODUCT SPECIFICATIONS.
(PROVIDE CHEMICAL TREATMENT FOR PROTECTION FROM TERMITE INFESTATION
ACCORDING TO THE STANDARDS OF THE NC DEPT OF AGRICULTURE.)

WOOD CONTACTING CONCRETE OR MASONRY OR LESS THAN CODE REQUIRED SEPARATION TO GRADE SHALL BE PRESSURE TREATED OR FOUNDATION GRADE REDWOOD. SET ALL EXTERIOR WALL SILLS IN MASTIC.

## REFER TO STRUCTURAL DRAWINGS FOR ALL FOUNDATION DIMENSIONS

FOL	JNDATION KEYNOTE LEGEND
F1	LINE OF SLAB ABOVE
F2	LINE OF FRAMED WALL ABOVE
F6	IYPICAL CRAWL FOUNDATION WALL SHALL BE 8" CMU OR A COMBINATION OF 4" CMU WITH NOMINAL 4" BRICK. SEE STRUCTURAL DRAWINGS FOR ALL STRUCTURAL ATTACHMENTS. ALL BLOCK CELLS AND SPACE BETWEEN BLOCK AND BRICK SHALL BE FILLED WITH SOLID CONCRETE. FOUNDATION WALL WITH FULL HEIGHT BRICK WEREER SHALL CONSIST OF 8" CMU WITH NOMINAL 4" BRICK. SEE STRUCTURAL DRAWINGS FOR ALL STRUCTURAL ATTACHMENTS AND BRICK TIE SPACING. FILL VOIDS SOLID TO TOP OF CMU WALL. (MUST COMPLY WITH NORC SECTION R404, TABLE R404.1.1(4) AND APPLICABLE SECTIONS OF R606, R607, R608.) VERIFY WITH STRUCTURAL DRAWINGS FOR WALL FOOTING SIZE AND DEPTH.

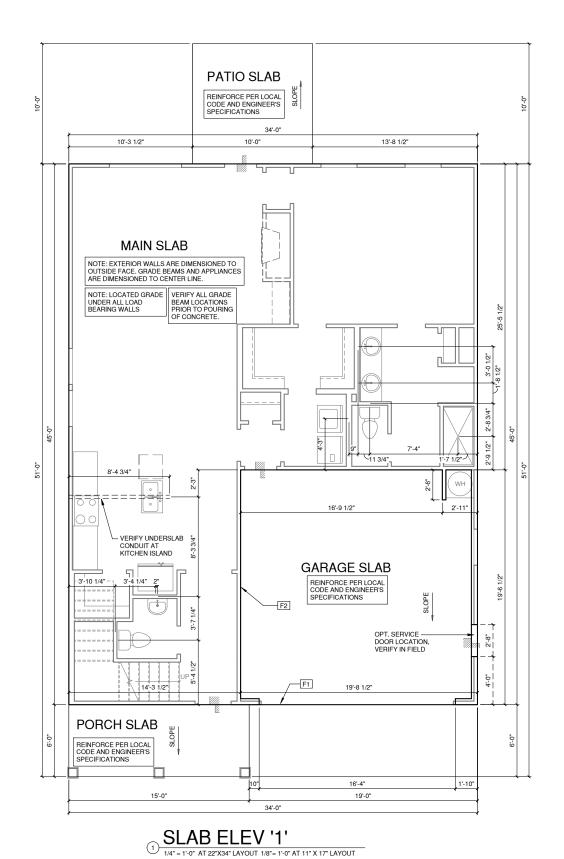



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NO:	DATE:	REVISION:

PROFESSIONAL SEAL:

PROJECT TITLE:

QUACKENBUSH HOMES LLC 9220 FAIRBANKS DR SUITE 240 RALEIGH, NC 27613 919-741-7993

CONSTRUCTION SET

CLIENTS NAME:

QUACKENBUSH HOMES

PROJECT NO:

SHEET TITLE:

JACKSON

**SLAB ELEV '1'** 

PRINT DATE:

01.03.17

SHEET NO:

A0.1.1

IRRIGATION SYSTEM SHALL BE DESIGNED TO PREVENT THE SATURATION OF SOIL ADJACENT TO BUILDING.

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SLOPE ALL STOOPS AND HARDSCAPE MATERIAL AWAY FROM BUILDING - TYPICAL.

SLOPE GARAGE FLOOR 1/8" PER FOOT TO GARAGE DOOR OPENING.

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FINISH GRADE SHALL PROVIDE POSITIVE DRAINAGE AWAY FROM BUILDING. REFER TO SOILS REPORT FOR ANY SPECIFIC REQUIREMENTS.

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VERIFY THE SUPPLY FOR SEPARATE CONDUITS TO ANY ISLAND FOR GAS, WATER OR ELECTRIC.

VERIFY ALL DOOR THRESHOLD HEIGHTS TO HARD SURFACES. 8 1/4" MAX AT INSWING DOORS. (PER NCRC SECTION R311.3.1.)

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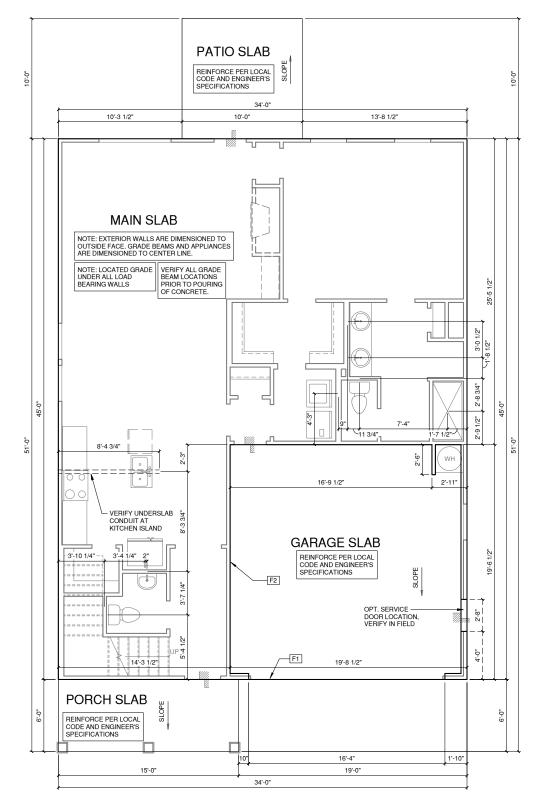
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WOOD CONTACTING CONCRETE OR MASONRY OR LESS THAN CODE REQUIRED SEPARATION TO GRADE SHALL BE PRESSURE TREATED OR FOUNDATION GRADE REDWOOD. SET ALL EXTERIOR WALL SILLS IN MASTIC.

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① SLAB ELEV '2'

1/4" = 1'-0" AT 22"X34" LAYOUT 1/8" = 1'-0" AT 11" X 17" LAYOUT



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PROFESSIONAL SEAL:

PROJECT TITLE:

QUACKENBUSH HOMES LLC 9220 FAIRBANKS DR SUITE 240 RALEIGH, NC 27613 919-741-7993

CONSTRUCTION SET

CLIENTS NAME:

QUACKENBUSH HOMES

PROJECT NO:

JACKSON SHEET TITLE:

**SLAB ELEV '2'** 

PRINT DATE:

01.03.17

IRRIGATION SYSTEM SHALL BE DESIGNED TO PREVENT THE SATURATION OF SOIL ADJACENT TO BUILDING.

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SLOPE ALL STOOPS AND HARDSCAPE MATERIAL AWAY FROM BUILDING - TYPICAL

SLOPE GARAGE FLOOR 1/8" PER FOOT TO GARAGE DOOR OPENING.

VERIFY CURB CUT BLOCKOUT WITH GARAGE DOOR MANUFACTURER.

REFER TO CIVIL DRAWINGS FOR FINISH SURFACE ELEVATIONS.

FINISH GRADE SHALL PROVIDE POSITIVE DRAINAGE AWAY FROM BUILDING. REFER TO SOILS REPORT FOR ANY SPECIFIC REQUIREMENTS.

REFER TO STRUCTURAL DRAWINGS FOR HOLDDOWNS, FOOTING DETAILS, CURB THICKNESS, AND

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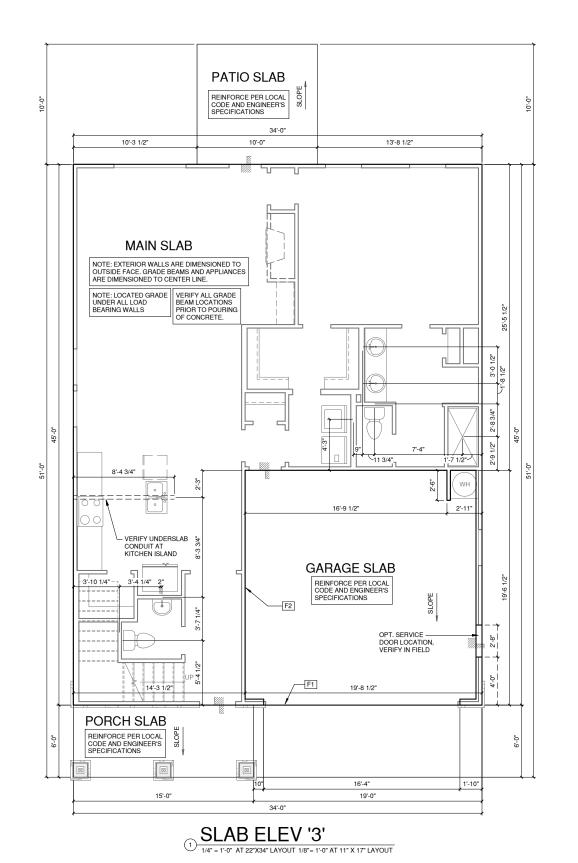
FOR THE USE OF EXPOSED GAS WATER HEATERS IN THE GARAGE, PROTECT THE WATER HEATER WITH 3" DIA CONCRETE FILLED STEEL PIPE EMBEDDED INTO CONCRETE FOOTING.

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WOOD CONTACTING CONCRETE OR MASONRY OR LESS THAN CODE REQUIRED SEPARATION TO GRADE SHALL BE PRESSURE TREATED OR FOUNDATION GRADE REDWOOD. SET ALL EXTERIOR WALL SILLS IN MASTIC.

## REFER TO STRUCTURAL DRAWINGS FOR ALL FOUNDATION DIMENSIONS

F	OUNDATION KEYNOTE LEGEND
F1	LINE OF SLAB ABOVE
F2	LINE OF FRAMED WALL ABOVE
F6	TYPICAL CRAWL FOUNDATION WALL SHALL BE 9° CMU OR A COMBINATION OF 4° CMU WITH NOMINAL 4° BRICK. SEE STRUCTURAL DRAWINGS FOR ALL STRUCTURAL ATTACHMENTS. ALL BLOCK CELLS AND SPACE BETWEEN BLOCK AND BRICK SHALL BE FILLED WITH SOLID CONCRETE. FOUNDATION WALL WITH FULL HEIGHT BRICKVENEER SHALL CONSIST OF 8° CMU WITH NOMINAL 4° BRICK. SEE STRUCTURAL DRAWINGS FOR ALL STRUCTURAL ATTACHMENTS AND BRICK TIE SPACING. FILL VOIDS SOLID TO TOP OF CMU WALL. (MUST COMPLY WITH NCRC SECTION R404, TABLE R404.1.1(1) THROUGH R404.1.1(4) AND APPLICABLE SECTIONS OF R606, R607, R608.) VERIFY WITH STRUCTURAL DRAWINGS FOR WALL FOOTING SIZE AND DEPTH.



design group

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PROJECT TITLE:

QUACKENBUSH HOMES LLC 9220 FAIRBANKS DR SUITE 240 RALEIGH, NC 27613 919-741-7993

CONSTRUCTION SET

CLIENTS NAME:

QUACKENBUSH HOMES

PROJECT NO:

SHEET TITLE:

JACKSON

**SLAB ELEV '3'** 

PRINT DATE:

01.03.17

SHEET NO:

A0.1.3

- IRRIGATION SYSTEM SHALL BE DESIGNED TO PREVENT THE SATURATION OF SOIL ADJACENT TO BUILDING.

- THIS PERIMETER DIMENSION PLAN IS FOR DIMENSIONAL INFORMATION ONLY.

- SLOPE ALL STOOPS AND HARDSCAPE MATERIAL AWAY FROM BUILDING - TYPICAL

- SLOPE GARAGE FLOOR 1/8" PER FOOT TO GARAGE DOOR OPENING

- REFER TO CIVIL DRAWINGS FOR FINISH SURFACE ELEVATIONS.

- VERIFY CURB CUT BLOCKOUT WITH GARAGE DOOR MANUFACTURER.

- FINISH GRADE SHALL PROVIDE POSITIVE DRAINAGE AWAY FROM BUILDING, REFER TO SOILS REPORT FOR ANY SPECIFIC REQUIREMENTS.

- REFER TO STRUCTURAL DRAWINGS FOR HOLDDOWNS, FOOTING DETAILS, CURB THICKNESS, AND INFORMATION NOT SHOWN ON THIS PLAN.

PLUMBING FIXTURES, VENT LOCATIONS, ETC. ARE APPROXIMATE. CONTRACTOR TO VERIFY COUNT AND LOCATION.

- VERIFY THE SUPPLY FOR SEPARATE CONDUITS TO ANY ISLAND FOR GAS, WATER OR ELECTRIC.

- VERIFY ALL DOOR THRESHOLD HEIGHTS TO HARD SURFACES. 8 1/4" MAX AT INSWING DOORS. (PER NCRC SECTION R311.3.1.)

- TYP STOOP AT INSWING/SLIDER DOORS: 36" DEEP BY THE WIDTH OF THE DOOR SERVED, MINIMUM. (PER NCRC SECTION R311.3.) PROVIDE A SLIP-RESISTANT FINISH.


- FOR THE USE OF EXPOSED GAS WATER HEATERS IN THE GARAGE, PROTECT THE WATER HEATER WITH  $3^{\circ}\,\text{DIA}$  CONCRETE FILLED STEEL PIPE EMBEDDED INTO CONCRETE FOOTING.

- SOILS TREATMENT:
BORACARE TERMITE TO BE APPLIED TO FRAMING PER PRODUCT SPECIFICATIONS.
(PROVIDE O'HEMICAL TREATMENT FOR PROTECTION FROM TERMITE INFESTATION
ACCORDING TO THE STANDARDS OF THE NC DEPT OF AGRICULTURE.)

- WOOD CONTACTING CONCRETE OR MASONRY OR LESS THAN CODE REQUIRED SEPARATION TO GRADE SHALL BE PRESSURE TREATED OR FOUNDATION GRADE REDWOOD. SET ALL EXTERIOR WALL SILLS IN MASTIC.

## REFER TO STRUCTURAL DRAWINGS FOR ALL FOUNDATION DIMENSIONS

FOL	FOUNDATION KEYNOTE LEGEND			
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PROJECT TITLE:

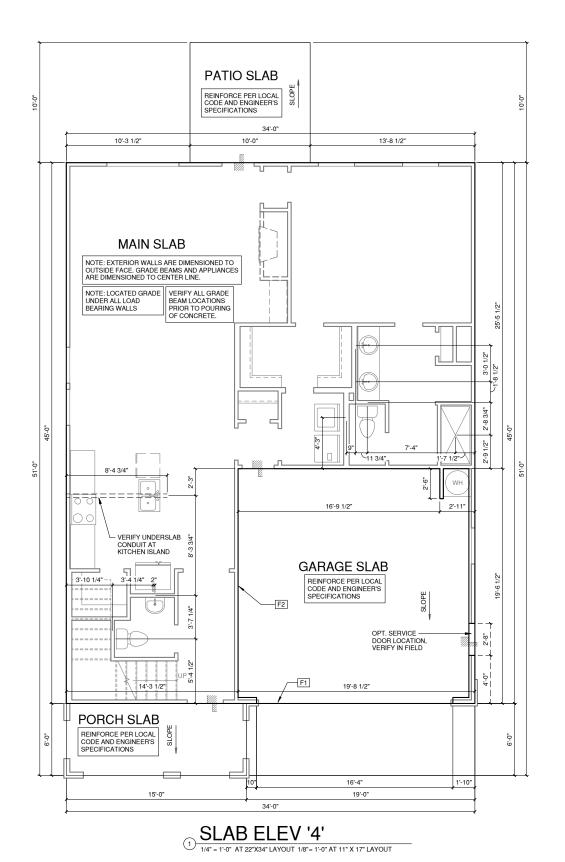QUACKENBUSH HOMES LLC 9220 FAIRBANKS DR SUITE 240 RALEIGH, NC 27613 919-741-7993

CONSTRUCTION SET

CLIENTS NAME:

QUACKENBUSH HOMES

PROJECT NO:

JACKSON SHEET TITLE:

**SLAB ELEV '4'** 

PRINT DATE:

01.03.17

-REFER TO STRUCTURAL DRAWINGS FOR INFORMATION NOT SHOWN ON THIS PLAN

-FOR ADDITIONAL NOTES SEE GENERAL NOTES ON TITLE SHEET AND DETAILS.

-PROVIDE FIREBLOCKING. (PER NCRC SECTION R602.8)

-ALL ELECTRICAL AND MECHANICAL EQUIPMENT AND METERS ARE SUBJECT TO RELOCATION DUE TO FIELD CONDITIONS, CONTRACTOR TO VERIFY.

-VERIFY ALL DOOR THRESHOLD HEIGHTS TO HARD S URFACES

8 1/4" MAX AT INSWING DOORS. (PER NCRC SECTION R311.3.1)

-SLOPE ALL STOOPS AND HARDSCAPE MATERIAL AWAY FROM BUILDING - TYPICAL.

-SLOPE GARAGE FLOOR 1/8" PER FOOT TO GARAGE DOOR OPENING.

VERIFY CURB CUT BLOCKOUT WITH GARAGE DOOR MANUFACTURER.

-REFER TO CIVIL DRAWINGS FOR FINISH SURFACE ELEVATIONS.

-TYP, STOOP AT INSWING/SLIDER DOORS: 36" DEEP BY THE WIDTH OF THE DOOR SERVED.

MINIMUM (PER NCRC SECTIONS R311.3) PROVIDE A SLIP-RESISTANT FINISH

-SOILS TREATMENT:
BORACARE TERMITE TO BE APPLIED TO FRAMING PER PRODUCT SPECIFICATIONS, (PROVIDE CHEMICAL TREATMENT FOR PROTECTION FROM TERMITE INVESTATION ACCORDING TO THE STANDARDS OF THE NC DEPT. OF AGRICULTURE.)

APPLY AN APPROVED VAPOR RETARDER OR EQUIVALENT, 6 MIL POLY-VINYL, GROUND COVER OVER FINISH GRADE OR CRAWL SPACE PER NCRC SECTION 408.2


-PROVIDE VENTS SPACED AROUND PERIMETER TO PROMOTE CROSS VENTILATION AT A RATE OF 1 SF VENT FOR EVERY 1500 SF OF CRAWL FLOOR AREA. ONE VENT MUST BE LOCATED WITHIN 3-0" OF EACH CORNER OF THE BUILDING AND LOCATED TO ALLOW FOR CROSS VENTILATION. (PER NCRC SECTION R408.1.1 EXCEPTION.)

-PROVIDE AN ACCESS OPENING, MINIMUM SIZE OF 18"X24" FOR CRAWL ACCESS. COORDINATE WITH MECHANICAL CONTRACTOR FOR LARGER SIZE REQUIREMENTS IF MECHANICAL EQUIPMENT IS LOCATED IN CRAWL. (PER NCRC SECTION 408.8)

-WOOD CONTACTING CONCRETE OR MASONRY OR LESS THAN CODE REQUIRED SEPARATION TO GRADE SHALL BE PRESSURE TREATED OR FOUNDATION GRADE REDWOOD. SET ALL EXTERIOR WALL SILLS IN MASTIC.

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F1	LINE OF SLAB ABOVE
F2	LINE OF FRAMED WALL ABOVE
F6	ITYPICAL CRAWL FOUNDATION WALL SHALL BE 8° CMU OR A COMBINATION OF 4" CMU WITH NOMINAL 4" BRICK. SEE STRUCTURAL DRAWINGS FOR ALL STRUCTURAL ATTACHMENTS. ALL BLOCK CELLS AND SPACE BETWEEN BLOCK AND BRICK SHALL BE FILLED WITH SOLID CONCRETE. FOUNDATION WALL WITH FULL HEIGHT BRICKVENEER SHALL CONSIST OF 8° CMU WITH NOMINAL 4" BRICK. SEE STRUCTURAL DRAWINGS FOR ALL STRUCTURAL ATTACHMENTS AND BRICK TIE SPACING. FILL VOIDS SOLID TO TOP OF CMU WALL. (MUST COMPLY WITH NGRC SECTION R404, TABLE R404.1.1(1) THROUGH R404.1.1(4) AND APPLICABLE SECTIONS OF R606, R607, R606.) VERIFY WITH STRUCTURAL DRAWINGS FOR WALL FOOTING SIZE AND DEPTH.



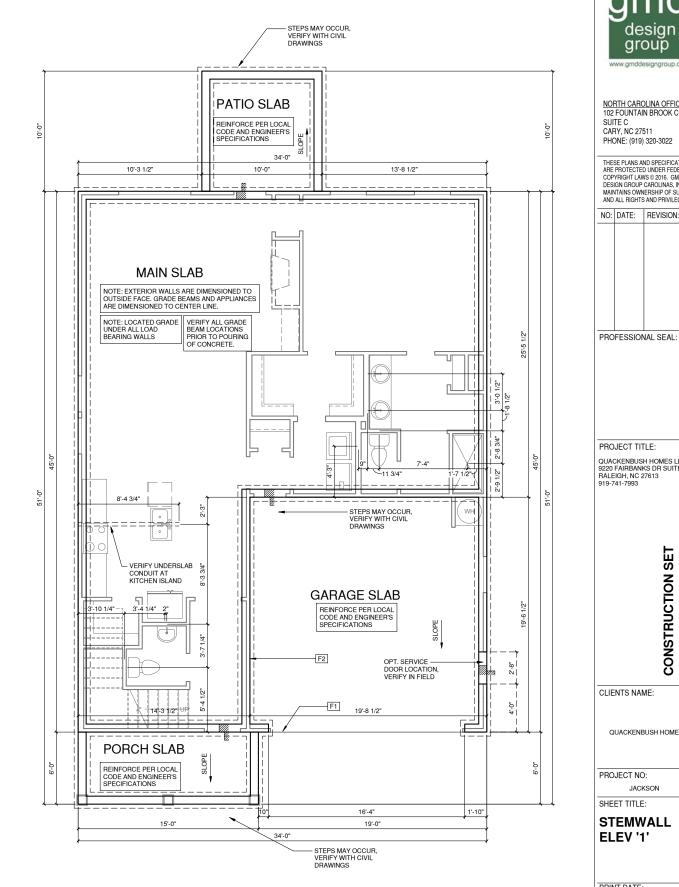



NORTH CAROLINA OFFICE 102 FOUNTAIN BROOK CIRCLE SUITE C CARY, NC 27511 PHONE: (919) 320-3022

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NO:	DATE:	REVISION:

PROJECT TITLE:

QUACKENBUSH HOMES LLC 9220 FAIRBANKS DR SUITE 240 RALEIGH, NC 27613

CONSTRUCTION SET

CLIENTS NAME:

QUACKENBUSH HOMES

PROJECT NO:

JACKSON

**STEMWALL** ELEV '1'

PRINT DATE:

01.03.17

REFER TO STRUCTURAL DRAWINGS FOR INFORMATION NOT SHOWN ON THIS PLAN.

-FOR ADDITIONAL NOTES SEE GENERAL NOTES ON TITLE SHEET AND DETAILS

PROVIDE FIREBLOCKING. (PER NCRC SECTION R602.8)

-ALL ELECTRICAL AND MECHANICAL EQUIPMENT AND METERS ARE SUBJECT TO RELOCATION DUE TO FIELD CONDITIONS, CONTRACTOR TO VERIFY.

-VERIFY ALL DOOR THRESHOLD HEIGHTS TO HARD S URFACES. 8 1/4" MAX AT INSWING DOORS. (PER NCRC SECTION R311.3.1)

-SLOPE ALL STOOPS AND HARDSCAPE MATERIAL AWAY FROM BUILDING - TYPICAL

-SLOPE GARAGE FLOOR 1/8" PER FOOT TO GARAGE DOOR OPENING. VERIFY CURB CUT BLOCKOUT WITH GARAGE DOOR MANUFACTURER.

-REFER TO CIVIL DRAWINGS FOR FINISH SURFACE ELEVATIONS.

-TYP, STOOP AT INSWING/SLIDER DOORS: 36" DEEP BY THE WIDTH OF THE DOOR SERVED MINIMUM (PER NCRC SECTIONS R311.3) PROVIDE A SLIP-RESISTANT FINISH

-SOILS TREATMENT:
BORACARE TERMITE TO BE APPLIED TO FRAMING PER PRODUCT SPECIFICATIONS. (PROVIDE CHEMICAL TREATMENT FOR PROTECTION FROM TERMITE INVESTATION ACCORDING TO THE STANDARDS OF THE NC DEPT. OF AGRICULTURE.)

APPLY AN APPROVED VAPOR RETARDER OR EQUIVALENT, 6 MIL POLY-VINYL, GROUND COVER OVER FINISH GRADE OR CRAWL SPACE PER NCRC SECTION 408.2


-PROVIDE VENTS SPACED ABOUND PERIMETER TO PROMOTE CROSS VENTILIATION AT A RATE OF 1 SE VENT FOR EVERY 1500 SE OF CRAWL FLOOR AREA. ONE VENT MUST BE LOCATED WITHIN 3:0" OF EACH CORNER OF THE BUILDING AND LOCATED TO ALLOW FOR CROSS VENTILATION. (PER NCRC SECTION R408.1.1 EXCEPTION.)

-PROVIDE AN ACCESS OPENING, MINIMUM SIZE OF 18"X24" FOR CRAWL ACCESS. COORDINATE WITH MECHANICAL CONTRACTOR FOR LARGER SIZE REQUIREMENTS IF MECHANICAL EQUIPMENT IS LOCATED IN CRAWL. (PER NCRC SECTION 408.8)

-WOOD CONTACTING CONCRETE OR MASONRY OR LESS THAN CODE REQUIRED SEPARATION TO GRADE SHALL BE PRESSURE TREATED OR FOUNDATION GRADE REDWOOD. SET ALL EXTERIOR WALL SILLS IN MASTIC.

## REFER TO STRUCTURAL DRAWINGS FOR ALL FOUNDATION DIMENSIONS

FOL
F1
F2
F6

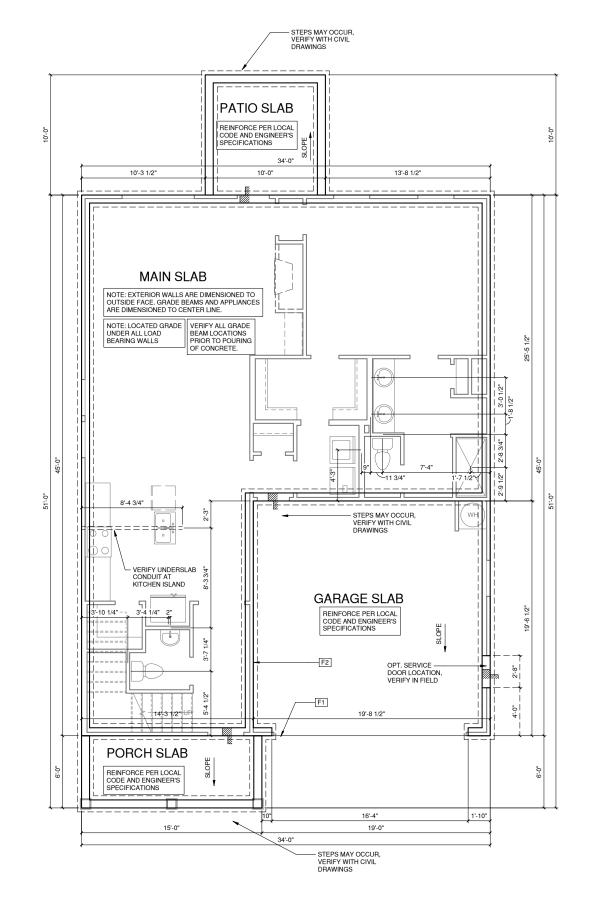





NORTH CAROLINA OFFICE 102 FOUNTAIN BROOK CIRCLE SUITE C CARY, NC 27511 PHONE: (919) 320-3022

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0:	DATE:	REVISION:

PROFESSIONAL SEAL:

PROJECT TITLE:

QUACKENBUSH HOMES LLC 9220 FAIRBANKS DR SUITE 240 RALEIGH, NC 27613 919-741-7993

CONSTRUCTION SET

CLIENTS NAME:

QUACKENBUSH HOMES

PROJECT NO:

JACKSON SHEET TITLE:

**STEMWALL** ELEV '2'

PRINT DATE:

01.03.17

-REFER TO STRUCTURAL DRAWINGS FOR INFORMATION NOT SHOWN ON THIS PLAN

-FOR ADDITIONAL NOTES SEE GENERAL NOTES ON TITLE SHEET AND DETAILS.

-PROVIDE FIREBLOCKING. (PER NCRC SECTION R602.8)

-ALL ELECTRICAL AND MECHANICAL EQUIPMENT AND METERS ARE SUBJECT TO RELOCATION DUE TO FIELD CONDITIONS, CONTRACTOR

-VERIFY ALL DOOR THRESHOLD HEIGHTS TO HARD SURFACES

SLOPE ALL STOOPS AND HARDSCAPE MATERIAL AWAY FROM BUILDING - TYPICAL.

-SLOPE GARAGE FLOOR 1/8" PER FOOT TO GARAGE DOOR OPENING.

-VERIFY CURB CUT BLOCKOUT WITH GARAGE DOOR MANUFACTURER.

-REFER TO CIVIL DRAWINGS FOR FINISH SURFACE ELEVATIONS.

-TYP. STOOP AT INSWING/SLIDER DOORS: 36" DEEP BY THE WIDTH OF THE DOOR SERVED, MINIMUM (PER NCRC SECTIONS R311.3) PROVIDE A SLIP-RESISTANT FINISH.

## -AT VENTED CRAWL SPACE

SOURCE TREMITE TO BE APPLIED TO FRAMING PER PRODUCT SPECIFICATIONS. (PROVIDE CHEMICAL TREATMENT FOR PROTECTION FROM TERMITE INVESTATION ACCORDING TO THE STANDARDS OF THE NC DEPT. OF AGRICULTURE.)

APPLY AN APPROVED VAPOR RETARDER OR EQUIVALENT, 6 MIL POLY-VINYL, GROUND COVER OVER FINISH GRADE OR CRAWL SPACE PER NCRC SECTION 408.2


-PROVIDE VENTS SPACED AROUND PERIMETER TO PROMOTE CROSS VENTILATION AT A RATE OF 1 SF VENT FOR EVERY 1500 SF OF CRAWL FLOOR AREA. ONE VENT MUST BE LOCATED WITHIN 3"-0" OF EACH CORNER OF THE BUILDING AND LOCATED TO ALLOW FOR CROSS VENTILATION. (PER NCRC SECTION R408.1.1 EXCEPTION.)

PROVIDE AN ACCESS OPENING. MINIMUM SIZE OF 18"X24" FOR CRAWL ACCESS. COORDINATE WITH MECHANICAL CONTRACTOR FOR LARGER SIZE REQUIREMENTS IF MECHANICAL EQUIPMENT IS LOCATED IN CRAWL. (PER NCRC SECTION 408.8)

-WOOD CONTACTING CONCRETE OR MASONRY OR LESS THAN CODE REQUIRED SEPARATION TO GRADE SHALL BE PRESSURE TREATED OR FOUNDATION GRADE REDWOOD. SET ALL EXTERIOR WALL SILLS IN MASTIC.

## REFER TO STRUCTURAL DRAWINGS FOR ALL FOUNDATION DIMENSIONS

FOU	INDATION KEYNOTE LEGEND
F1	LINE OF SLAB ABOVE
F2	LINE OF FRAMED WALL ABOVE
F6	TYPICAL CRAWL FOUNDATION WALL SHALL BE 8° CMU OR A COMBINATION OF 4° CMU WITH NOMINAL 4° BRICK. SEE STRUCTURAL DRAWINGS FOR ALL STRUCTURAL ATTACHMENTS. ALL BLOCK CELLS AND SPACE BETWEEN BLOCK AND BRICK SHALL BE FILLED WITH SOLID CONCRETE. FOUNDATION WALL WITH FULL HEIGHT BRICKVENEER SHALL CONSIST OF 8° CMU WITH NOMINAL 4° BRICK. SEE STRUCTURAL DRAWINGS FOR ALL STRUCTURAL ATTACHMENTS AND BRICK TIE SPACING. FILL VOIDS SOLID TO TOP OF CMU WALL. (MUST COMPLY WITH NCRC SECTION R404, TABLE R404,1.1(1) THROUGH R404,1.1(4) AND APPLICABLE SECTIONS OF R606, R607, R608.) VERIFY WITH STRUCTURAL DRAWINGS FOR WALL FOOTING SIZE AND DEFTH.

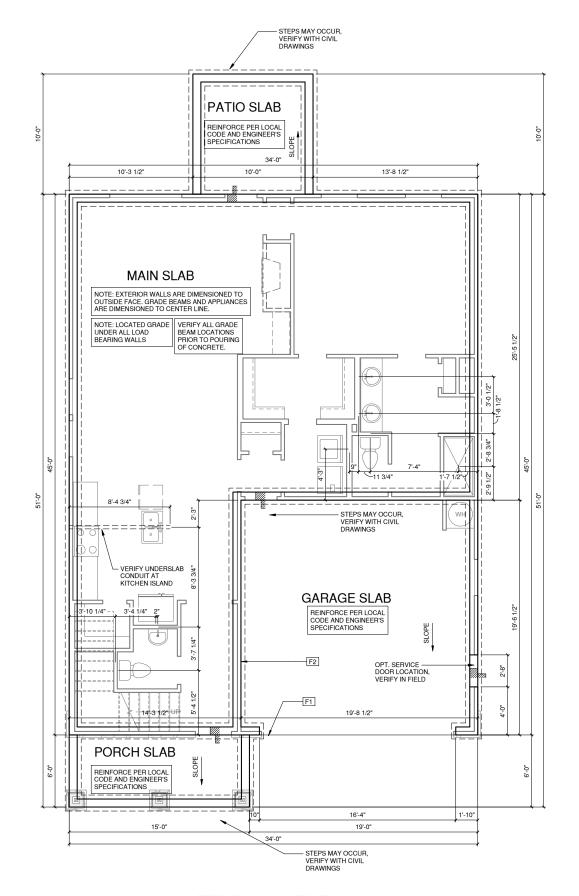





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NO:	DATE:	REVISION:

PROFESSIONAL SEAL:

PROJECT TITLE:

QUACKENBUSH HOMES LLC 9220 FAIRBANKS DR SUITE 240 RALEIGH, NC 27613 919-741-7993

CONSTRUCTION SET

CLIENTS NAME:

QUACKENBUSH HOMES

PROJECT NO:

JACKSON SHEET TITLE:

**STEMWALL** ELEV '3'

PRINT DATE: 01.03.17

SHEET NO:

A0.2.3

REFER TO STRUCTURAL DRAWINGS FOR INFORMATION NOT SHOWN ON THIS PLAN

FOR ADDITIONAL NOTES SEE GENERAL NOTES ON TITLE SHEET AND DETAILS.

PROVIDE FIREBLOCKING. (PER NCRC SECTION R602.8)

-ALL ELECTRICAL AND MECHANICAL EQUIPMENT AND METERS ARE SUBJECT TO RELOCATION DUE TO FIELD CONDITIONS, CONTRACTOR

-VERIFY ALL DOOR THRESHOLD HEIGHTS TO HARD S URFACES. 8 1/4" MAX AT INSWING DOORS. (PER NCRC SECTION R311.3.1)

-SLOPE ALL STOOPS AND HARDSCAPE MATERIAL AWAY FROM BUILDING - TYPICAL.

-SLOPE GARAGE FLOOR 1/8" PER FOOT TO GARAGE DOOR OPENING.

-VERIFY CURB CUT BLOCKOUT WITH GARAGE DOOR MANUFACTURER

-REFER TO CIVIL DRAWINGS FOR FINISH SURFACE ELEVATIONS.

-TYP. STOOP AT INSWING/SLIDER DOORS: 36" DEEP BY THE WIDTH OF THE DOOR SERVED, MINIMUM (PER NCRC SECTIONS R311.3) PROVIDE A SLIP-RESISTANT FINISH.

BORACARE TERMITE TO BE APPLIED TO FRAMING PER PRODUCT SPECIFICATIONS, (PROVIDE CHEMICAL TREATMENT FOR PROTECTION FROM TERMITE INVESTATION ACCORDING TO THE STANDARDS OF THE NC DEPT. OF AGRICULTURE.)

CROSS VENTILATION. (PER NCRC SECTION R408.1.1 EXCEPTION.)

1-AT VENTED CHAWL SPACE:
APPLY AN APPROVED VAPOR RETARDER OR EQUIVALENT, 6 MIL POLY-VINYL, GROUND COVER OVER FINISH GRADE OR CRAWL SPACE
PER NCRC SECTION 408.2


I -PROVIDE VENTS SPACED AROUND PERIMETER TO PROMOTE CROSS VENTILATION AT A RATE OF 1 SF VENT FOR EVERY 1500 SF OF CRAWL FLOOR AREA. ONE VENT MUST BE LOCATED WITHIN 3:0° OF EACH CORNER OF THE BUILDING AND LOCATED TO ALLOW FOR

-PROVIDE AN ACCESS OPENING, MINIMUM SIZE OF 18"X24" FOR CRAWL ACCESS, COORDINATE WITH MECHANICAL CONTRACTOR FOR LARGER SIZE REQUIREMENTS IF MECHANICAL EQUIPMENT IS LOCATED IN CRAWL. (PER NCRC SECTION 408.8)

-WOOD CONTACTING CONCRETE OR MASONRY OR LESS THAN CODE REQUIRED SEPARATION TO GRADE SHALL BE PRESSURE TREATED OR FOUNDATION GRADE REDWOOD. SET ALL EXTERIOR WALL SILLS IN MASTIC.

## REFER TO STRUCTURAL DRAWINGS FOR ALL FOUNDATION DIMENSIONS

FOL	INDATION KEYNOTE LEGEND
F1	LINE OF SLAB ABOVE
F2	LINE OF FRAMED WALL ABOVE
F6	TYPICAL CRAWL FOUNDATION WALL SHALL BE 8" CMU OR A COMBINATION OF 4" CMU WITH NOMINAL 4" BRICK. SEE STRUCTURAL DRAWINGS FOR ALL STRUCTURAL ATTACHMENTS. ALL BLOCK CELLS AND SPACE BETWEEN BLOCK AND BRICK SHALL BE FILLED WITH SOLID CONCRETE. FOUNDATION WALL WITH FULL HEIGHT BRICKVENEER SHALL CONSIST OF 8" CMU WITH NOMINAL 4" BRICK. SEE STRUCTURAL DRAWINGS FOR ALL STRUCTURAL ATTACHMENTS AND BRICK TIE SPACING. FILL VOIDS SOLID TO TOP OF CMU WALL. (MUST COMPLY WITH NCRC SECTION R404, TABLE R404.1.1(1) THROUGH R404.1.1(4) AND APPLICABLE SECTIONS OF R606, R607, R608.) VERIFY WITH STRUCTURAL DRAWINGS FOR WALL FOOTING SIZE AND DEFTH.

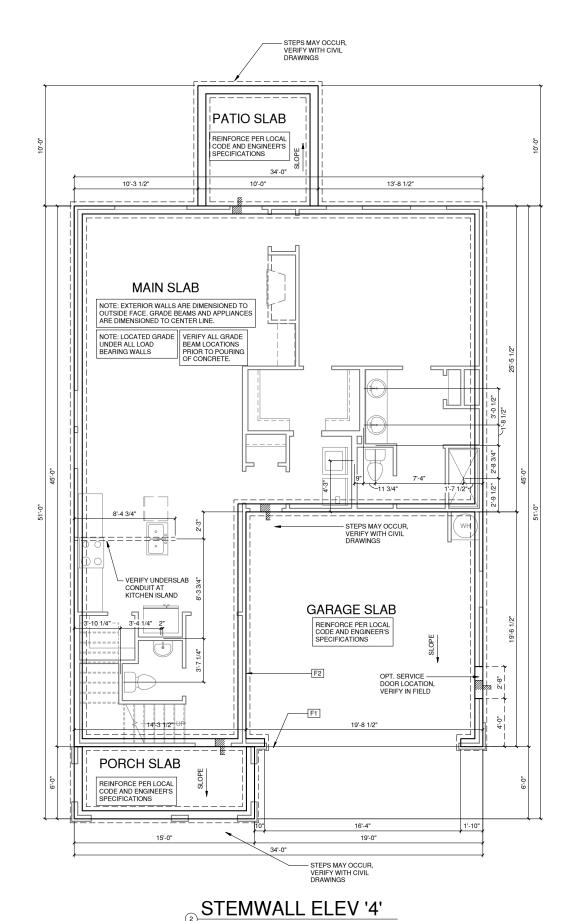

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NO:	DATE:	REVISION:

PROFESSIONAL SEAL:

PROJECT TITLE:

QUACKENBUSH HOMES LLC 9220 FAIRBANKS DR SUITE 240 RALEIGH, NC 27613 919-741-7993

CONSTRUCTION SET

CLIENTS NAME:

QUACKENBUSH HOMES

PROJECT NO:

JACKSON SHEET TITLE:

**STEMWALL** ELEV '4'

PRINT DATE:

01.03.17

-REFER TO STRUCTURAL DRAWINGS FOR INFORMATION NOT SHOWN ON THIS PLAN.

-FOR ADDITIONAL NOTES SEE GENERAL NOTES ON TITLE SHEET AND DETAILS.

-PROVIDE FIREBLOCKING, (PER NCRC SECTION R602.8)

-ALL ELECTRICAL AND MECHANICAL EQUIPMENT AND METERS ARE SUBJECT TO RELOCATION DUE TO FIELD CONDITIONS, CONTRACTOR TO VERIFY.

-SLOPE ALL STOOPS AND HARDSCAPE MATERIAL AWAY FROM BUILDING - TYPICAL.

-SLOPE GARAGE FLOOR 1/8" PER FOOT TO GARAGE DOOR OPENING.

VERIFY CURB CUT BLOCKOUT WITH GARAGE DOOR MANUFACTURER.

REFER TO CIVIL DRAWINGS FOR FINISH SURFACE ELEVATIONS.

-TYP. STOOP AT INSWING/SLIDER DOORS: 36" DEEP BY THE WIDTH OF THE DOOR SERVED,

MINIMUM (PER NCRC SECTIONS R311.3) PROVIDE A SLIP-RESISTANT FINISH.

BORACARE TERMITE TO BE APPLIED TO FRAMING PER PRODUCT SPECIFICATIONS. (PROVIDE CHEMICAL TREATMENT FOR PROTECTION FROM TERMITE INVESTATION ACCORDING TO THE STANDARDS OF THE NC DEPT. OF AGRICULTURE.)

AT VENTED CRAWL SPACE:
APPLY AN APPROVED VAPOR RETARDER OR EQUIVALENT, 6 MIL POLY-VINYL, GROUND COVER OVER FINISH GRADE OR CRAWL SPACE
PER NCRC SECTION 408.2


-PROVIDE VENTS SPACED AROUND PERIMETER TO PROMOTE CROSS VENTILATION AT A RATE OF 1 SE VENT FOR EVERY 1500 SE OF CRAWL FLOOR AREA. ONE VENT MUST BE LOCATED WITHIN 3-0" OF EACH CORNER OF THE BUILDING AND LOCATED TO ALLOW FOR CROSS VENTILATION. (PER NCRC SECTION R408.1.1 EXCEPTION.)

-PROVIDE AN ACCESS OPENING, MINIMUM SIZE OF 18"X24" FOR CRAWL ACCESS. COORDINATE WITH MECHANICAL CONTRACTOR FOR LARGER SIZE REQUIREMENTS IF MECHANICAL EQUIPMENT IS LOCATED IN CRAWL. (PER NCRC SECTION 408.8)

-WOOD CONTACTING CONCRETE OR MASONRY OR LESS THAN CODE REQUIRED SEPARATION TO GRADE SHALL BE PRESSURE TREATED OR FOUNDATION GRADE REDWOOD. SET ALL EXTERIOR WALL SILLS IN MASTIC.

## REFER TO STRUCTURAL DRAWINGS FOR ALL FOUNDATION DIMENSIONS

FOL	INDATION KEYNOTE LEGEND
F1	LINE OF SLAB ABOVE
F2	LINE OF FRAMED WALL ABOVE
F6	TYPICAL CRAWL FOUNDATION WALL SHALL BE 8" CMU OR A COMBINATION OF 4" CMU WITH NOMINAL 4" BRICK, SEE STRUCTURAL DRAWINGS FOR ALL STRUCTURAL ATTACHMENTS. ALL BLOCK CELLS AND SPACE BETWEEN BLOCK AND BRICK SHALL BE FILLED WITH SOLID CONCRETE. FOUNDATION WALL WITH FULL HEIGHT BRICKVENEER SHALL CONSIST OF 8" CMU WITH NOMINAL 4" BRICK. SEE STRUCTURAL DRAWINGS FOR ALL STRUCTURAL ATTACHMENTS AND BRICK TIE SPACING. FILL VOIDS SOLID TO TOP OF CMU WALL. (MUST COMPLY WITH NCRC SECTION R404. TABCH BE R404.1.1(4) ND APPLICABLE SECTIONS OF R806, R807, R608.) VERIFY WITH STRUCTURAL DRAWINGS FOR WALL FOOTING SIZE AND DEPTH.

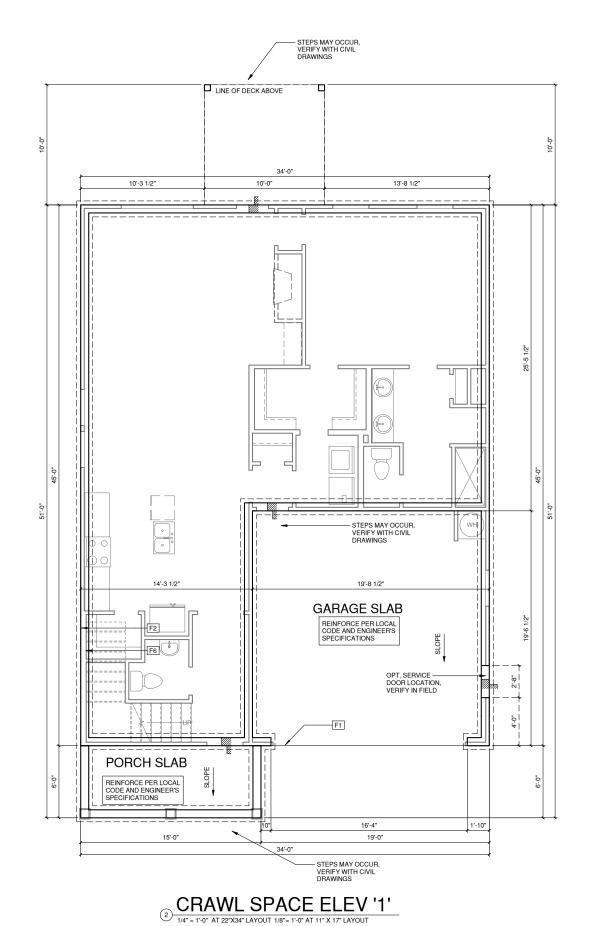

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NO:	DATE:	REVISION:

PROFESSIONAL SEAL:

PROJECT TITLE:

QUACKENBUSH HOMES LLC 9220 FAIRBANKS DR SUITE 240 RALEIGH, NC 27613 919-741-7993

CONSTRUCTION SET

CLIENTS NAME:

QUACKENBUSH HOMES

PROJECT NO:

SHEET TITLE:

JACKSON

**CRAWL SPACE** ELEV '1'

PRINT DATE:

01.03.17

REFER TO STRUCTURAL DRAWINGS FOR INFORMATION NOT SHOWN ON THIS PLAN.

-FOR ADDITIONAL NOTES SEE GENERAL NOTES ON TITLE SHEET AND DETAILS.

PROVIDE FIREBLOCKING. (PER NCRC SECTION R602.8)

-ALL ELECTRICAL AND MECHANICAL EQUIPMENT AND METERS ARE SUBJECT TO RELOCATION DUE TO FIELD CONDITIONS, CONTRACTOR TO VERIFY.

-VERIFY ALL DOOR THRESHOLD HEIGHTS TO HARD S URFACES 8 1/4" MAX AT INSWING DOORS. (PER NCRC SECTION R311.3.1)

SLOPE ALL STOOPS AND HARDSCAPE MATERIAL AWAY FROM BUILDING - TYPICAL

SLOPE GARAGE FLOOR 1/8" PER FOOT TO GARAGE DOOR OPENING.

VERIFY CURB CUT BLOCKOUT WITH GARAGE DOOR MANUFACTURER.

REFER TO CIVIL DRAWINGS FOR FINISH SURFACE ELEVATIONS.

-TYP. STOOP AT INSWING/SLIDER DOORS: 36" DEEP BY THE WIDTH OF THE DOOR SERVED, MINIMUM (PER NCRC SECTIONS R311.3) PROVIDE A SLIP-RESISTANT FINISH.

-SOILS TREATMENT:
BORACARE TERMITE TO BE APPLIED TO FRAMING PER PRODUCT SPECIFICATIONS. (PROVIDE CHEMICAL TREATMENT FOR PROTECTION FROM TERMITE INVESTATION ACCORDING TO THE STANDARDS OF THE NC DEPT. OF AGRICULTURE.)

-AT VENTED CRAWL SPACE: APPLY AN APPROVED VAPOR RETARDER OR EQUIVALENT, 6 MIL POLY-VINYL, GROUND COVER OVER FINISH GRADE OR CRAWL SPACE PER NCRC SECTION 408.2


-PROVIDE VENTS SPACED AROUND PERIMETER TO PROMOTE CROSS VENTILATION AT A RATE OF 1 SF VENT FOR EVERY 1500 SF OF CRAWL FLOOR AREA. ONE VENT MUST BE LOCATED WITHIN 3:-0" OF EACH CORNER OF THE BUILDING AND LOCATED TO ALLOW FOR CROSS VENTILATION. (PER NCRC SECTION R408.1.1 EXCEPTION.)

-PROVIDE AN ACCESS OPENING, MINIMUM SIZE OF 18"X24" FOR CRAWL ACCESS. COORDINATE WITH MECHANICAL CONTRACTOR FOR LARGER SIZE REQUIREMENTS IF MECHANICAL EQUIPMENT IS LOCATED IN CRAWL. (PER NCRC SECTION 408.8)

-WOOD CONTACTING CONCRETE OR MASONRY OR LESS THAN CODE REQUIRED SEPARATION TO GRADE SHALL BE PRESSURE TREATED OR FOUNDATION GRADE REDWOOD. SET ALL EXTERIOR WALL SILLS IN MASTIC.

## REFER TO STRUCTURAL DRAWINGS FOR ALL FOUNDATION DIMENSIONS

FOL	INDATION KEYNOTE LEGEND
F1	LINE OF SLAB ABOVE
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10:	DATE:	REVISION:

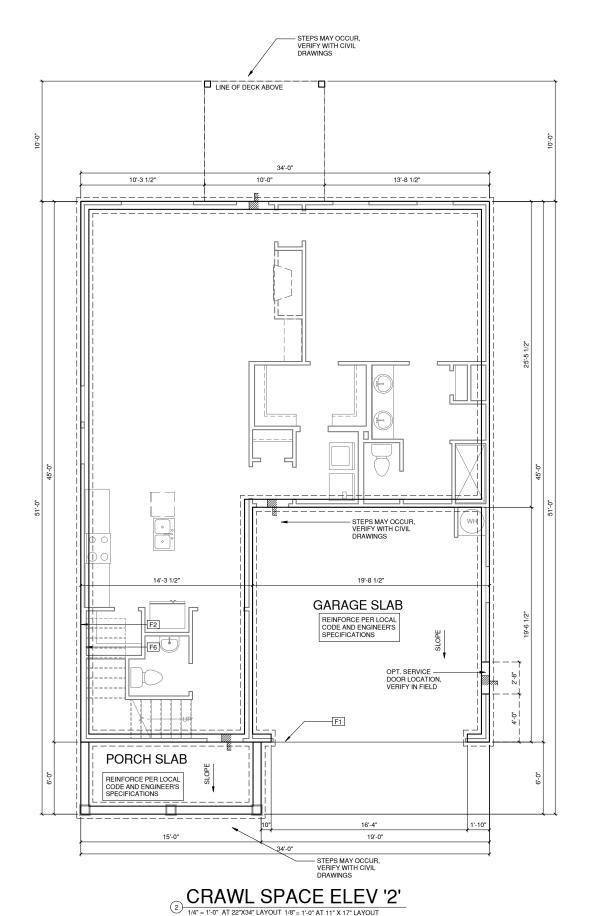PROFESSIONAL SEAL:

PROJECT TITLE:

QUACKENBUSH HOMES LLC 9220 FAIRBANKS DR SUITE 240 RALEIGH, NC 27613 919-741-7993

CONSTRUCTION SET

CLIENTS NAME:

QUACKENBUSH HOMES

PROJECT NO:

JACKSON SHEET TITLE:

**CRAWL SPACE ELEV '2'** 

PRINT DATE:

01.03.17

REFER TO STRUCTURAL DRAWINGS FOR INFORMATION NOT SHOWN ON THIS PLAN.

FOR ADDITIONAL NOTES SEE GENERAL NOTES ON TITLE SHEET AND DETAILS.

PROVIDE FIREBLOCKING, (PER NCRC SECTION R602.8)

-ALL ELECTRICAL AND MECHANICAL EQUIPMENT AND METERS ARE SUBJECT TO RELOCATION DUE TO FIELD CONDITIONS, CONTRACTOR TO VERIFY.

-VERIFY ALL DOOR THRESHOLD HEIGHTS TO HARD S URFACES. 8 1/4" MAX AT INSWING DOORS. (PER NCRC SECTION R311.3.1)

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-T VENTED CRAWL SPACE:
APPLY AN APPROVED VAPOR RETARDER OR EQUIVALENT, 6 MIL POLY-VINYL, GROUND COVER OVER FINISH GRADE OR CRAWL SPACE
PER NCRC SECTION 408.2


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PROVIDE AN ACCESS OPENING, MINIMUM SIZE OF 18"X24" FOR CRAWL ACCESS, COORDINATE WITH MECHANICAL CONTRACTOR FOR LARGER SIZE REQUIREMENTS IF MECHANICAL EQUIPMENT IS LOCATED IN CRAWL. (PER NCRC SECTION 408.8)

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NO:	DATE:	REVISION:

PROFESSIONAL SEAL:

PROJECT TITLE:

QUACKENBUSH HOMES LLC 9220 FAIRBANKS DR SUITE 240 RALEIGH, NC 27613 919-741-7993

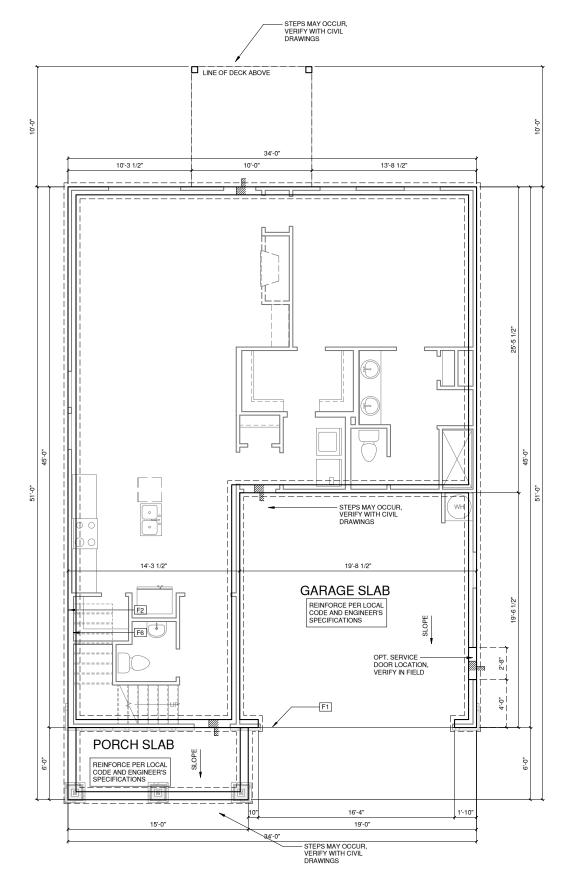CONSTRUCTION SET

CLIENTS NAME:

QUACKENBUSH HOMES

PROJECT NO:

SHEET TITLE:

JACKSON

**CRAWL SPACE** ELEV '3'

PRINT DATE:

01.03.17

REFER TO STRUCTURAL DRAWINGS FOR INFORMATION NOT SHOWN ON THIS PLAN.

FOR ADDITIONAL NOTES SEE GENERAL NOTES ON TITLE SHEET AND DETAILS.

-ALL ELECTRICAL AND MECHANICAL EQUIPMENT AND METERS ARE SUBJECT TO RELOCATION DUE TO FIELD CONDITIONS, CONTRACTOR TO VERIFY.

8 1/4" MAX AT INSWING DOORS. (PER NCRC SECTION R311.3.1

SLOPE ALL STOOPS AND HARDSCAPE MATERIAL AWAY FROM BUILDING - TYPICAL.

SLOPE GARAGE FLOOR 1/8" PER FOOT TO GARAGE DOOR OPENING.

VERIFY CURB CUT BLOCKOUT WITH GARAGE DOOR MANUFACTURER.

REFER TO CIVIL DRAWINGS FOR FINISH SURFACE ELEVATIONS.

-TYP. STOOP AT INSWING/SLIDER DOORS: 36° DEEP BY THE WIDTH OF THE DOOR SERVED, MINIMUM (PER NCRC SECTIONS R311.3) PROVIDE A SLIP-RESISTANT FINISH.

BORACARE TERMITE TO BE APPLIED TO FRAMING PER PRODUCT SPECIFICATIONS. (PROVIDE CHEMICAL TREATMENT FOR PROTECTION FROM TERMITE INVESTATION ACCORDING TO THE STANDARDS OF THE NC DEPT. OF AGRICULTURE.)

### -AT VENTED CRAWL SPACE:

APPLY AN APPROVED VAPOR RETARDER OR EQUIVALENT, 6 MIL POLY-VINYL, GROUND COVER OVER FINISH GRADE OR CRAWL SPACE


-PROVIDE VENTS SPACED AROUND PERIMETER TO PROMOTE CROSS VENTILATION AT A RATE OF 1 SF VENT FOR EVERY 1500 SF OF CRAWL FLOOR AREA. ONE VENT MUST BE LOCATED WITHIN 3-0" OF EACH CORNER OF THE BUILDING AND LOCATED TO ALLOW FOR CROSS VENTILATION. (PER NCRC SECTION R408.1.1 EXCEPTION.)

PROVIDE AN ACCESS OPENING, MINIMUM SIZE OF 18"X24" FOR CRAWL ACCESS. COORDINATE WITH MECHANICAL CONTRACTOR FOR LARGER SIZE REQUIREMENTS IF MECHANICAL EQUIPMENT IS LOCATED IN CRAWL. (PER NCRC SECTION 408.8)

-WOOD CONTACTING CONCRETE OR MASONRY OR LESS THAN CODE REQUIRED SEPARATION TO GRADE SHALL BE PRESSURE TREATED OR FOUNDATION GRADE REDWOOD. SET ALL EXTERIOR WALL SILLS IN MASTIC.

## REFER TO STRUCTURAL DRAWINGS FOR ALL FOUNDATION DIMENSIONS

FOL	JNDATION KEYNOTE LEGEND
F1	LINE OF SLAB ABOVE
F2	LINE OF FRAMED WALL ABOVE
F6	TYPICAL CRAWL FOUNDATION WALL SHALL BE 8° CMU OR A COMBINATION OF 4° CMU WITH NOMINAL 4° BRICK. SEE STRUCTURAL DRAWINGS FOR ALL STRUCTURAL ATTACHMENTS. ALL BLOCK OELLS AND SPACE BETWEEN BLOCK AND SRICK SHALL BE FILLED WITH SOLID CONCRETE. FOUNDATION WALL WITH FULL HEIGHT BRICKVENEER SHALL CONSIST OF 8° CMU WITH NOMINAL 4° BRICK. SEE STRUCTURAL DRAWINGS FOR ALL STRUCTURAL ATTACHMENTS AND BRICK TIE SPACING. FILL VOIDS SOLID TO TOP OF CMU WALL. (MUST COMPLY WITH NGRO SECTION R404, TABLE R404.1.1(1) THROUGH R404.1.1(4) AND APPLICABLE SECTIONS OF R606, R607, R606.) VERIFY WITH STRUCTURAL DRAWINGS FOR WALL FOOTING SIZE AND DEPTH.

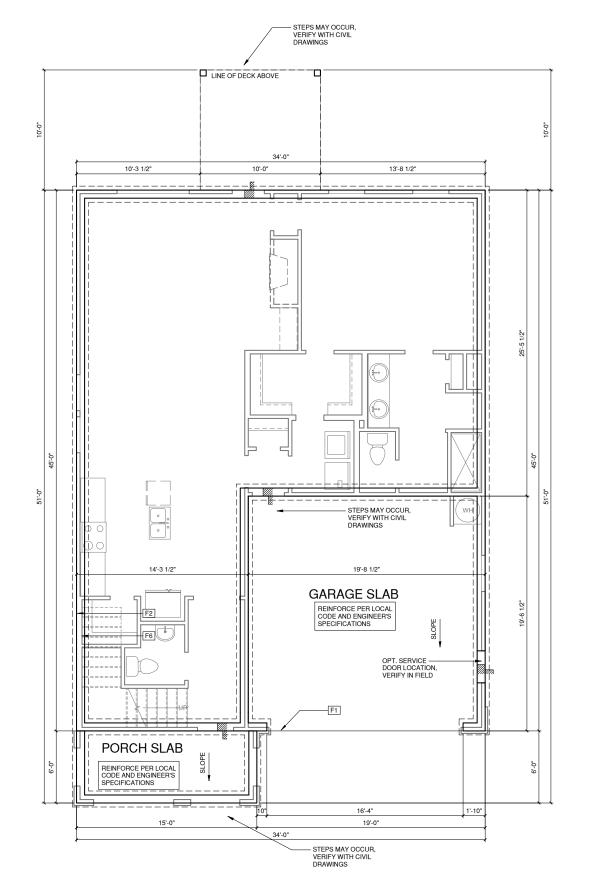





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NO:	DATE:	REVISION:

PROFESSIONAL SEAL:

PROJECT TITLE:

QUACKENBUSH HOMES LLC 9220 FAIRBANKS DR SUITE 240 RALEIGH, NC 27613 919-741-7993

CONSTRUCTION SET

CLIENTS NAME:

QUACKENBUSH HOMES

PROJECT NO:


SHEET TITLE:

JACKSON

**CRAWL SPACE** ELEV '4'

PRINT DATE:

01.03.17

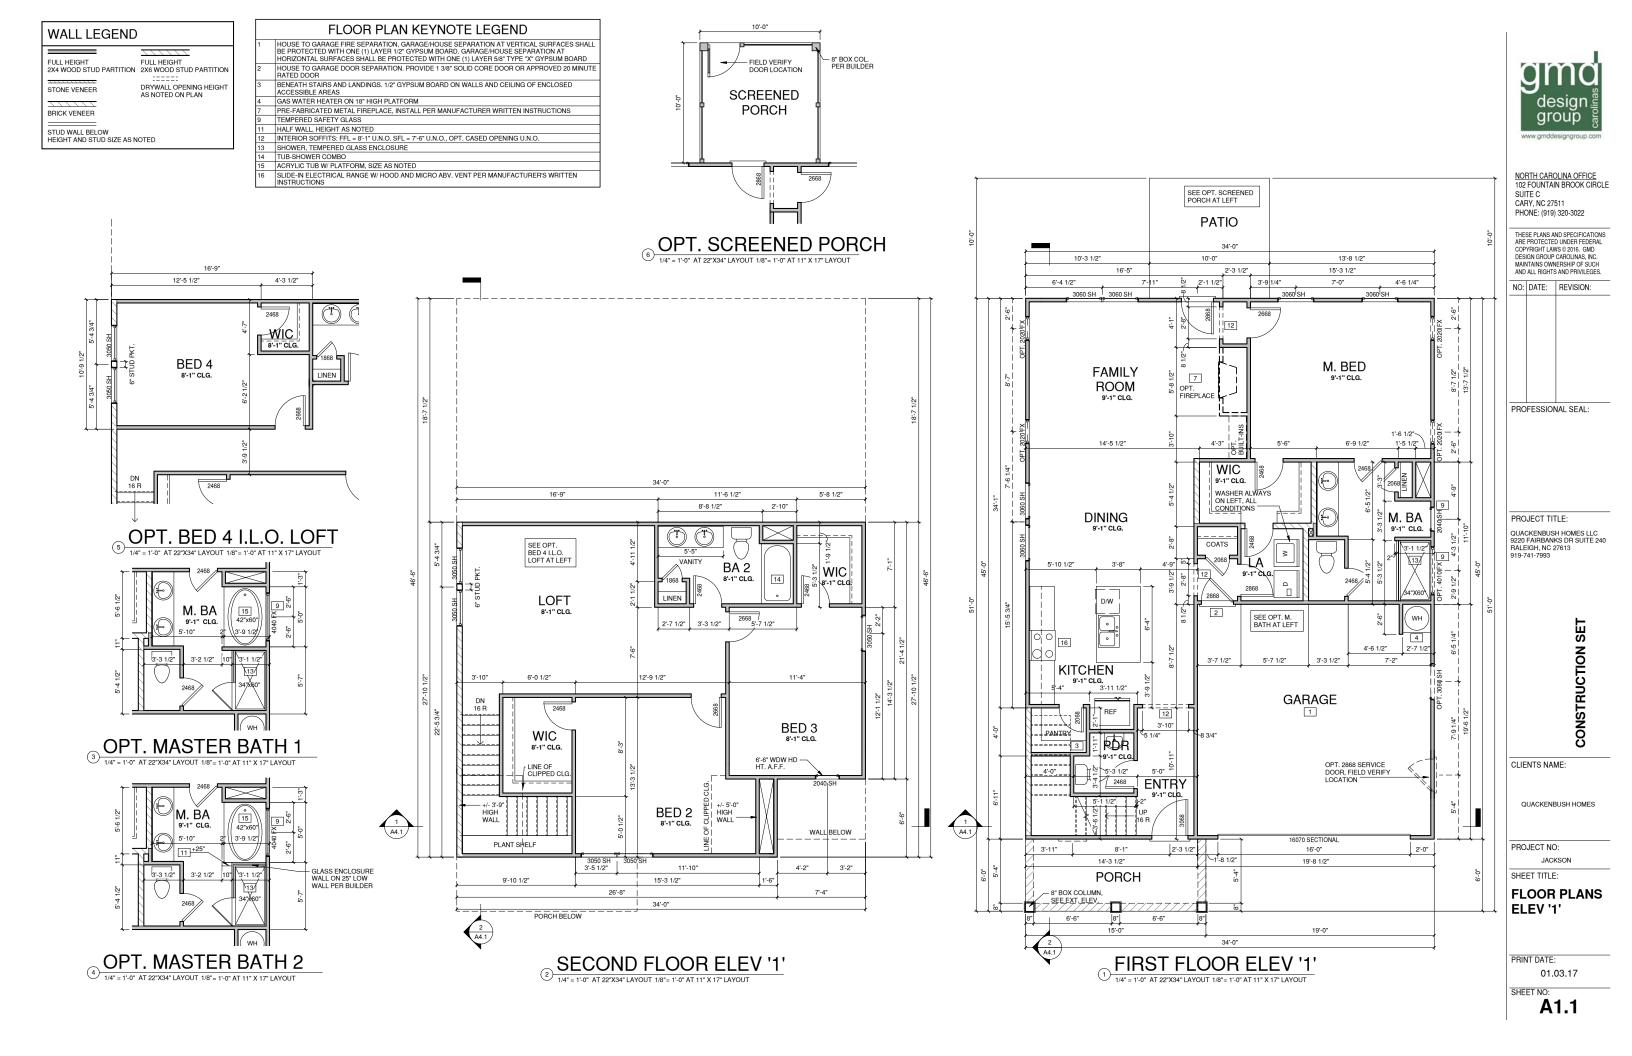


## WALL LEGEND


FULL HEIGHT FULL HEIGHT 2X4 WOOD STUD PARTITION 2X6 WOOD STUD PARTITION

DRYWALL OPENING HEIGHT AS NOTED ON PLAN STONE VENEER


BRICK VENEER

STUD WALL BELOW HEIGHT AND STUD SIZE AS NOTED

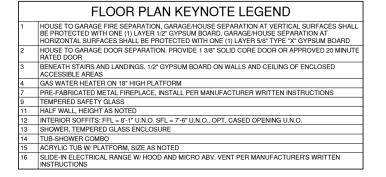

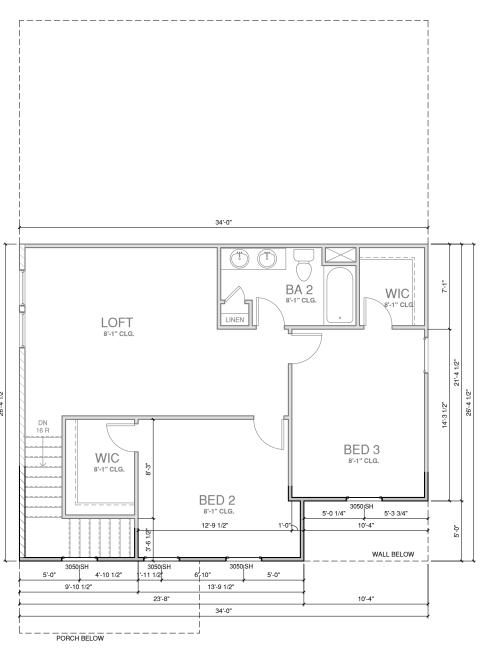

SECOND FLOOR ELEV '2' 1/4" = 1'-0" AT 22"X34" LAYOUT 1/8"= 1'-0" AT 11" X 17" LAYOUT

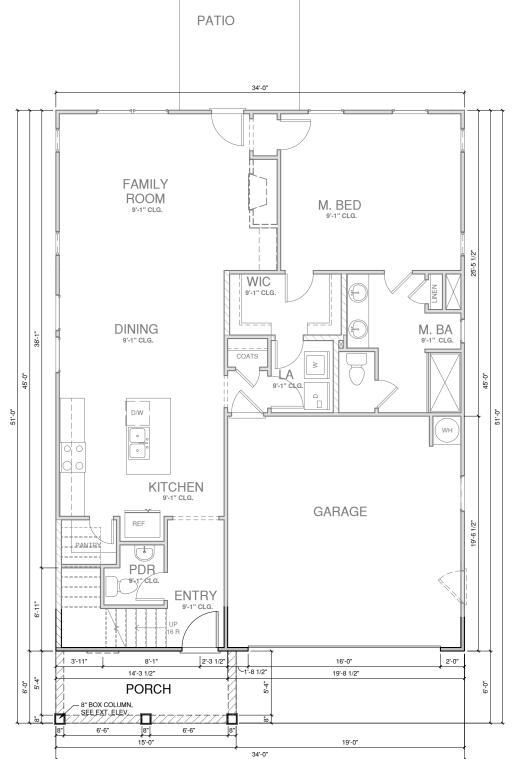

FIRST FLOOR ELEV '2'

2 1/4" = 1'-0" AT 22"X34" LAYOUT 1/8" = 1'-0" AT 11" X 17" LAYOUT



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CONSTRUCTION SET

CLIENTS NAME:

QUACKENBUSH HOMES

PROJECT NO:

JACKSON

SHEET TITLE: **FLOOR PLANS** 

ELEV '2'

PRINT DATE: 01.03.17

SHEET NO:

A1.2


## WALL LEGEND

FULL HEIGHT FULL HEIGHT 2X4 WOOD STUD PARTITION 2X6 WOOD STUD PARTITION STONE VENEER

BRICK VENEER

STUD WALL BELOW HEIGHT AND STUD SIZE AS NOTED

	FLOOR PLAN KEYNOTE LEGEND			
1	HOUSE TO GARAGE FIRE SEPARATION, GARAGE/HOUSE SEPARATION AT VERTICAL SURFACES SHALL BE PROTECTED WITH ONE (1) LAYER 1/2" GYPSUM BOARD. GARAGE/HOUSE SEPARATION AT HORIZONTAL SURFACES SHALL BE PROTECTED WITH ONE (1) LAYER 5/8" TYPE "X" GYPSUM BOARD			
2	HOUSE TO GARAGE DOOR SEPARATION. PROVIDE 1 3/8" SOLID CORE DOOR OR APPROVED 20 MINUTE RATED DOOR			
3	BENEATH STAIRS AND LANDINGS. 1/2" GYPSUM BOARD ON WALLS AND CEILING OF ENCLOSED ACCESSIBLE AREAS			
4	GAS WATER HEATER ON 18" HIGH PLATFORM			
7	PRE-FABRICATED METAL FIREPLACE, INSTALL PER MANUFACTURER WRITTEN INSTRUCTIONS			
9	TEMPERED SAFETY GLASS			
11	HALF WALL, HEIGHT AS NOTED			
12	INTERIOR SOFFITS: FFL = 8'-1" U.N.O. SFL = 7'-6" U.N.O., OPT. CASED OPENING U.N.O.			
13	SHOWER, TEMPERED GLASS ENCLOSURE			
14	TUB-SHOWER COMBO			
15	ACRYLIC TUB W/ PLATFORM, SIZE AS NOTED			
16	SLIDE-IN ELECTRICAL RANGE W/ HOOD AND MICRO ABV. VENT PER MANUFACTURER'S WRITTEN INSTRUCTIONS			

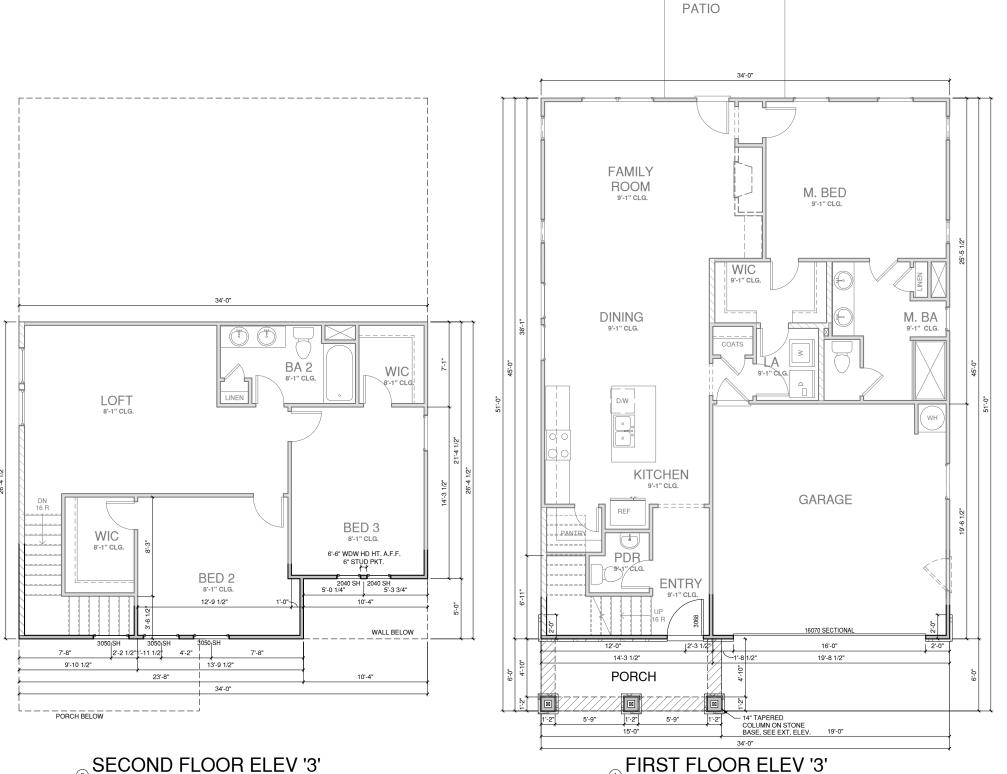

1/4" = 1'-0" AT 22"X34" LAYOUT 1/8"= 1'-0" AT 11" X 17" LAYOUT

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CONSTRUCTION SET

CLIENTS NAME:

QUACKENBUSH HOMES

PROJECT NO:

JACKSON SHEET TITLE:

**FLOOR PLANS ELEV '3'** 

PRINT DATE:

01.03.17

SHEET NO: A1.3

SECOND FLOOR ELEV '3'

## WALL LEGEND


FULL HEIGHT FULL HEIGHT 2X4 WOOD STUD PARTITION

DRYWALL OPENING HEIGHT AS NOTED ON PLAN STONE VENEER

BRICK VENEER

STUD WALL BELOW HEIGHT AND STUD SIZE AS NOTED



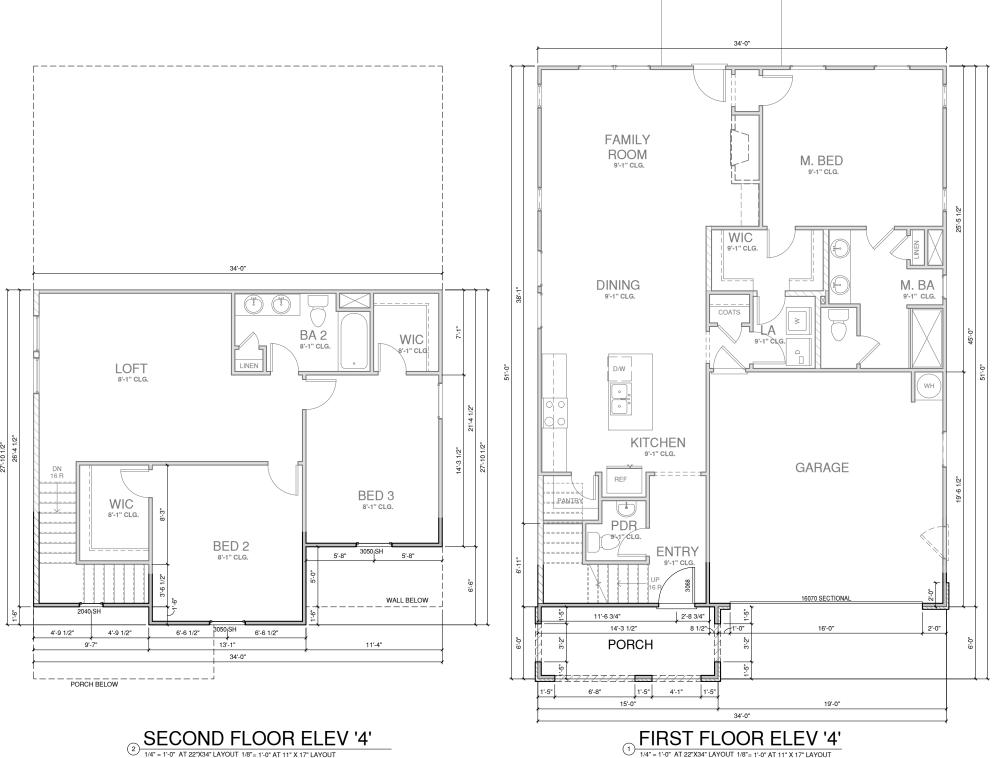

1/4" = 1'-0" AT 22"X34" LAYOUT 1/8"= 1'-0" AT 11" X 17" LAYOUT

PATIO

1/4" = 1'-0" AT 22"X34" LAYOUT 1/8" = 1'-0" AT 11" X 17" LAYOUT



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CONSTRUCTION SET

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PROJECT NO:


JACKSON

SHEET TITLE: **FLOOR PLANS** ELEV '4'


PRINT DATE:

01.03.17

SHEET NO: **A1.4** 

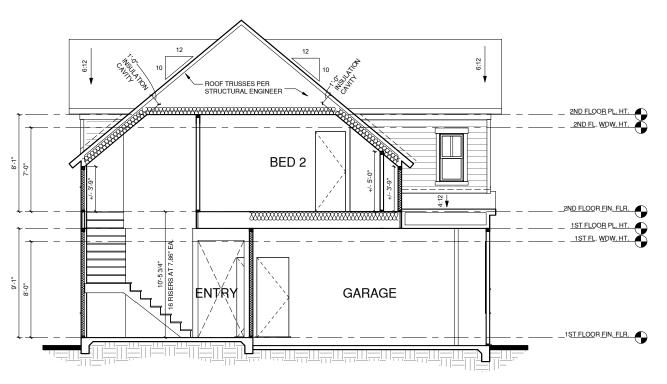

## $\bigcirc \frac{ \text{BUILDING SECTION 1} }{^{1/4^{+} = 1^{+}0^{+}} \text{ AT 22"X34" LAYOUT } 1/8^{+} = 1^{+}0^{+} \text{ AT } 11^{+} \text{ X } 17^{+} \text{ LAYOUT} } }$

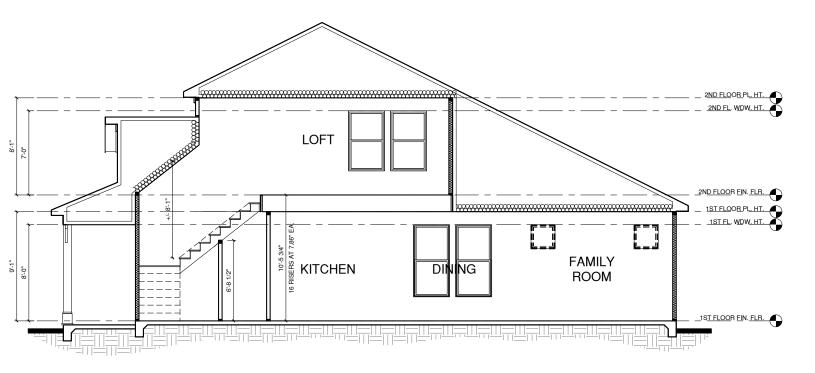

② BUILDING SECTION 2

1/4" = 1'-0" AT 22"X34" LAYOUT 1/8" = 1'-0" AT 11" X 17" LAYOUT



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CONSTRUCTION SET

CLIENTS NAME:

QUACKENBUSH HOMES

PROJECT NO: JACKSON


SHEET TITLE:

SECTIONS

PRINT DATE:


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SHEET NO:
A4.1

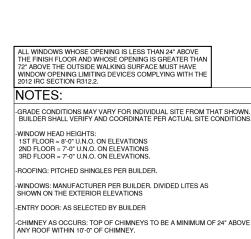

**ELEVATION KEYNOTE LEGEND** ADHERED STONE VENEER AS SELECTED BY DEVELOPER, HEIGHT AS NOTED FYPON OR EQUIVALENT LOUVERED VENT, SIZE AS NOTED CORROSION RESISTANT ROOF TO WALL FLASHING, CODE COMPLIANT FLASHING MUST BE INSTALLED AT ALL ROOF/WALL INTERSECTIONS

OPT. STANDING SEAM METAL ROOF, INSTALL PER MANUFACTURER'S WRITTEN INSTRUCTIONS E12 FIBER CEMENT SHAKE SIDING PER DEVELOPER W/ 5/4x4 CORNER TRIM BOARDS
E13 FIBER CEMENT LAP SIDING PER DEVELOPER W/ 5/4x4 CORNER TRIM BOARDS E15 FIBER CEMENT PANEL SIDING W/ 1X3 BATTS AT 12" O.C. (VINYL BOARD AND BATTEN SIDING) E16 1X FIBER CEMENT TRIM OR EQUAL, U.N.O. SIZE AS NOTED
E17 FALSE WOOD/VINYL SHUTTERS, TYPE AS SHOWN, SIZE AS NOTE

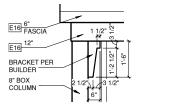


BRACKET DETAIL '1'


8" FASCIA E16 FACE OF WALL

EAVE DETAIL '1'

-ALL EXTERIOR MATERIALS TO BE INSTALLED PER MANUFACTURER'S WRITTEN INSTRUCTIONS. E16 FASCIA E17 28"X60" 6 A5.1 2ND FLOOR PL. HT. 2<u>ND FL. WDW</u>. <u>HT.</u> HEEL MIN. VERIFY V TRUSS MANUFACTI H ш 2ND FLOOR FIN. FLR.

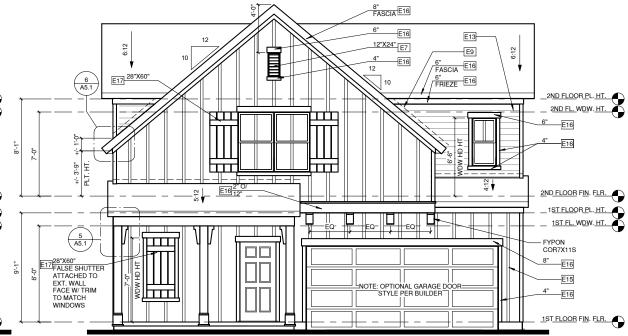

# 1ST FLOOR PL. HT. 1ST FL. WDW. HT. E13 1ST FLOOR FIN. FLR. LEFT ELEVATION '1'

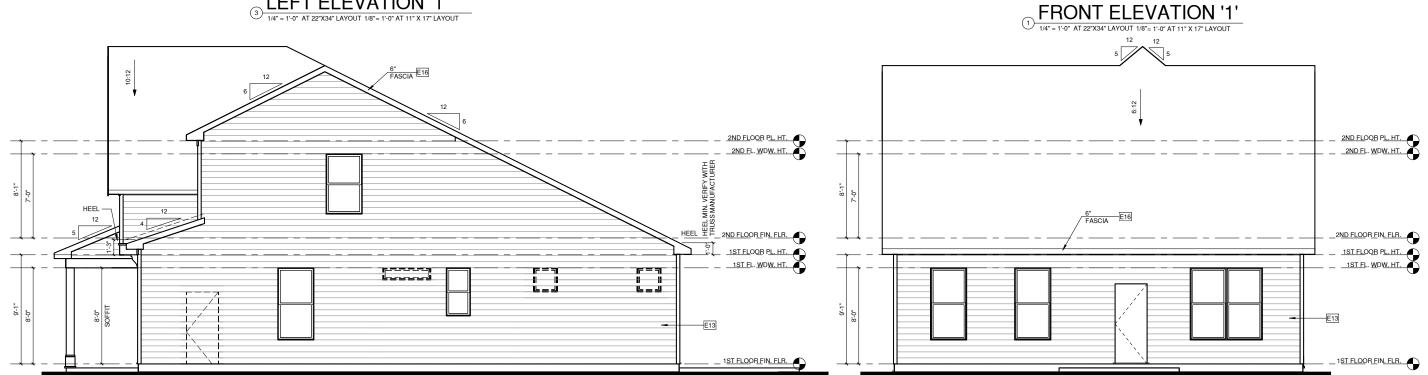

RIGHT ELEVATION '1'

1/4" = 1'-0" AT 22"X34" LAYOUT 1/8" = 1'-0" AT 11" X 17" LAYOUT

2 REAR ELEVATION '1'
1/4" = 1'-0" AT 22"X34" LAYOUT 1/8" = 1'-0" AT 11" X 17" LAYOUT

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CONSTRUCTION SET

CLIENTS NAME:

QUACKENBUSH HOMES

PROJECT NO: JACKSON

SHEET TITLE:

**ELEVATIONS** 

PRINT DATE: 01.03.17

SHEET NO:

**A5.1** 

ALL WINDOWS WHOSE OPENING IS LESS THAN 24" ABOVE THE FINISH FLOOR AND WHOSE OPENING IS GREATER THAN 72" ABOVE THE OUTSIDE WALKING SURFACE MUST HAVE WINDOW OPENING LIMITING DEVICES COMPLYING WITH THE 2012 IRC SECTION R312.2.

-GRADE CONDITIONS MAY VARY FOR INDIVIDUAL SITE FROM THAT SHOWN. BUILDER SHALL VERIFY AND COORDINATE PER ACTUAL SITE CONDITIONS

-WINDOW HEAD HEIGHTS: 1ST FLOOR = 8"-0" U.N.O. ON ELEVATIONS 2ND FLOOR = 7"-0" U.N.O. ON ELEVATIONS 3RD FLOOR = 7"-0" U.N.O. ON ELEVATIONS.

-ROOFING: PITCHED SHINGLES PER BUILDER.

-WINDOWS: MANUFACTURER PER BUILDER. DIVIDED LITES AS SHOWN ON THE EXTERIOR ELEVATIONS

-ENTRY DOOR: AS SELECTED BY BUILDER

-CHIMNEY AS OCCURS: TOP OF CHIMNEYS TO BE A MINIMUM OF 24" ABOVE ANY ROOF WITHIN 10'-0" OF CHIMNEY.

-ALL EXTERIOR MATERIALS TO BE INSTALLED PER MANUFACTURER'S WRITTEN INSTRUCTIONS.

### **ELEVATION KEYNOTE LEGEND**


- ADHERED STONE VENEER AS SELECTED BY DEVELOPER, HEIGHT AS NOTE
- FYPON OR EQUIVALENT LOUVERED VENT, SIZE AS NOTED

  CORROSION RESISTANT ROOF TO WALL FLASHING, CODE COMPLIANT FLASHING
  MUST BE INSTALLED AT ALL ROOF/WALL INTERSECTIONS
- OPT. STANDING SEAM METAL ROOF, INSTALL PER MANUFACTURER'S WRITTEI INSTRUCTIONS
- 12 FIBER CEMENT SHAKE SIDING PER DEVELOPER W/ 5/4x4 CORNER TRIM BOARDS 13 FIBER CEMENT LAP SIDING PER DEVELOPER W/ 5/4x4 CORNER TRIM BOARDS
- FIBER CEMENT PANEL SIDING W/ 1X3 BATTS AT 12" O.C. (VINYL BOARD AND BATTEN
- SIUING)
  E16 1X FIBER CEMENT TRIM OR EQUAL, U.N.O. SIZE AS NOTED
  E17 FALSE WOOD/VINYL SHUTTERS, TYPE AS SHOWN, SIZE AS NOTED

2ND FLOOR PL. HT. FASCIA E16 2ND FLOOR FIN. FLR. 1ST FLOOR PL. HT. 1ST FL. WDW. HT. 1ST FLOOR FIN. FLR.


REAR ELEVATION W/ OPT.

SCREENED PORCH 1/4" = 1'-0" AT 22"X34" LAYOUT 1/8"= 1'-0" AT 11" X 17" LAYOUT

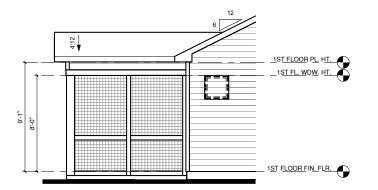

LEFT ELEVATION W/ OPT. SCREENED PORCH

(2) 1/4" = 1'-0" AT 297V24" | AVOLTY COTT

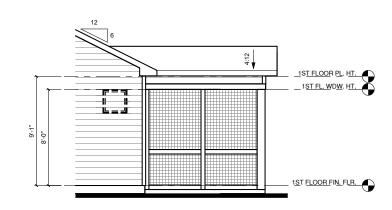

RIGHT ELEVATION W/ OPT. SCREENED PORCH



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CONSTRUCTION SET

CLIENTS NAME:

QUACKENBUSH HOMES

PROJECT NO:

JACKSON SHEET TITLE:

**ELEVATION** OPTIONS

PRINT DATE: 01.03.17

SHEET NO:

A5.1.1

GENERAL CONTRACTOR SHALL VERIFY THE NET FREE VENTILATION OF THE VENT PRODUCT SELECTED BY OWNER. VERIFY WITH MANUFACTURER OF HIGH AND LOW VENTS TO BE USED FOR MINIMUM CALCULATED VENTS REQUIRED. THE REQUIRED VENTILATION SHALL BE MAINTAINED. PROVIDE INSULATION STOP SUCH THAT INSULATION DOES NOT OBSTRUCT FREE AIR MOVEMENT AS REQUIRED BY THE BUILDING OFFICIAL.

ALL OVERLAP FRAMED ROOF AREAS SHALL HAVE OPENINGS BETWEEN THE ADJACENT ATTICS IN THE ROOF SHEATHING (AS ALLOWED BY THE STRUCTURAL ENGINEER) TO ALLOW PASSAGE AND ATTIC VENTILATION BETWEEN THE TWO OR ISOLATED ATTIC SPACES SHALL BE VENTED INDEPENDENTLY TO CBC REQUIREMENTS.

PER DEVELOPER, AT ALL CANTILEVERED FLOORS, CANTILEVERED ARCHITECTURAL POPOUTS, AND ANY DOUBLE FRAMING PROJECTIONS THAT ARE SEPARATED FROM THE VENTING CALCULATIONS SHOWN ABOVE, PROVIDE A CONTINUOUS 2' CORROSION RESISTANT SOFFIT VENT AT UNDERSIDE OF FRAMED ELEMENT.

## 1/300 RATIO:

AS AN ALTERNATE TO THE 1/150 RATIO LISTED, THE NET FREE CROSS-VENTILATION AREA MAY BE REDUCED TO 1/300 WHEN A VAPOR BARRIER IS HAVING A TRANSMISSION RATE NOT EXCEEDING I-PERM INSTALLED ON THE WARM-IN-WINTER SIDE OF THE CEILING.

GENERAL CONTRACTOR SHALL VERIFY THE NET FREE VENTILATION OF THE VENT PRODUCT SELECTED BY OWNER. VERIFY WITH MANUFACTURER OF HIGH AND LOW VENTS TO BE USED FOR MINIMUM CALCULATED VENTS REQUIRED. THE REQUIRED VENTILATION SHALL BE MAINTAINED. PROVIDE INSULATION STOP SUCH THAT INSULATION DOES NOT OBSTRUCT FREE AIR MOVEMENT AS REQUIRED BY THE BUILDING OFFICIAL.


ALL OVERLAP FRAMED ROOF AREAS SHALL HAVE OPENINGS BETWEEN THE ADJACENT ATTICS IN THE ROOF SHEATHING (AS ALLOWED BY THE STRUCTURAL ENGINEER) TO ALLOW PASSAGE AND ATTIC VENTILATION BETWEEN THE TWO OR ISOLATED ATTIC SPACES SHALL BE VENTED INDEPENDENTLY TO CBC REQUIREMENTS.

PER DEVELOPER, AT ALL CANTILEVERED FLOORS, CANTILEVERED ARCHITECTURAL POP-OUTS, AND ANY DOUBLE FRAMING PROJECTIONS THAT ARE SEPARATED FROM THE VENTING CALCULATIONS SHOWN ABOVE, PROVIDE A CONTINUOUS 2" CORROSION RESISTANT SOFFIT VENT AT UNDERSIDE OF FRAMED ELEMENT.

## NOTES:

- ALL ROOF DRAINAGE SHALL BE PIPED TO STREET OR APPROVED DRAINAGE FACILITY.
   DASHED LINES INDICATE WALL BELOW.
- DASHED LINES INDICATE WALL BELOW.
   LOCATE GUTTER AND DOWNSPOUTS PER BUILDER.
- PITCHED ROOFS AS NOTED.
- TRUSS MANUFACTURER SHALL SUBMIT STRUCTURAL CALCS AND SHOP DRAWING TO THE BUILDER'S GENERAL CONTRACTOR AND BUILDING DEPARTMENT FOR REVIEW PRIOR TO FABRICATIONS.
  ALL PLUMBING VENTS SHALL BE COMBINED INTO A MINIMUM AMOUNT OF ROOF PENETRATIONS. ALL ROOF PENETRATIONS SHALL OCCUR TO THE REAR OF THE MAIN RIDGE.

ROOF VENT CALC. ELEV. '1'				
Name	Area	1/300 RATIO AT HIGH & LOW	1/150 RATIO AT HIGH & LOW	
AREA 1	1533 SF	368.00 in <sup>2</sup>	736.00 in <sup>2</sup>	
AREA 2	68 SF	16.20 in <sup>2</sup>	32.40 in <sup>2</sup>	
AREA 3	37 SF	8.80 in <sup>2</sup>	17.60 in <sup>2</sup>	
AREA 4	100 SF	24.00 in <sup>2</sup>	48.00 in <sup>2</sup>	

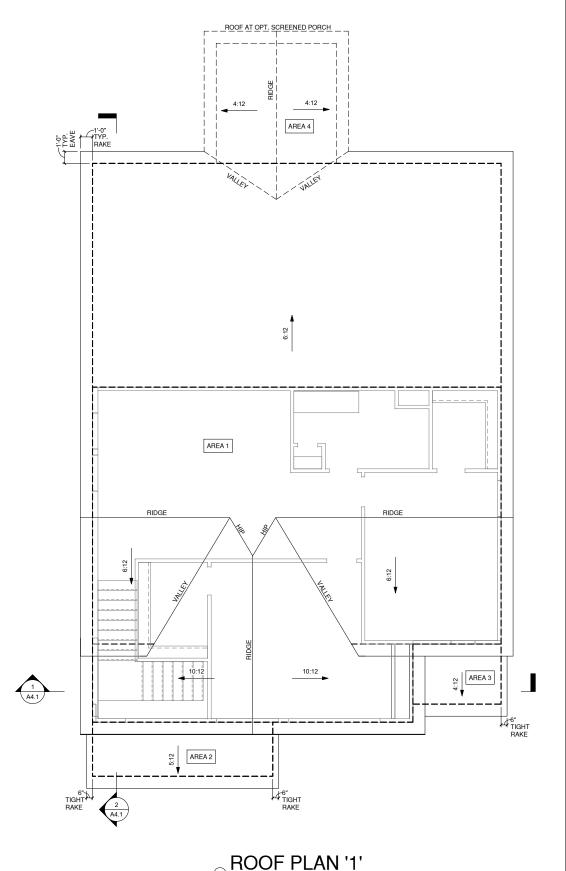

1/4" = 1'-0" AT 22"X34" LAYOUT 1/8" = 1'-0" AT 11" X 17" LAYOUT

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PROJECT TITLE:

QUACKENBUSH HOMES LLC 9220 FAIRBANKS DR SUITE 240 RALEIGH, NC 27613 919-741-7993

CONSTRUCTION SET

CLIENTS NAME:

QUACKENBUSH HOMES

PROJECT NO:

JACKSON SHEET TITLE:


**ROOF PLAN '1'** 

PRINT DATE:

01.03.17

SHEET NO:

A5.1.2

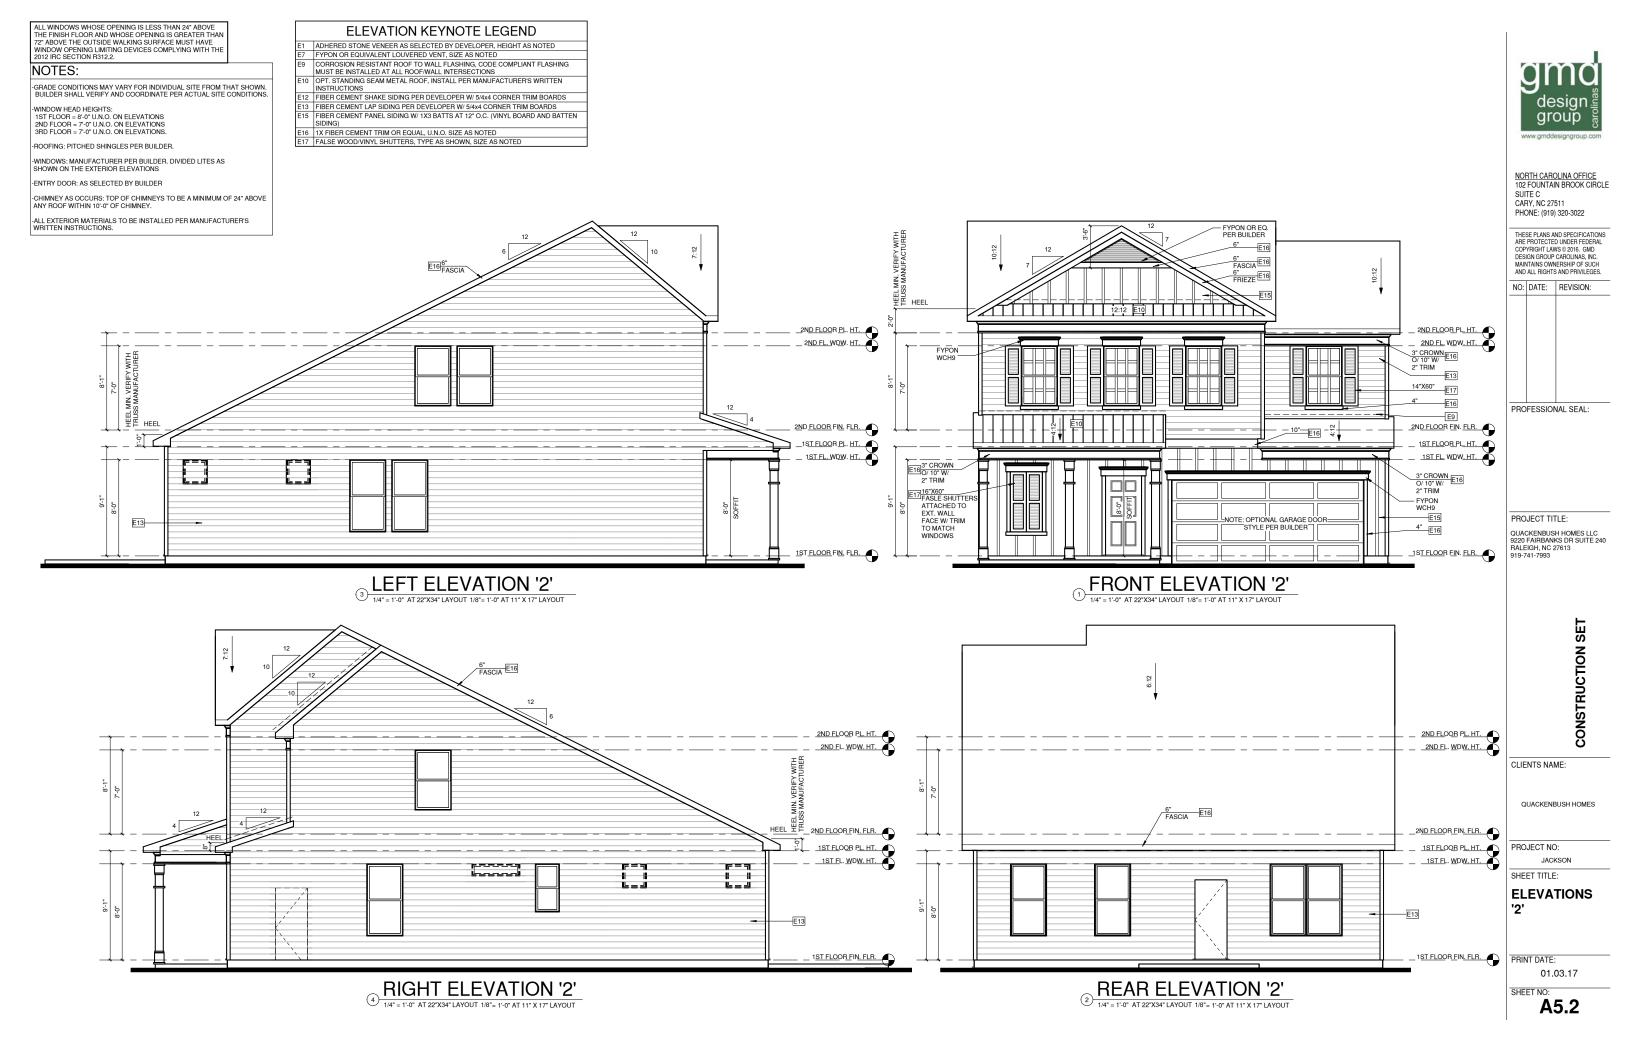

GENERAL CONTRACTOR SHALL VERIFY THE NET FREE VENTILATION OF THE VENT PRODUCT SELECTED BY OWNER. VERIFY WITH MANUFACTURER OF HIGH AND LOW VENTS TO MANUFACTURER OF HIGH AND LOW VENTS TO BE USED FOR MINIMUM CALCULATED VENTS REQUIRED. THE REQUIRED VENTILATION SHALL BE MAINTAINED. PROVIDE INSULATION STOP SUCH THAT INSULATION DOES NOT OBSTRUCT FREE AIR MOVEMENT AS REQUIRED BY THE BUILDING OFFICIAL.

ALL OVERLAP FRAMED ROOF AREAS SHALL HAVE OPENINGS BETWEEN THE ADJACENT ATTICS IN THE ROOF SHEATHING (AS ALLOWED BY THE STRUCTURAL ENGINEER) TO ALLOW PASSAGE AND ATTIC VENTILATION BETWEEN THE TWO OR ISOLATED ATTIC SPACES SHALL BE VENTED INDEPENDENTLY TO CBC REQUIREMENTS.

PER DEVELOPER, AT ALL CANTILEVERED FLOORS, CANTILEVERED ARCHITECTURAL POPOUTS, AND ANY DOUBLE FRAMING PROJECTIONS THAT ARE SEPARATED FROM THE VENTING CALCULATIONS SHOWN ABOVE, PROVIDE A CONTINUOUS 2" CORROSION RESISTANT SOFFIT VENT AT UNDERSIDE OF FRAMED ELEMENT.

## 1/300 RATIO:

AS AN ALTERNATE TO THE 1/150 RATIO LISTED, THE NET FREE CROSS-VENTILATION AREA MAY BE REDUCED TO 1/300 WHEN A VAPOR BARRIER IS HAVING A TRANSMISSION RATE NOT EXCEEDING I-PERM INSTALLED ON THE WARM-IN-WINTER SIDE OF THE CEILING.

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ALL OVERLAP FRAMED ROOF AREAS SHALL HAVE OPENINGS BETWEEN THE ADJACENT ATTICS IN THE ROOF SHEATHING (AS ALLOWED BY THE STRUCTURAL ENGINEER) TO ALLOW PASSAGE AND ATTIC VENTILATION BETWEEN THE TWO OR ISOLATED ATTIC SPACES SHALL BE VENTED INDEPENDENTLY TO CBC REQUIREMENTS.


PER DEVELOPER, AT ALL CANTILEVERED FLOORS, CANTILEVERED ARCHITECTURAL POP-OUTS, AND ANY DOUBLE FRAMING PROJECTIONS THAT ARE SEPARATED FROM THE VENTING CALCULATIONS SHOWN ABOVE, PROVIDE A CONTINUOUS 2" CORROSION RESISTANT SOFFIT VENT AT UNDERSIDE OF FRAMED ELEMENT.

## NOTES:

- ALL ROOF DRAINAGE SHALL BE PIPED TO STREET OR APPROVED DRAINAGE FACILITY.
   DASHED LINES INDICATE WALL BELOW.
   LOCATE GUTTER AND DOWNSPOUTS PER
- BUILDER.

  PITCHED ROOFS AS NOTED.
- TRUSS MANUFACTURER SHALL SUBMIT STRUCTURAL CALCS AND SHOP DRAWING TO THE BUILDER'S GENERAL CONTRACTOR AND BUILDING DEPARTMENT FOR REVIEW PRIOR TO FABRICATIONS.
  ALL PLUMBING VENTS SHALL BE COMBINED INTO A MINIMUM AMOUNT OF ROOP PENETRATIONS. ALL ROOP PENETRATIONS SHALL OCCUR TO THE REAR OF THE MAIN RIDGE.

ROOF VENT CALC. ELEV. '2'				
Name	Area	1/300 RATIO AT HIGH & LOW	1/150 RATIO AT HIGH & LOW	
AREA 1	1478 SF	354.80 in <sup>2</sup>	709.60 in <sup>2</sup>	
AREA 2	90 SF	21.60 in <sup>2</sup>	43.20 in <sup>2</sup>	
AREA 3	52 SF	12.40 in <sup>2</sup>	24.80 in <sup>2</sup>	
AREA 4	100 SF	24.00 in <sup>2</sup>	48.00 in <sup>2</sup>	

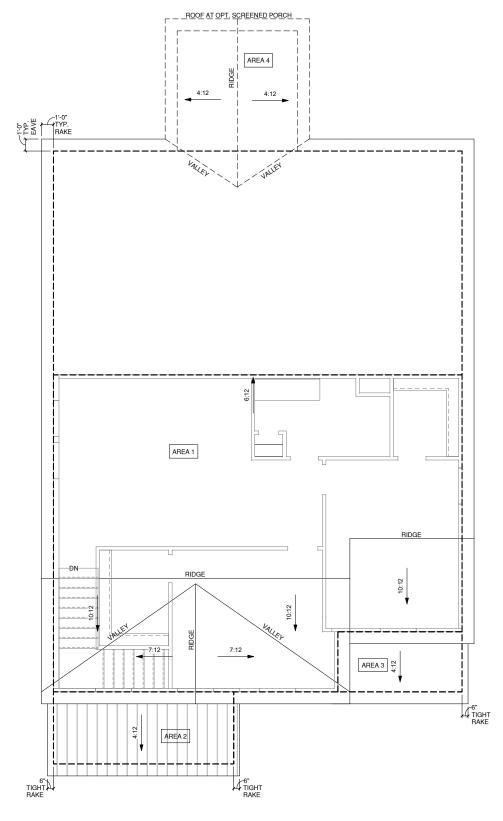

ROOF PLAN '2' 1/4" = 1'-0" AT 22"X34" LAYOUT 1/8"= 1'-0" AT 11" X 17" LAYOUT



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NO:	DATE:	REVISION:

PROFESSIONAL SEAL:

PROJECT TITLE:

QUACKENBUSH HOMES LLC 9220 FAIRBANKS DR SUITE 240 RALEIGH, NC 27613 919-741-7993

CONSTRUCTION SET

CLIENTS NAME:

QUACKENBUSH HOMES

PROJECT NO:


JACKSON SHEET TITLE:

**ROOF PLAN '2'** 

PRINT DATE: 01.03.17

SHEET NO:

A5.2.1

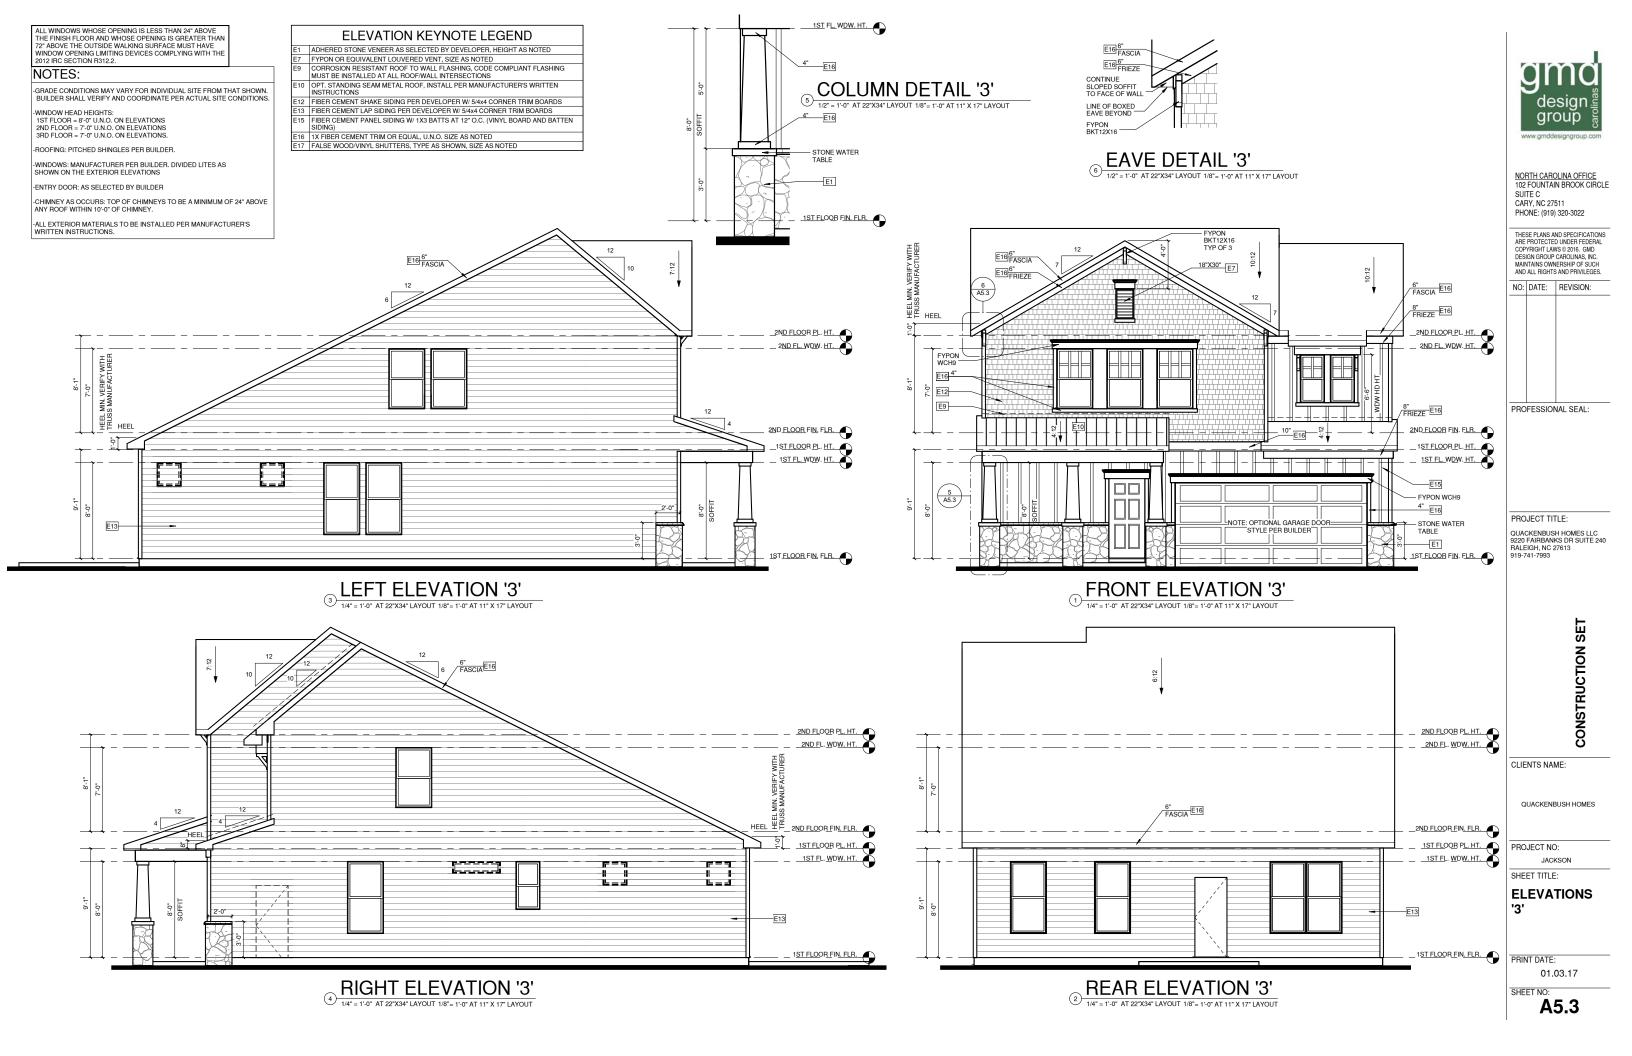

GENERAL CONTRACTOR SHALL VERIFY THE
NET FREE VENTILATION OF THE VENT PRODUCT
SELECTED BY OWNER. VERIFY WITH
MANUFACTURER OF HIGH AND LOW VENTS TO
BE USED FOR MINIMUM CALCULATED VENTS
REQUIRED. THE REQUIRED VENTILATION SHALL
BE MAINTAINED. PROVIDE INSULATION STOP
SUCH THAT INSULATION DOES NOT OBSTRUCT
EGES AIR MOVEMENT AS BEQUIRED BY THE FREE AIR MOVEMENT AS REQUIRED BY THE BUILDING OFFICIAL.

ALL OVERLAP FRAMED ROOF AREAS SHALL HAVE OPENINGS BETWEEN THE ADJACENT ATTICS IN THE ROOF SHEATHING (AS ALLOWED BY THE STRUCTURAL ENGINEER) TO ALLOW PASSAGE AND ATTIC VENTLATION BETWEEN THE TWO OR ISOLATED ATTIC SPACES SHALL BEVENLET INDEPENDENT IN CORNEL TO A STATE OF THE TWO OR ISOLATED ATTIC SPACES SHALL BEVENLET IN SPECIAL TO A STATE OF THE ACT. BE VENTED INDEPENDENTLY TO CBC REQUIREMENTS.

PER DEVELOPER, AT ALL CANTILEVERED FLOORS, CANTILEVERED ARCHITECTURAL POPOUTS, AND ANY DOUBLE FRAMING PROJECTIONS THAT ARE SEPARATED FROM THE VENTING CALCULATIONS SHOWN ABOVE, PROVIDE A CONTINUOUS 2" CORROSION RESISTANT SOFFIT VENT AT UNDERSIDE OF FRAMED ELEMENT.

1/300 RATIO:

AS AN ALTERNATE TO THE 1/150 RATIO LISTED, THE NET FREE CROSS-VENTILATION AREA MAY BE REDUCED TO 1/300 WHEN A VAPOR BARRIER IS HAVING A TRANSMISSION RATE NOT EXCEEDING I-PERM INSTALLED ON THE WARM-IN-WINTER SIDE OF THE CEILING.


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### NOTES:

- ALL ROOF DRAINAGE SHALL BE PIPED TO STREET OR APPROVED DRAINAGE FACILITY.
   DASHED LINES INDICATE WALL BELOW.
   LOCATE GUTTER AND DOWNSPOUTS PER
- BUILDER. PITCHED ROOFS AS NOTED.
- TRUSS MANUFACTURER SHALL SUBMIT STRUCTURAL CALCS AND SHOP DRAWING TO THE BUILDER'S GENERAL CONTRACTOR AND BUILDING DEPARTMENT FOR REVIEW PRIOR TO FABRICATIONS. ALL PLUMBING VENTS SHALL BE COMBINED INTO A MINIMUM AMOUNT OF ROOF PENETRATIONS. ALL ROOF PENETRATIONS SHALL OCCUR TO THE REAR OF THE MAIN RIDGE.
- ROOF VENT CALC. ELEV. '3' Area 1/300 RATIO AT HIGH & LOW 1/150 RATIO AT HIGH & LOW 1478 SF 90 SF 354.80 in<sup>2</sup> 709.60 in<sup>2</sup> 12.40 in<sup>2</sup> AREA 3 52 SF 24.80 in<sup>2</sup> 100 SF 24.00 in<sup>2</sup> 48.00 in<sup>2</sup>



1/4" = 1/4" AT COMP 13" 1/4" = 1'-0" AT 22"X34" LAYOUT 1/8"= 1'-0" AT 11" X 17" LAYOUT

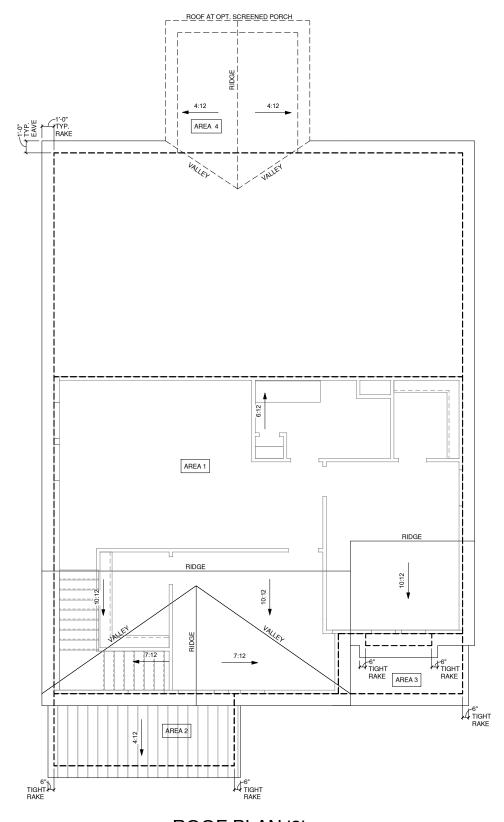

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PROFESSIONAL SEAL:

PROJECT TITLE:

QUACKENBUSH HOMES LLC 9220 FAIRBANKS DR SUITE 240 RALEIGH, NC 27613 919-741-7993

CONSTRUCTION SET

CLIENTS NAME:


QUACKENBUSH HOMES

PROJECT NO:

JACKSON SHEET TITLE:

**ROOF PLAN '3'** 

PRINT DATE: 01.03.17

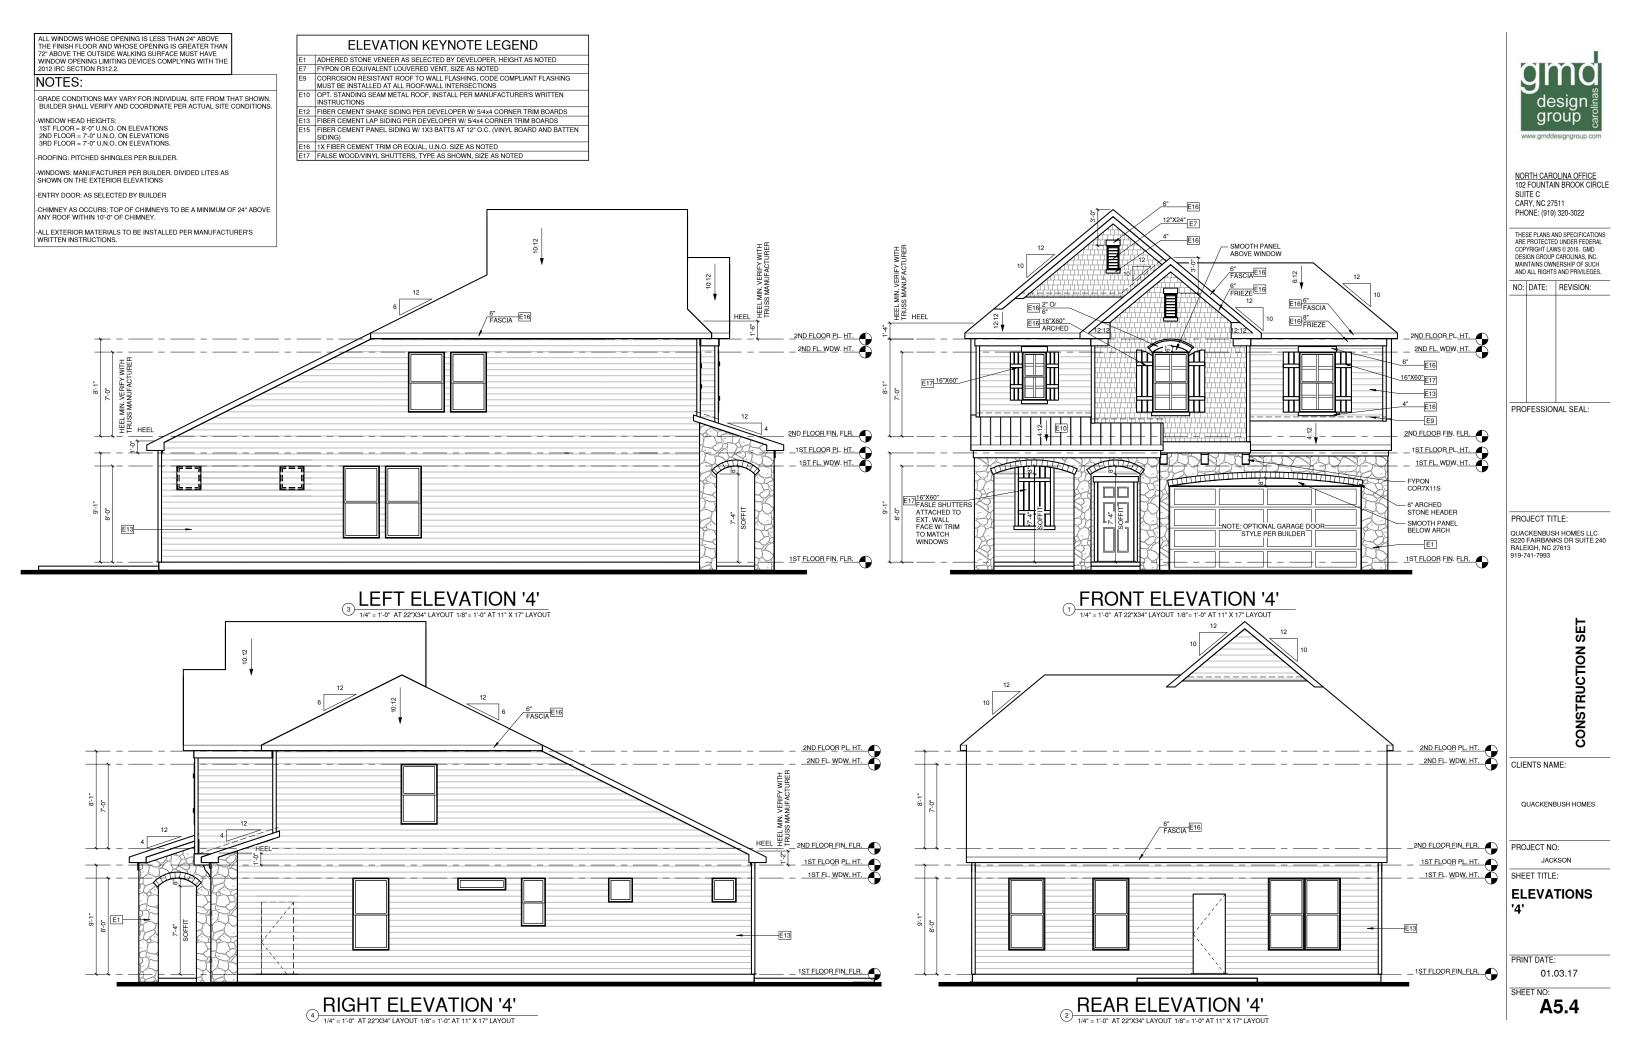

GENERAL CONTRACTOR SHALL VERIFY THE NET FREE VENTILATION OF THE VENT PRODUCT SELECTED BY OWNER. VERIFY WITH MANUFACTURER OF HIGH AND LOW VENTS TO BE USED FOR MINIMUM CALCULATED VENTS REQUIRED. THE REQUIRED VENTILATION SHALL BE MAINTAINED. PROVIDE INSULATION STOP SUCH THAT INSULATION DOES NOT OBSTRUCT EPEF AIR MOVEMENT AS BEQUIRED BY THE FREE AIR MOVEMENT AS REQUIRED BY THE BUILDING OFFICIAL.

ALL OVERLAP FRAMED ROOF AREAS SHALL HAVE OPENINGS BETWEEN THE ADJACENT ATTICS IN THE ROOF SHEATHING (AS ALLOWED BY THE STRUCTURAL ENGINEER) TO ALLOW PASSAGE AND ATTIC VENTILATION BETWEEN THE TWO OR ISOLATED ATTIC SPACES SHALL BE VENTED INDEPENDENTILY JO FOR BE VENTED INDEPENDENTLY TO CBC

PER DEVELOPER, AT ALL CANTILEVERED FLOORS, CANTILEVERED ARCHITECTURAL POPOUTS, AND ANY DOUBLE FRAMING PROJECTIONS THAT ARE SEPARATED FROM THE VENTING CALCULATIONS SHOWN ABOVE, PROVIDE A CONTINUOUS 2" CORROSION RESISTANT SOFFIT VENT AT UNDERSIDE OF FRAMED ELEMENT.

## 1/300 RATIO:

AS AN ALTERNATE TO THE 1/150 RATIO LISTED, THE NET FREE CROSS-VENTILATION AREA MAY BE REDUCED TO 1/300 WHEN A VAPOR BARRIER IS HAVING A TRANSMISSION RATE NOT EXCEEDING I-PERM INSTALLED ON THE WARM-IN-WINTER SIDE OF THE CEILING.

GENERAL CONTRACTOR SHALL VERIFY THE NET FREE VENTILATION OF THE VENT PRODUCT SELECTED BY OWNER. VERIFY WITH MANUFACTURER OF HIGH AND LOW VENTS TO BE USED FOR MINIMUM CALCULATED VENTS REQUIRED. THE REQUIRED VENTILATION SHALL BE MAINTAINED. PROVIDE INSULATION STOP SUCH THAT INSULATION DOES NOT OBSTRUCT FREE AIR MOVEMENT AS REQUIRED BY THE BUILDING OFFICIAL.

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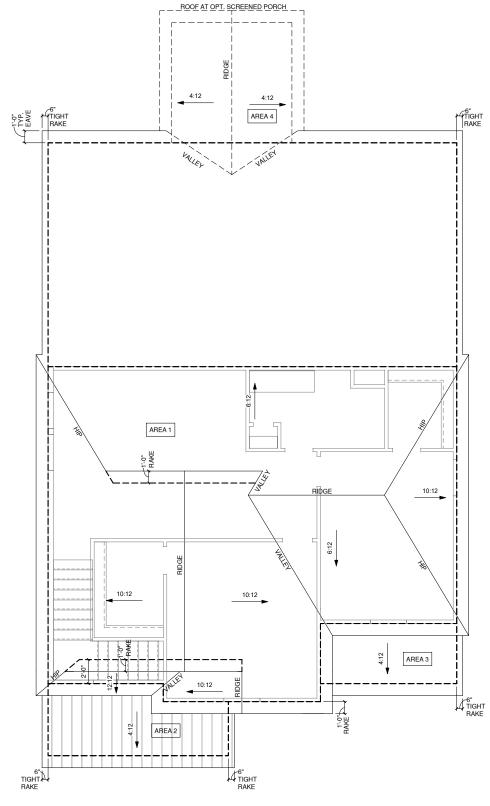
## NOTES:

- ALL ROOF DRAINAGE SHALL BE PIPED TO STREET OR APPROVED DRAINAGE FACILITY.

  DASHED LINES INDICATE WALL BELOW.

  LOCATE GUTTER AND DOWNSPOUTS PER
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- TRUSS MANUFACTURER SHALL SUBMIT STRUCTURAL CALCS AND SHOP DRAWING TO THE BUILDER'S GENERAL CONTRACTOR AND BUILDING DEPARTMENT FOR REVIEW PRIOR TO FABRICATIONS. ALL PLUMBING VENTS SHALL BE COMBINED INTO A MINIMUM AMOUNT OF ROOF PENETRATIONS. ALL ROOF PENETRATIONS SHALL GOOF PENETRATIONS SHALL OCCUR TO THE REAR OF THE MAIN RIDGE.

ROOF VENT CALC. ELEV. '4'				
Name	Area	1/300 RATIO AT HIGH & LOW	1/150 RATIO AT HIGH & LOW	
AREA 1	1493 SF	358.31 in <sup>2</sup>	716.62 in <sup>2</sup>	
AREA 2	82 SF	19.65 in <sup>2</sup>	39.30 in <sup>2</sup>	
AREA 3	57 SF	13.60 in <sup>2</sup>	27.20 in <sup>2</sup>	
AREA 4	100 SF	24.00 in <sup>2</sup>	48.00 in <sup>2</sup>	







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PROFESSIONAL SEAL:

PROJECT TITLE:

QUACKENBUSH HOMES LLC 9220 FAIRBANKS DR SUITE 240 RALEIGH, NC 27613 919-741-7993

CONSTRUCTION SET

CLIENTS NAME:

QUACKENBUSH HOMES

PROJECT NO:

JACKSON SHEET TITLE:


**ROOF PLAN '4'** 

PRINT DATE:


01.03.17

SHEET NO:

A5.4.1

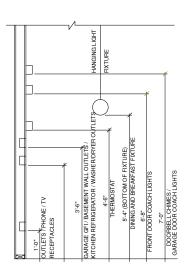


## STANDARD ELECTRICAL BOX HEIGHTS

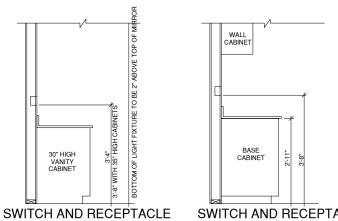

## SWITCH AND RECEPTACLE BOXES OVER BATH CABINETS BOXES OVER KITCHEN CABINETS

### NOTES: -PROVIDE GROUNDING ELECTRICAL ROD PER LOCAL CODES. -PROVIDE AND INSTALL ARC FAULT CIRCUIT-INTERRUPTERS (AFCI) AS REQUIRED BY NATIONAL ELECTRICAL CODE (NEC) AND MEETING THE REQURIEMENTS OF ALL GOVERNING CODES. -ALL EXHAUST FANS SHALL HAVE BACKDRAFT DAMPERS -FAN/LIGHTS IN WET/DAMP LOCATIONS SHALL BE LABLED "SUITABLE FOR WET OR DAMP LOCATIONS." -FLECTRICAL SYSTEMS ARE SHOWN FOR INTENT ONLY, THESE SYSTEMS SHALL BE ENGINEERED BY PROVIDE AND INSTALL LOCALLY CERTIFIED SMOKE DETECTORS AND CO2 DETECTORS AS REQUIRED BY NATIONAL FIRE PROTECTION ASSOCIATION (NFPA) AND MEETING THE REQUIREMENTS OF ALL GOVERNING CODES. -PROVIDE AND INSTALL GROUND FAULT CIRCUIT-INTERRUPTERS (GFI) AS REQUIRED BY NATIONAL ELECTRICAL CODE (NEC) AND MEETING THE REQUIREMENTS OF ALL GOVERNING CODES. -ELECTRICAL CONTRACTOR TO PROVIDE REQURIED DIRECT HOOK-UPS/CUTOFFS -HVAC CONTRACTOR TO VERIFY THERMOSTAT LOCATIONS. -ALL ELECTRICAL AND MECHANICAL EQUIPMENT (FURNACES, A/C UNITS, ELECTRICAL PANELS, SANITARY SUMP PITS, DRAING TILE SUMP, AND WATER HEATERS) ARE SUBJECT TO RELOCATOIN DUE TO FIELD CONDITIONS. -PROVIDE POWER, LIGHT AND SWITCH AS REQUIRED FOR ATTIC FURNACE PER CODE AND MANUFACTURER'S WRITTEN INSTRUCTIONS. LEGEND: DUPLEX OUTLET CELLING MOLINTED INCANDESCENT LIGHT FIXTURE OWP/GFI WEATHERPROOF GFI DUPLEX OUTLET WALL MOUNTED INCANDESCENT LIGHT FIXUTRE GROUND-FAULT CIRCUIT-INTERRUPTER DUPLEX OUTLET RECESSED INCANDESCENT LIGHT FIXTURE (VP) = VAPOR PROOF HALF-SWITCHED DUPLEX OUTLET EXHAUST FAN (VENT TO EXTERIOR) 220 VOLT OUTLET EXHAUST FAN/LIGHT COMBINATION (VENT TO EXTERIOR) REINFORCED JUNCTION BOX WALL SWITCH FLUORESCENT LIGHT FIXTURE THREE-WAY SWITCH TECH HUB SYSTEM FOUR-WAY SWITCH CHIMES CEILING FAN (PROVIDE ADEQUATE SUPPORT) PUSHBUTTON SWITCH 110V SMOKE DETECTOR CEILING FAN WITH INCANDESCENT LIGHT FIXTURE (PROVIDE ADEQUATE SUPPORT) W/ BATTERY BACKUP CO2 DETECTOR THERMOSTAT TELEPHONE HB HOSE BIBB TV TELEVISION ELECTRIC METER → WALL SCONCE

DISCONNECT SWITCH

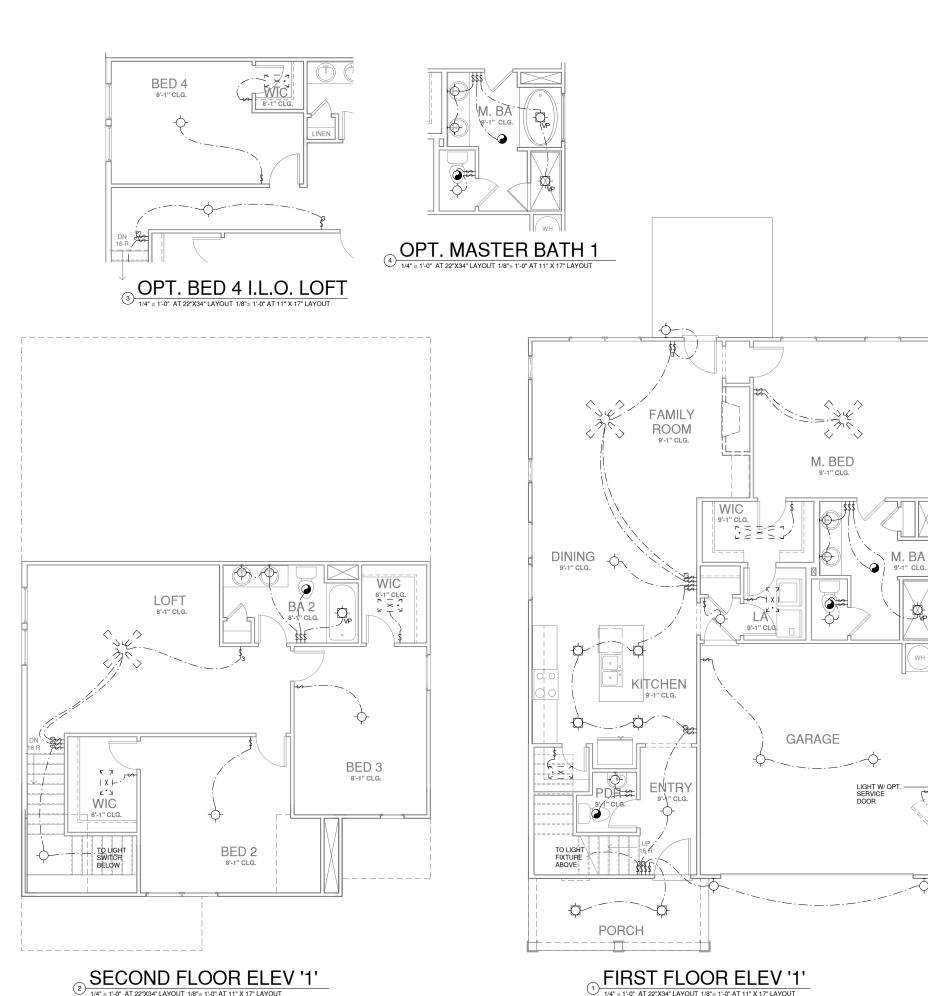

group

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CONSTRUCTION SET

CLIENTS NAME:

QUACKENBUSH HOMES

PROJECT NO:

JACKSON

SHEET TITLE:

**UTILITY PLANS** 

PRINT DATE:

01.03.17

SHEET NO: E1.0