ABBREVIATIONS INDEX ABV ABOVE A/C AIR CONDITIONING A.D. AREA DRAIN ADJ ADJUSTABLE ALT ALTERNATE ALUMIALUMINUM ADCIL ARCHITECTURAL L LENGTH LA LAUNDRY LAV LAVATORY LVR LOUVER MAX MAXIMUM MECH MECHANICAL MFR. MANUFACTURER MIN MINIMUM MISC MISCELLANEOUS SLAB ELEV '1' SLAB ELEV '2' A0.1.2 A0.1.4 SLAB ELEV '4' MISC MISCELLANEOUS N. NOTIO SCALE O.G.D. OVERHEAD GRAGE DOOR OOF OPTIONAL PAR PARALLE PAB PUSH BUTTON POR POWDER PED PLESTAL PL PLATE PE PAR BLDG BUILDING BLK BLOCK (CMUs) BLW BELOW BM BEAM BP BI-PASS (DOOR) STEM WALL ELEV '1 A0.2.1 A0.2.2 STEM WALL ELEV '2' A0.2.3 STEM WALL ELEV '3' BOT BOTTOM BTWN BETWEEN A0 3 1 CRAWL SPACE FLEV '1 CAB CABINET CER CERAMIC CRAWL SPACE ELEV '2' CER SERAMS CL CONTROL JOINT OR CONSTRUCTION JOINT CL CLOSST OR CENTER LINE COLL COLUMN COLL COLUMN CONC COUNCRETE CAPPEND OR RESISTANT COST CAPPEND A0.3.2 CRAWL SPACE ELEV '3' PR PAIR P.T. PRESSURE TREATED WOOD PVC POLYVINYL CHLORIDE PIPE PWT PAVEMENT PW. PREWIRE PWD PLYWOOD R BISER RAG RETURN AIR GRILL DEE GEEERS MORE A0.3.4 CRAWL SPACE ELEV '4 FLOOR PLANS ELEV '2' FLOOR PLANS ELEV '3 REF REFERENCE REFR REFRIGERATOR REQ REQUIRED FLOOR PLANS ELEV '4' A15 FLOOR PLAN OPTIONS AND THE PERSON OF THE PERSON O SECTIONS ELEVATIONS '1' A5.1.1 FLEV OPTIONS ROOF PLAN '1' A5.2 FLEVATIONS '2' A5.2.1 ROOF PLAN '2' E AST ELEV ELEVATION ELEV ELEVATION ELEV ELEVATION ED COURTICAL ED COU ELEVATIONS '3 SYM SYMBOL SYM SYMBOL SYM SYMBOL T TREAD (AT STAIRS) OR TILE T.B. TOWEL BAR TEMPETER (GLACC) A5 3 1 BOOF PLAN '3' ELEVATIONS '4' A5.4 TEMP. TEMPERED (GLASS) T&G TONGUE & GROOVE T.O.C. TOP OF CURB TV TELEVISION TYP TYPICAL A5.4.1 ROOF PLAN '4' FIRST FLOOR UTILITY PLAN F1.0 II N O LINI ESS NOTED OTHERWISE V.B. VAPOR BARRIER VERT VERTICAL V.T.R. VENT THRU ROOF V.T.R. VENTTHRU ROOF W. WASHING MACHINE WDW WINDOW WH WATER HEATER WI WROUGHT IRON WIC WALK-IN CLOSET W/WO WITH OR WITHOUT WIP WATERPROCEING! WP WATERPROOF(ING) WWM WELDED WIRE MESH R PROPERTY LINE 0 ROUND / DIAMETER & AND C. CENTERLINE # POUND / NUMBER BUILDING CODE COMPLIANCE PROJECT INFORMATION ALL CONSTRUCTION TO COMPLY WITH LOCAL CODES AND ORDINANCES ALL CONSULTANT DRAWINGS ACCOMPANYING THESE GMD DESIGN GROUP DRAWINGS HAVE NOT BEEN CURRENTLY IN USE WITH THE LOCAL JURISDICTION. PREPARED BY OR LINDER THE DIRECTION OF GMD DESIGN GROUP, INC. GMD DESIGN GROUP INC. THEREFORE ASSUMES NO LIABILITY FOR THE COMPLETENESS OR CORRECTNESS OF THESE DRAWINGS. FOLLOW ALL APPLICABLE STATE AND LOCAL CODES. 2012 NORTH CAROLINA STATE SUPPLEMENTS AND AMENDMENTS CONTRACTOR AND BUILDER SHALL REVIEW ENTIRE PLAN TO VERIFY CONFORMANCE WITH ALL CURRENT APPLICABLE CODES IN EFFECT AT TIME OF CONSTRUCTION. BY USING THESE DRAWINGS FOR CONSTRUCTION IT IS

JEREMIAH

PLAN 2611

ELEV. '1	I' AREA	ELEV. '2	' AREA	ELEV. '3	B' AREA	ELEV. '4	' AREA
Name	Area	Name	Area	Name	Area	Name	Area
FIRST FLOOR	1126 SF						
SECOND FLOOR	1484 SF	SECOND FLOOR	1504 SF	SECOND FLOOR	1495 SF	SECOND FLOOR	1490 SF
HEATED	2611 SF	HEATED	2631 SF	HEATED	2621 SF	HEATED	2616 SF
GARAGE	387 SF	GARAGE	407 SF	GARAGE	407 SF	GARAGE	407 SF
PATIO/SCREENED PORCH	100 SF	PATIO/SCREENED PORCH		PATIO/SCREENED PORCH	100 SF	PATIO/SCREENED PORCH	100 SF
PORCH	83 SF	PORCH	82 SF	PORCH	82 SF	PORCH	89 SF
UNHEATED	569 SF	UNHEATED	588 SF	UNHEATED	588 SF	UNHEATED	596 SF

SUITE C CARY, NC 27511

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NO:	DATE:	REVISION:

PROFESSIONAL SEAL

PROJECT TITLE:

JEREMIAH

CONSTRUCTION SET

CLIENTS NAME Client Name

PROJECT NO: Plan 4

SHEET TITLE:

COVER SHEET

PRINT DATE:

12.16.16

SHEET NO

T-1

GENERAL NOTES:

UNDERSTOOD THAT CONFORMANCE WITH ALL APPLICABLE CODES IS THE RESPONSIBILITY OF THE BUILDER AND CONTRACTOR.

SINGLE FAMILY RESIDENCE / 3 STORY TOWNHOMES

OCCUPANCY CLASSIFICATION

DUPLICATED, ALTERED, MODIFIED OR REVISED IN ANY WAY WITHOUT THE EXPRESSED WRITTEN APPROVAL OF THE DESIGNER. CONTRACTOR SHALL VERIFY ALL CONDITIONS AND DIMENSIONS AT THE SITE AND

TYPE VB (2 HOUR DWELLING SEPARATION BETWEEN UNITS.)

ALL INCONSISTENCES SHALL BE BROUGHT TO THE ATTENTION OF THE DEVELOPER AND THE DESIGNER BEFORE PROCEEDING WITH WORK.

ANY ERRORS OR OMISSIONS FOUND IN THESE DRAWINGS SHALL BE BROUGHT TO DEVELOPERS AND DESIGNERS ATTENTION IMMEDIATELY.

DO NOT SCALE DRAWINGS. WRITTEN DIMENSIONS TAKE PRECEDENCE OVER SCALED

ALL DIMENSIONS ARE TO FACE OF STUD OR TO FACE OF FRAMING UNLESS OTHERWISE NOTED. ALL TRUSS DRAWINGS TO BE REVIEWED AND APPROVED BY THE STRUCTURAL

ENGINEER PRIOR TO ISSUANCE OF BUILDING PERMIT ALL OR EQUAL SUBSTITUTIONS MUST BE SUBMITTED TO AND APPROVED BY CITY BUILDING OFFICIAL PRIOR TO INSTALLATION.

ALL ANGLED PARTITIONS ARE 45 DEGREES UNLESS OTHERWISE NOTED. PROVIDE FIREBLOCKING. (PER LOCAL CODES.)

ALL ELECTRICAL AND MECHANICAL FOLIPMENT AND METERS ARE SUBJECT TO RELOCATION DUE TO FIELD CONDITIONS, CONTRACTOR TO VERIFY

PROVIDE BLOCKING AND/OR BACKING AT ALL TOWEL BAR, TOWEL RING AND/OR TOILET PAPER HOLDER LOCATIONS, AS SHOWN PER PLAN, TYPICAL AT ALL BATHROOMS AND POWDER ROOMS. VERIFY LOCATIONS AT FRAMING WALK.

ELASTOMERIC SHEET WATERPROOFING: FURNISH AND INSTALL ALL WATERPROOFING EURAS JOWENIA SHEET HAVE HER MOOFHING, FORMEN AND HIS ALEAL ALL WATE COMPLETE. A 40 MIL, SELF-ADHERING MEMBRANE OF RUBBERIZED ASPHALT INTEGRALLY BONDED TO POLYETHYLENE SHEETING, OR EQUAL INSTALL PER MANUFACTURE'S AND TRADE ASSOCIATION'S PRINTED INSTALLATION INSTRUCTIONS. 6" MINIMUM LAP AT ALL ADJACENT WALL SURFACES

TO THE BEST OF THE DESIGNER'S KNOWLEDGE THESE DOCUMENTS ARE IN CONFORMANCE WITH THE REQUIREMENTS OF THE BUILDING AUTHORITIES HAVING JURISDICTION OVER THIS TYPE OF CONSTRUCTION AND OCCUPANCY. SHOP DRAWING REVIEW AND DISTRIBUSTION, ALONG WITH PRODUCT SUBMITTALS,

REQUESTED IN THE CONSTRUCTION DOCUMENTS. SHALL BE THE SOLE RESPONSIBILITY OF THE GENERAL CONTRACTOR, UNLESS DIRECTED OTHERWISE UNDER A SEPARATE AGREEMENT.

DEVIATIONS FROM THESE DOCUMENTS IN THE CONSTRUCTION PHASE SHALL BE REVIEWED BY THE DESIGNER AND THE OWNER PRIOR TO THE START OF WORK IN QUESTION. ANY DEVIATIONS FROM THESE DOCUMENTS WITHOUT PRIOR REVIEW, SHALL BE THE SOLE RESPONSIBILITY OF THE GENERAL CONTRACTOR.

THE GENERAL CONTRACTOR SHALL BE RESPONSIBLE FOR ALL WORK AND MATERIALS REPRESENTED ON THESE DOCUMENTS INCLUDING THE WORK AND MATERIALS FURNISHED BY SUBCONTRACTORS AND VENDORS.

GEOTECHNICAL ENGINEER (SOILS REPORT), ON THE STUDY OF THE PROPOSED SITE TO THE DESIGNER, STRUCTURAL ENGINEER, AND GENERAL CONTRACTOR, IN THE EVENT THE GEOTECHNICAL REPORTS DO NOT EXIST, THE SOILS CONDITION SHALL BE ASSUMED TO BE A MINIMUM DESIGN SOIL PRESSURE STATED BY THE STRUCTURAL ENGINEER OF RECORD FOR THE PURPOSE OF STRUCTURAL DESIGN. GENERAL CONTRACTOR SHALL ASSURE THE SOIL CONDITIONS MEET OR EXCEED THE CHIEF OF THE STRUCTURAL DESIGN. THE CRITERIA.

ALL WORK PERFORMED BY THE GENERAL CONTRACTOR SHALL COMPLY AND CONFORM WITH LOCAL AND STATE BUILDING CODES, ORDINANCES AND REGULATIONS, ALONG WITH ALL OTHER AUTHORITIES HAVING JURISDICTION. THE GENERAL CONTRCATOR IS RESPONSIBLE TO BE AWARE OF THESE REQUIREMENTS AND GOVERNING REGULATIONS.

PROVIDE AN APPROVED WASHER DRAIN PAN AT SECOND FLOOR ONLY

WINDOW SUPPLIER TO VERIFY AT LEAST ONE WINDOW IN ALL BEDROOMS TO HAVE A CLEAR OPENABLE AREA OF 4.0 SQ FT. THE MINIMUM NET CLEAR OPENING HEIGHT SHALL BE 22" AND THE MINIMUM NET CLEAR OPENING WIDTH SHALL BE 20". GLAZING TOTAL AREA OF NOT LESS THAN 5.0 SQ FT IN THE CASE OF A GROUND WINDOW AND NOT LESS THAN 5.7 SQ FT IN THE CASE OF AN UPPER STORY WINDOW, (PER NORC SECTION R310.1.1)
ALL HANDRAIL BALLUSTERS TO BE SPACED SUCH THAT A 4° SPHERE CANNOT PASS
BETWEEN BALLUSTERS. (PER LOCAL CODES.) PROVIDE STAIR HANDRAILS AND GUARDRAILS PER

BUILDER SET:

THE SCOPE OF THIS SET OF PLANS IS TO PROVIDE A "BUILDER'S SET" OF CONSTRUCTION DOCUMENTS AND GENERAL NOTES HEREINAFTER REFERRED TO AS "PLANS". THIS SET OF PLANS IS SUFFICIENT TO OBTAIN A BUILDING PERMIT: HOWEVER, ALL MATERIALS AND METHODS OF CONSTRUCTION NECESSARY TO COMPLETE THE PROJECT ARE NOT NECESSARILY DESCRIBED. THE PLANS DELINEATE AND DESCRIBE ONLY LOCATIONS. DIMENSIONS. TYPES OF MATERIALS. AND GENERAL METHODS OF ASSEMBLING OF RASTENING THEY ARE NOT INTENDED TO SPECIFY PARTICULAR PRODUCTS OR OTHER METHODS OF ANY SPECIFIC MATERIALS, PRODUCT OR METHOD. THE IMPLEMENTATION OF THE PLANS REQUIRES A CLIENT / CONTRACTOR THOROUGHLY KNOWLEDGEABLE WITH THE APPLICABLE BUILDING CODES AND METHODS OF CONSTRUCTION SPECIFIC TO THIS PRODUCT TYPE AND TYPE OF CONSTRUCTION

CONSTRUCTION REQUIREMENTS AND QUALITY: PROVIDE WORK OF THE SPECIFIC QUALITY: WHERE QUALITY LEVEL IS NOT INDICATED, PROVIDE WORK OF QUALITY CUSTOMARY IN SIMILAR TYPES OF WORK. WHERE THE PLANS AND SPECIFICATIONS, CODES, LAWS, REGULATIONS, MANUFACTURERS RECOMMENDATIONS ON INDUSTRY STANDARDS REQUIREMENTS AND QUALITY OR PERFORMANCE, PROVIDE WORK COMPLYING WITH THOSE REQUIREMENTS AND QUALITY. WHERE TWO OR MORE QUALITY PROVISIONS OF THOSE REQUIREMENTS CONFLICT WITH THE MOST STRINGENT REQUIREMENT; WHERE THE QUIREMENT SOFT CONFLICT WITH THE MOST STRINGENT REQUIREMENT, WHERE THE QUIREMENT OF THE CONFLICT WITH THE MOST STRINGENT REQUIREMENT; WHERE THE QUIREMENT OF THE CONFLICT WITH THE MOST STRINGENT REQUIREMENT; WHERE THE QUIREMENT OF THE MOST STRINGENT REQUIREMENT IS MOST STRINGENT, OBTAIN CLARIFICATION FROM THE ARCHITECT BEFORE PROCEEDING.

IRRIGATION SYSTEM SHALL BE DESIGNED TO PREVENT THE SATURATION OF SOIL ADJACENT TO BUILDING.

THIS PERIMETER DIMENSION PLAN IS FOR DIMENSIONAL INFORMATION ONLY.

SLOPE ALL STOOPS AND HARDSCAPE MATERIAL AWAY FROM BUILDING - TYPICAL.

SLOPE GARAGE FLOOR 1/8" PER FOOT TO GARAGE DOOR OPENING.

- VERIFY CURB CUT BLOCKOUT WITH GARAGE DOOR MANUFACTURER.

- REFER TO CIVIL DRAWINGS FOR FINISH SURFACE ELEVATIONS.

- FINISH GRADE SHALL PROVIDE POSITIVE DRAINAGE AWAY FROM BUILDING. REFER TO SOILS REPORT FOR ANY SPECIFIC REQUIREMENTS.

- REFER TO STRUCTURAL DRAWINGS FOR HOLDDOWNS, FOOTING DETAILS, CURB THICKNESS, AND INFORMATION NOT SHOWN ON THIS PLAN.

- PLUMBING FIXTURES, VENT LOCATIONS, ETC. ARE APPROXIMATE. CONTRACTOR TO VERIFY COUNT AND LOCATION.

- VERIFY THE SUPPLY FOR SEPARATE CONDUITS TO ANY ISLAND FOR GAS, WATER OR ELECTRIC.

VERIFY ALL DOOR THRESHOLD HEIGHTS TO HARD SURFACES. 8 1/4" MAX AT INSWING DOORS. (PER NCRC SECTION R311.3.1.)

TYP STOOP AT INSWING/SLIDER DOORS: 36" DEEP BY THE WIDTH OF THE DOOR SERVED, MINIMUM. (PER NCRC SECTION R311.3.) PROVIDE A SLIP-RESISTANT FINISH.

FOR THE USE OF EXPOSED GAS WATER HEATERS IN THE GARAGE, PROTECT THE WATER HEATER WITH 3" DIA CONCRETE FILLED STEEL PIPE EMBEDDED INTO CONCRETE FOOTING.


SOILS TREATMENT:
BORACARE TERMITE TO BE APPLIED TO FRAMING PER PRODUCT SPECIFICATIONS.
(PROVIDE CHEMICAL TREATMENT FOR PROTECTION FROM TERMITE INFESTATION
ACCORDING TO THE STANDARDS OF THE NC DEPT OF AGRICULTURE.)

WOOD CONTACTING CONCRETE OR MASONRY OR LESS THAN CODE REQUIRED SEPARATION TO GRADE SHALL BE PRESSURE TREATED OR FOUNDATION GRADE REDWOOD. SET ALL EXTERIOR WALL SILLS IN MASTIC.

REFER TO STRUCTURAL **DRAWINGS FOR ALL** FOUNDATION DIMENSIONS

FOLINDATION KEYNOTE LEGEND

TOONDATION RETNOTE LEGEND	
F1	LINE OF SLAB ABOVE
F0	LINE OF FRAMER WALL ABOVE

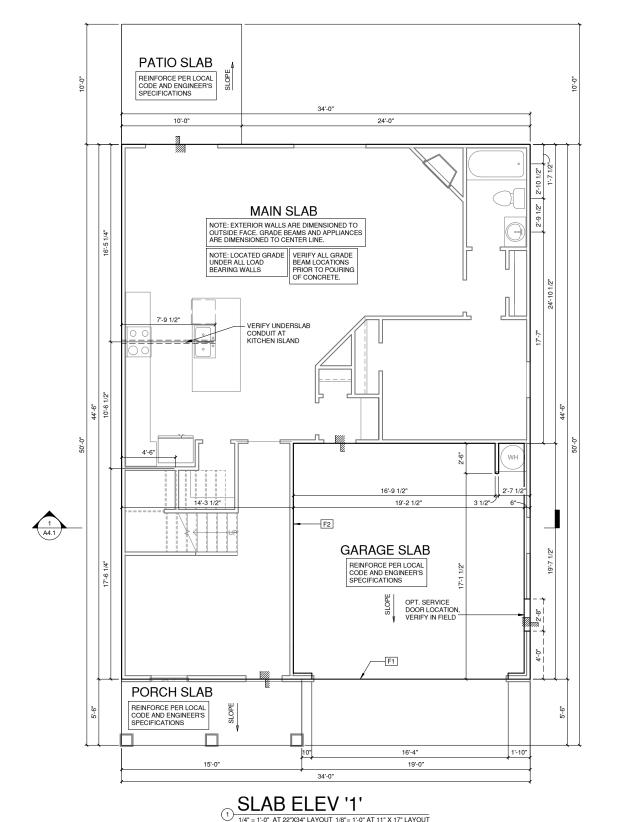



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);	DATE:	REVISION:

PROFESSIONAL SEAL:

PROJECT TITLE:

JEREMIAH

CONSTRUCTION SET

CLIENTS NAME: Client Name

PROJECT NO:

SHEET TITLE: **SLAB ELEV '1'**

PRINT DATE:

12.16.16

SHEET NO A0.1.1

IRRIGATION SYSTEM SHALL BE DESIGNED TO PREVENT THE SATURATION OF SOIL ADJACENT TO BUILDING.

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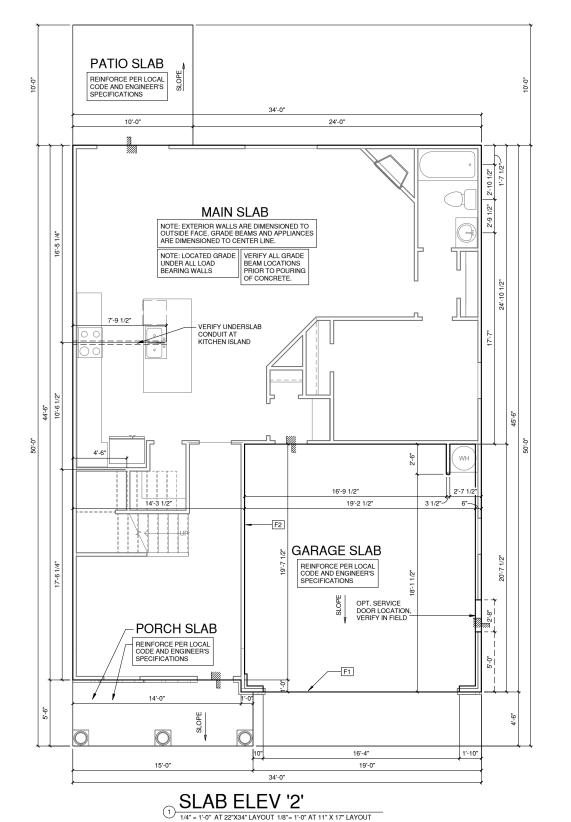
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REFER TO STRUCTURAL **DRAWINGS FOR ALL** FOUNDATION DIMENSIONS

FOUNDATION KEYNOTE LEGEND

LINE OF SLAB ABOVE LINE OF FRAMED WALL ABOVE





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JEREMIAH

CONSTRUCTION SET

CLIENTS NAME: Client Name

PROJECT NO: SHEET TITLE:

SLAB ELEV '2'

PRINT DATE:

12.16.16

SHEET NO A0.1.2

IRRIGATION SYSTEM SHALL BE DESIGNED TO PREVENT THE SATURATION OF SOIL ADJACENT TO BUILDING.

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SLOPE ALL STOOPS AND HARDSCAPE MATERIAL AWAY FROM BUILDING - TYPICAL

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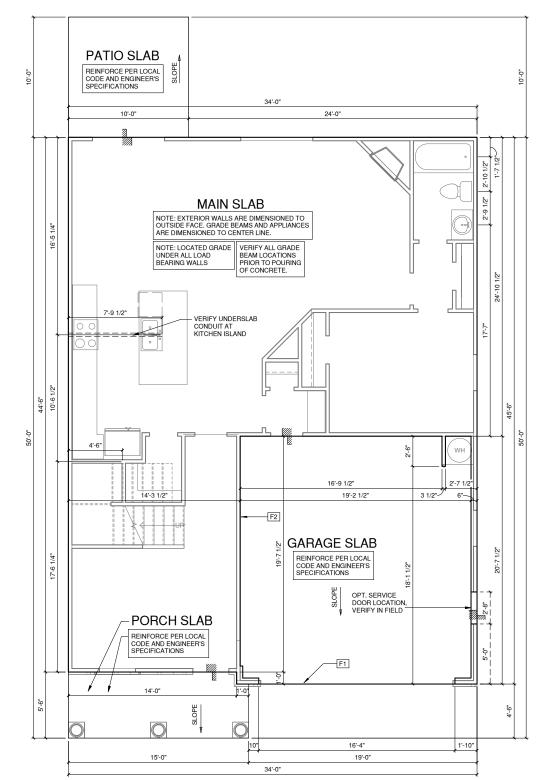
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REFER TO STRUCTURAL DRAWINGS FOR ALL FOUNDATION DIMENSIONS

FOUNDATION KEYNOTE LEGEND

LINE OF FRAMED WALL ABOV



① SLAB ELEV '3'

1/4" = 1'-0" AT 22"X34" LAYOUT 1/8" = 1'-0" AT 11" X 17" LAYOUT



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CONSTRUCTION SET

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SHEET TITLE:

SLAB ELEV '3'

12.16.16

SHEET NO A0.1.3

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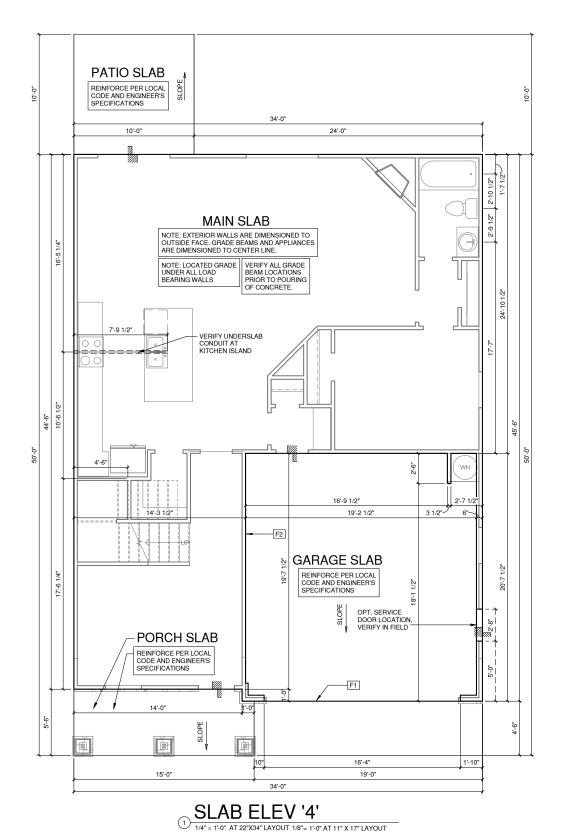
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REFER TO STRUCTURAL **DRAWINGS FOR ALL** FOUNDATION DIMENSIONS

FOUNDATION KEYNOTE LEGEND

LINE OF SLAB ABOVE
LINE OF FRAMED WALL ABOVE



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PROFESSIONAL SEAL:

PROJECT TITLE:

JEREMIAH

CONSTRUCTION SET

CLIENTS NAME: Client Name

PROJECT NO:

SHEET TITLE:

SLAB ELEV '4'

12.16.16

SHEET NO

A0.1.4

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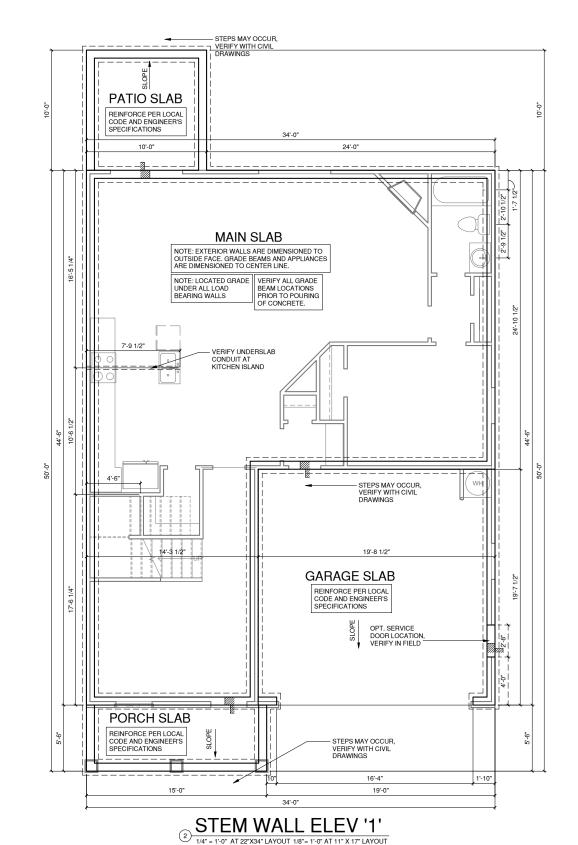
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REFER TO STRUCTURAL DRAWINGS FOR ALL FOUNDATION DIMENSIONS

FOUNDATION KEYNOTE LEGEND LINE OF SLAB ABOVE

LINE OF FRAMED WALL ABOVE



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JEREMIAH

CONSTRUCTION SET

CLIENTS NAME: Client Name

PROJECT NO:

SHEET TITLE:

STEM WALL ELEV '1'

PRINT DATE:

12.16.16

SHEET NO

A0.2.1

IRRIGATION SYSTEM SHALL BE DESIGNED TO PREVENT THE SATURATION OF SOIL ADJACENT TO BUILDING.

THIS PERIMETER DIMENSION PLAN IS FOR DIMENSIONAL INFORMATION ONLY.

- SLOPE ALL STOOPS AND HARDSCAPE MATERIAL AWAY FROM BUILDING - TYPICAL.

- SLOPE GARAGE FLOOR 1/8" PER FOOT TO GARAGE DOOR OPENING

- VERIFY CURB CUT BLOCKOUT WITH GARAGE DOOR MANUFACTURER

- FINISH GRADE SHALL PROVIDE POSITIVE DRAINAGE AWAY FROM BUILDING. REFER TO SOILS REPORT FOR ANY SPECIFIC REQUIREMENTS.

- REFER TO STRUCTURAL DRAWINGS FOR HOLDDOWNS, FOOTING DETAILS, CURB THICKNESS, AND INFORMATION NOT SHOWN ON THIS PLAN.

PLUMBING FIXTURES, VENT LOCATIONS, ETC. ARE APPROXIMATE. CONTRACTOR TO VERIFY COUNT AND LOCATION.

VERIFY THE SUPPLY FOR SEPARATE CONDUITS TO ANY ISLAND FOR GAS, WATER OR ELECTRIC.

VERIFY ALL DOOR THRESHOLD HEIGHTS TO HARD SURFACES. 8 1/4" MAX AT INSWING DOORS. (PER NCRC SECTION R311.3.1.)

- TYP STOOP AT INSWING/SLIDER DOORS; 36" DEEP BY THE WIDTH OF THE DOOR SERVED, MINIMUM. (PER NCRC SECTION R311.3.) PROVIDE A SLIP-RESISTANT FINISH.

- FOR THE USE OF EXPOSED GAS WATER HEATERS IN THE GARAGE, PROTECT THE WATER HEATER WITH 3" DIA CONCRETE FILLED STEEL PIPE EMBEDDED INTO CONCRETE FOOTING.


- SOILS TREATMENT:
BORACARE TERMITE TO BE APPLIED TO FRAMING PER PRODUCT SPECIFICATIONS.
(PROVIDE O'HEMICAL TREATMENT FOR PROTECTION FROM TERMITE INFESTATION
ACCORDING TO THE STANDARDS OF THE NC DEPT OF AGRICULTURE.)

-WOOD CONTACTING CONCRETE OR MASONRY OR LESS THAN CODE REQUIRED SEPARATION TO RADE SHALL BE PRESSURE TREATED OR FOUNDATION GRADE REDWOOD. SET ALL EXTERIOR WALL SILLS IN MASTIC.

REFER TO STRUCTURAL **DRAWINGS FOR ALL** FOUNDATION DIMENSIONS

FOUNDATION KEYNOTE LEGEND

LINE OF SLAB ABOVE LINE OF FRAMED WALL ABOVE

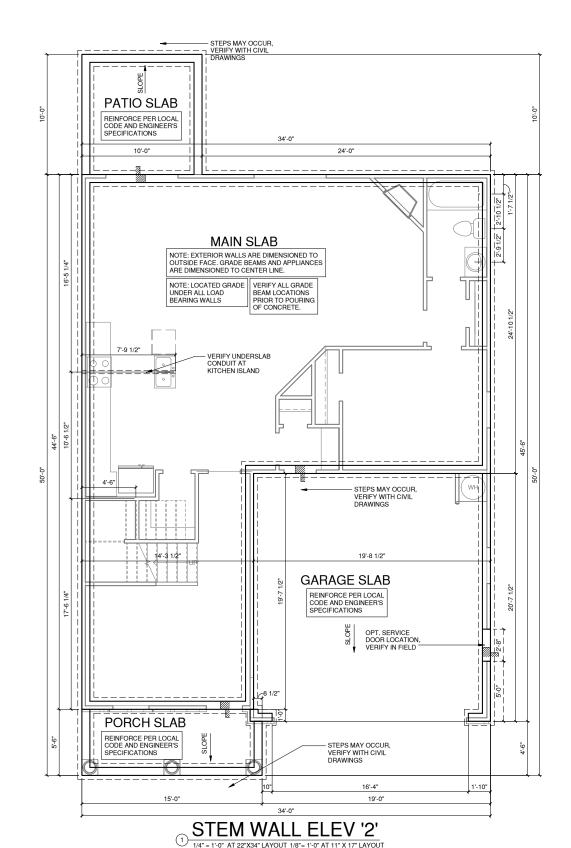



SUITE C CARY, NC 27511 PHONE: (919) 320-3022

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NO:	DATE:	REVISION:

PROFESSIONAL SEAL:

PROJECT TITLE:

JEREMIAH

CONSTRUCTION SET

CLIENTS NAME: Client Name

PROJECT NO:

SHEET TITLE:

STEM WALL ELEV '2'

PRINT DATE:

12.16.16

SHEET NO A0.2.2

IRRIGATION SYSTEM SHALL BE DESIGNED TO PREVENT THE SATURATION OF SOIL ADJACENT TO BUILDING.

THIS PERIMETER DIMENSION PLAN IS FOR DIMENSIONAL INFORMATION ONLY

SLOPE ALL STOOPS AND HARDSCAPE MATERIAL AWAY FROM BUILDING - TYPICAL.

SLOPE GARAGE FLOOR 1/8" PER FOOT TO GARAGE DOOR OPENING.

VERIFY CURB CUT BLOCKOUT WITH GARAGE DOOR MANUFACTURER.

BEFER TO CIVIL DRAWINGS FOR FINISH SURFACE FLEVATIONS

FINISH GRADE SHALL PROVIDE POSITIVE DRAINAGE AWAY FROM BUILDING. REFER TO SOILS

REFER TO STRUCTURAL DRAWINGS FOR HOLDDOWNS, FOOTING DETAILS, CURB THICKNESS, AND INFORMATION NOT SHOWN ON THIS PLAN.

PLUMBING FIXTURES, VENT LOCATIONS, ETC. ARE APPROXIMATE. CONTRACTOR TO VERIFY COUNT AND LOCATION.

VERIFY THE SUPPLY FOR SEPARATE CONDUITS TO ANY ISLAND FOR GAS, WATER OR FLECTRIC.

VERIFY ALL DOOR THRESHOLD HEIGHTS TO HARD SURFACES 8 1/4" MAX AT INSWING DOORS. (PER NCRC SECTION R311.3.1.

TYP STOOP AT INSWING/SLIDER DOORS: 36" DEEP BY THE WIDTH OF THE DOOR SERVED, MINIMUM. (PER NCRC SECTION R311.3.) PROVIDE A SLIP-RESISTANT FINISH.

FOR THE USE OF EXPOSED GAS WATER HEATERS IN THE GARAGE, PROTECT THE WATER HEATER WITH

3" DIA CONCRETE FILLED STEEL PIPE EMBEDDED INTO CONCRETE FOOTING.

SOILS THEATMENT:

BORACARE TERMITE TO BE APPLIED TO FRAMING PER PRODUCT SPECIFICATIONS,

(PROVIDE CHEMICAL TREATMENT FOR PROTECTION FROM TERMITE INFESTATION


ACCORDING TO THE STANDARDS OF THE NC DEPT OF AGRICULTURE.)

WOOD CONTACTING CONCRETE OR MASONRY OR LESS THAN CODE REQUIRED SEPARATION TO GRADE SHALL BE PRESSURE TREATED OR FOUNDATION GRADE REDWOOD. SET ALL EXTERIOR WALL SILLS IN MASTIC.

REFER TO STRUCTURAL DRAWINGS FOR ALL FOUNDATION DIMENSIONS

FOUNDATION KEYNOTE LEGEND LINE OF SLAB ABOVE

LINE OF FRAMED WALL ABOVE

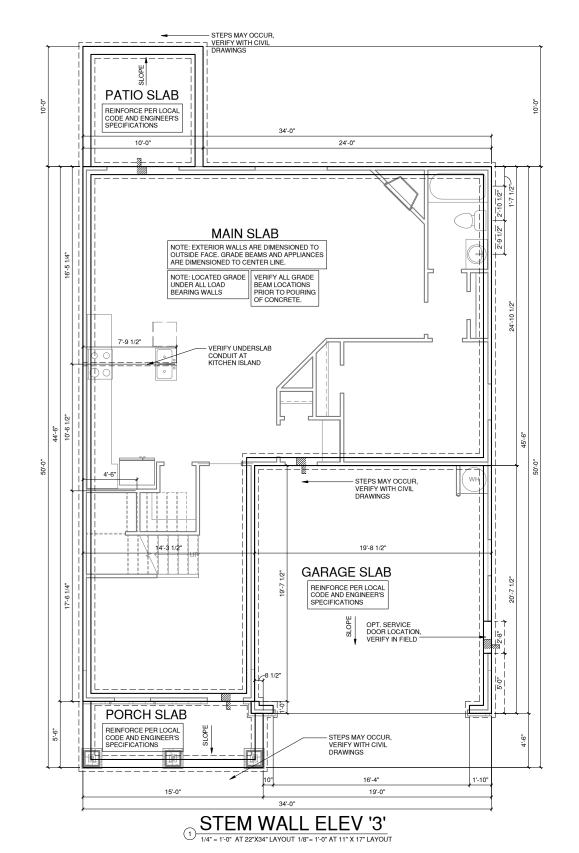



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PROFESSIONAL SEAL:

PROJECT TITLE:

JEREMIAH

CONSTRUCTION SET

CLIENTS NAME: Client Name

PROJECT NO:

SHEET TITLE:

STEM WALL ELEV '3'

PRINT DATE:

12.16.16

SHEET NO A0.2.3

IRRIGATION SYSTEM SHALL BE DESIGNED TO PREVENT THE SATURATION OF SOIL ADJACENT TO BUILDING.

THIS PERIMETER DIMENSION PLAN IS FOR DIMENSIONAL INFORMATION ONLY.

SLOPE ALL STOOPS AND HARDSCAPE MATERIAL AWAY FROM BUILDING - TYPICAL.

- SLOPE GARAGE FLOOR 1/8" PER FOOT TO GARAGE DOOR OPENING.

- VERIFY CURB CUT BLOCKOUT WITH GARAGE DOOR MANUFACTURER

REFER TO CIVIL DRAWINGS FOR FINISH SURFACE ELEVATIONS.

FINISH GRADE SHALL PROVIDE POSITIVE DRAINAGE AWAY FROM BUILDING. REFER TO SOILS REPORT FOR ANY SPECIFIC REQUIREMENTS.

REFER TO STRUCTURAL DRAWINGS FOR HOLDDOWNS, FOOTING DETAILS, CURB THICKNESS, AND INFORMATION NOT SHOWN ON THIS PLAN.

PLUMBING FIXTURES, VENT LOCATIONS, ETC. ARE APPROXIMATE. CONTRACTOR TO VERIFY COUNT AND LOCATION.

VERIFY THE SUPPLY FOR SEPARATE CONDUITS TO ANY ISLAND FOR GAS, WATER OR ELECTRIC.

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- TYP STOOP AT INSWING/SLIDER DOORS: 36" DEEP BY THE WIDTH OF THE DOOR SERVED, MINIMUM. (PER NCRC SECTION R311.3.) PROVIDE A SLIP-RESISTANT FINISH.

FOR THE USE OF EXPOSED GAS WATER HEATERS IN THE GARAGE, PROTECT THE WATER HEATER WITH 3" DIA CONCRETE FILLED STEEL PIPE EMBEDDED INTO CONCRETE FOOTING.


SOILS TREATMENT:
BORACARE TERMITE TO BE APPLIED TO FRAMING PER PRODUCT SPECIFICATIONS.
(PROVIDE CHEMICAL TREATMENT FOR PROTECTION FROM TERMITE INFESTATION
ACCORDING TO THE STANDARDS OF THE NC DEPT OF AGRICULTURE.)

WOOD CONTACTING CONCRETE OR MASONRY OR LESS THAN CODE REQUIRED SEPARATION TO GRADE SHALL BE PRESSURE TREATED OR FOUNDATION GRADE REDWOOD. SET ALL EXTERIOR WALL SILLS IN MASTIC.

REFER TO STRUCTURAL DRAWINGS FOR ALL FOUNDATION DIMENSIONS

FOUNDATION KEYNOTE LEGEND LINE OF SLAB ABOVE

LINE OF FRAMED WALL ABOVE

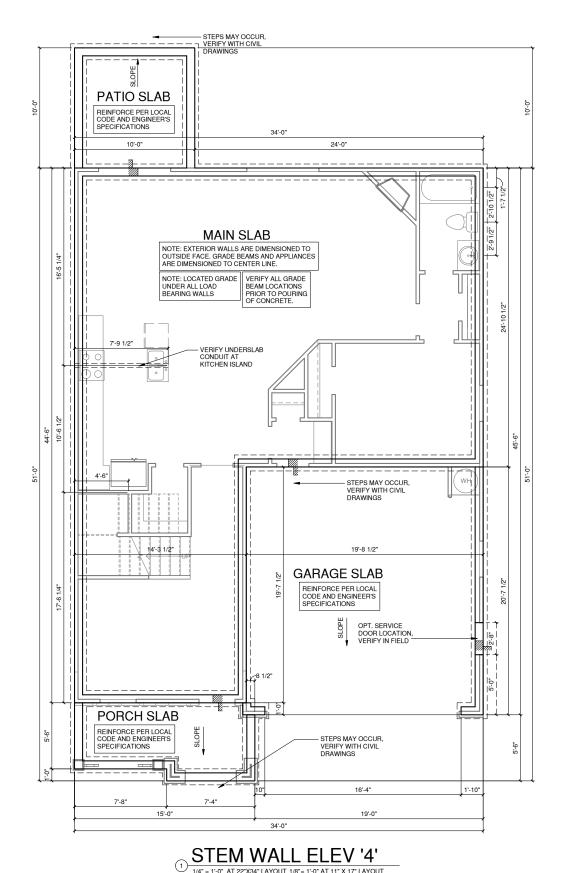



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JEREMIAH

CONSTRUCTION SET

CLIENTS NAME: Client Name

PROJECT NO:

SHEET TITLE:

STEM WALL ELEV '4'

PRINT DATE:

12.16.16

A0.2.4

REFER TO STRUCTURAL DRAWINGS FOR INFORMATION NOT SHOWN ON THIS PLAN

FOR ADDITIONAL NOTES SEE GENERAL NOTES ON TITLE SHEET AND DETAILS.

PROVIDE FIREBLOCKING. (PER NCRC SECTION R602.8)

-ALL ELECTRICAL AND MECHANICAL EQUIPMENT AND METERS ARE SUBJECT TO RELOCATION DUE TO FIELD CONDITIONS, CONTRACTOR TO VERIFY.

-VERIFY ALL DOOR THRESHOLD HEIGHTS TO HARD S URFACES. 8 1/4" MAX AT INSWING DOORS. (PER NCRC SECTION R311.3.1)

-SLOPE ALL STOOPS AND HARDSCAPE MATERIAL AWAY FROM BUILDING - TYPICAL.

SLOPE GARAGE FLOOR 1/8" PER FOOT TO GARAGE DOOR OPENING.

-VERIFY CURB CUT BLOCKOUT WITH GARAGE DOOR MANUFACTURER.

-REFER TO CIVIL DRAWINGS FOR FINISH SURFACE ELEVATIONS

-TYP. STOOP AT INSWING/SLIDER DOORS: 36" DEEP BY THE WIDTH OF THE DOOR SERVED,

-SOILS TREATMENT:
BORACARE TERMITE TO BE APPLIED TO FRAMING PER PRODUCT SPECIFICATIONS. (PROVIDE CHEMICAL TREATMENT FOR PROTECTION FROM TERMITE INVESTATION ACCORDING TO THE STANDARDS OF THE NC DEPT. OF AGRICULTURE.)

AT VENTED CRAWL SPACE:
APPLY AN APPROVED VAPOR RETARDER OR EQUIVALENT, 6 MIL POLY-VINYL, GROUND COVER OVER FINISH GRADE OR CRAWL SPACE
PER NCRC SECTION 408.2

-PROVIDE VENTS SPACED AROUND PERIMETER TO PROMOTE CROSS VENTILATION AT A RATE OF 1 SF VENT FOR EVERY 1500 SF OF CRAWL FLOOR AREA. ONE VENT MUST BE LOCATED WITHIN 3'-0" OF EACH CORNER OF THE BUILDING AND LOCATED TO ALLOW FOR CROSS VENTILATION. (PER NCRC SECTION R408.1.1 EXCEPTION.)


PROVIDE AN ACCESS OPENING, MINIMUM SIZE OF 18"X24" FOR CRAWL ACCESS, COORDINATE WITH MECHANICAL CONTRACTOR FOR LARGER SIZE REQUIREMENTS IF MECHANICAL EQUIPMENT IS LOCATED IN CRAWL. (PER NCRC SECTION 408.8)

-WOOD CONTACTING CONCRETE OR MASONRY OR LESS THAN CODE REQUIRED SEPARATION TO GRADE SHALL BE PRESSURE TREATED OR FOUNDATION GRADE REDWOOD. SET ALL EXTERIOR WALL SILLS IN MASTIC.

REFER TO STRUCTURAL DRAWINGS FOR ALL FOUNDATION DIMENSIONS

FOUNDATION KEYNOTE LEGEND LINE OF SLAB ABOVE

LINE OF FRAMED WALL ABOVE

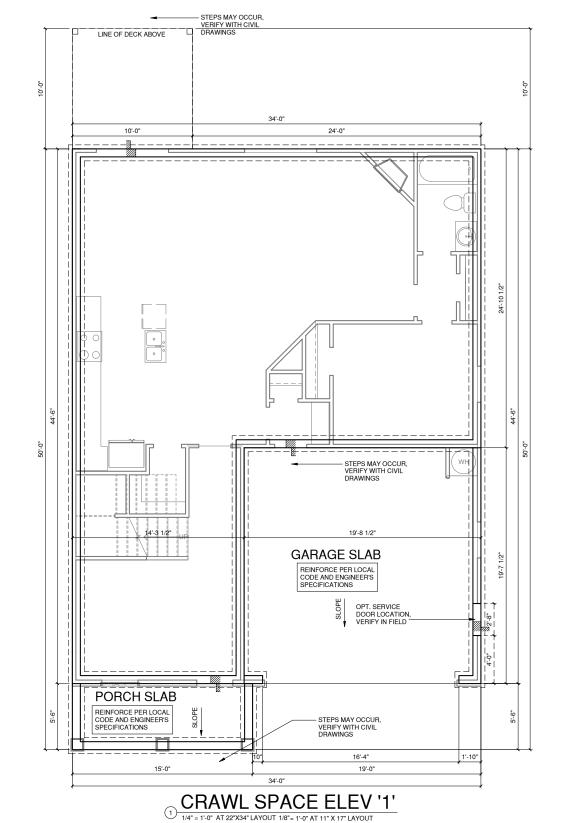



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PROJECT TITLE:

JEREMIAH

PROFESSIONAL SEAL:

CONSTRUCTION SET

CLIENTS NAME: Client Name

PROJECT NO:

SHEET TITLE:

CRAWL SPACE ELEV '1'

PRINT DATE:

12.16.16

SHEET NO

REFER TO STRUCTURAL DRAWINGS FOR INFORMATION NOT SHOWN ON THIS PLAN.

FOR ADDITIONAL NOTES SEE GENERAL NOTES ON TITLE SHEET AND DETAILS.

PROVIDE FIREBLOCKING. (PER NCRC SECTION R602.8)

-ALL ELECTRICAL AND MECHANICAL EQUIPMENT AND METERS ARE SUBJECT TO RELOCATION DUE TO FIELD CONDITIONS, CONTRACTOR TO VERIFY.

VERIEV ALL DOOR THRESHOLD HEIGHTS TO HARD SURFACES 8 1/4" MAX AT INSWING DOORS. (PER NCRC SECTION R311.3.1)

SLOPE ALL STOOPS AND HARDSCAPE MATERIAL AWAY FROM BUILDING - TYPICAL.

SLOPE GARAGE FLOOR 1/8" PER FOOT TO GARAGE DOOR OPENING.

VERIFY CURB CUT BLOCKOUT WITH GARAGE DOOR MANUFACTURER.

REFER TO CIVIL DRAWINGS FOR FINISH SURFACE ELEVATIONS.

TYP STOOP AT INSWING/SLIDER DOORS: 36" DEEP BY THE WIDTH OF THE DOOR SERVED

NIMUM (PER NCRC SECTIONS R311.3) PROVIDE A SLIP-RESISTANT FINISH

-SOLIS I HEALMENT:
BORACARE TERMITE TO BE APPLIED TO FRAMING PER PRODUCT SPECIFICATIONS. (PROVIDE CHEMICAL TREATMENT FOR PROTECTION FROM TERMITE INVESTATION ACCORDING TO THE STANDARDS OF THE NC DEPT. OF AGRICULTURE.)

PARTY AN APPROVED VAPOR RETARDER OR EQUIVALENT, 6 MIL POLY-VINYL, GROUND COVER OVER FINISH GRADE OR CRAWL SPACE PER NCRC SECTION 408.2

-PROVIDE VENTS SPACED AROUND PERIMETER TO PROMOTE CROSS VENTILATION AT A RATE OF 1 SF VENT FOR EVERY 1500 SF OF CRAWL FLOOR AREA. ONE VENT MUST BE LOCATED WITHIN 3'-0" OF EACH CORNER OF THE BUILDING AND LOCATED TO ALLOW FOR CROSS VENTILATION. (PER NCRC SECTION R408.1.1 EXCEPTION.)


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-WOOD CONTACTING CONCRETE OR MASONRY OR LESS THAN CODE REQUIRED SEPARATION TO GRADE SHALL BE PRESSURE TREATED OR FOUNDATION GRADE REDWOOD. SET ALL EXTERIOR WALL SILLS IN MASTIC.

REFER TO STRUCTURAL DRAWINGS FOR ALL FOUNDATION DIMENSIONS

FOUNDATION KEYNOTE LEGEND

. • •	
F1	LINE OF SLAB ABOVE
F2	LINE OF FRAMED WALL ABOVE

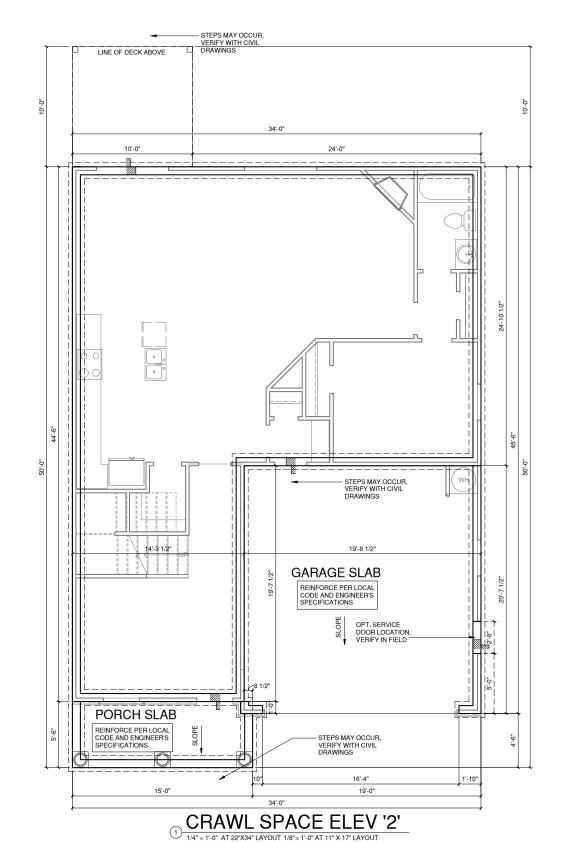

CLIENTS NAME:

Client Name

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NO: DATE: REVISION:

PROFESSIONAL SEAL:

PROJECT TITLE:

JEREMIAH

CONSTRUCTION SET

PROJECT NO:

ELEV '2'

SHEET TITLE: **CRAWL SPACE**

12.16.16

SHEET NO

PRINT DATE:

REFER TO STRUCTURAL DRAWINGS FOR INFORMATION NOT SHOWN ON THIS PLAN.

FOR ADDITIONAL NOTES SEE GENERAL NOTES ON TITLE SHEET AND DETAILS.

PROVIDE FIREBLOCKING. (PER NCRC SECTION R602.8)

ALL ELECTRICAL AND MECHANICAL EQUIPMENT AND METERS ARE SUBJECT TO RELOCATION DUE TO FIELD CONDITIONS, CONTRACTOR TO VERIFY.

-VERIFY ALL DOOR THRESHOLD HEIGHTS TO HARD S URFACES.

8 1/4" MAX AT INSWING DOORS. (PER NCRC SECTION R311.3.1)

SLOPE ALL STOOPS AND HARDSCAPE MATERIAL AWAY FROM BUILDING - TYPICAL.

-SLOPE GARAGE FLOOR 1/8" PER FOOT TO GARAGE DOOR OPENING.

-VERIFY CURB CUT BLOCKOUT WITH GARAGE DOOR MANUFACTURER.

-REFER TO CIVIL DRAWINGS FOR FINISH SURFACE ELEVATIONS.

TYP. STOOP AT INSWING/SLIDER DOORS: 36" DEEP BY THE WIDTH OF THE DOOR SERVED,

MINIMUM (PER NORC SECTIONS R311.3) PROVIDE A SLIP-RESISTANT FINISH

-SOILS TREATMENT:
BORACARE TERMITE TO BE APPLIED TO FRAMING PER PRODUCT SPECIFICATIONS, (PROVIDE CHEMICAL TREATMENT FOR PROTECTION FROM TERMITE INVESTATION ACCORDING TO THE STANDARDS OF THE NC DEPT. OF AGRICULTURE.)

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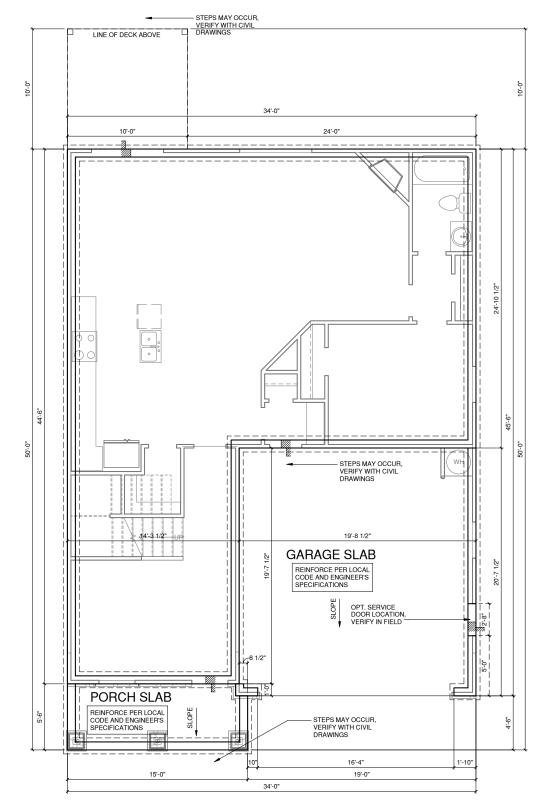
WOOD CONTACTING CONCRETE OR MASONRY OR LESS THAN CODE REQUIRED SEPARATION TO GRADE SHALL BE PRESSURE TREATED OR FOUNDATION GRADE REDWOOD. SET ALL EXTERIOR WALL SILLS IN MASTIC.

REFER TO STRUCTURAL **DRAWINGS FOR ALL** FOUNDATION DIMENSIONS

FOUNDATION KEYNOTE LEGEND

F1	LINE OF SLAB ABOVE

LINE OF FRAMED WALL ABOVE



CRAWL SPACE ELEV '3' 1/4" = 1'-0" AT 22"X34" LAYOUT 1/8"= 1'-0" AT 11" X 17" LAYOUT



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CRAWL SPACE ELEV '3'

PRINT DATE:

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-REFER TO STRUCTURAL DRAWINGS FOR INFORMATION NOT SHOWN ON THIS PLAN.

-FOR ADDITIONAL NOTES SEE GENERAL NOTES ON TITLE SHEET AND DETAILS.

-ALL ELECTRICAL AND MECHANICAL EQUIPMENT AND METERS ARE SUBJECT TO RELOCATION DUE TO FIELD CONDITIONS, CONTRACTOR

-VERIFY ALL DOOR THRESHOLD HEIGHTS TO HARD S URFACES.

8 1/4" MAX AT INSWING DOORS. (PER NCRC SECTION R311.3.1)

SLOPE ALL STOOPS AND HARDSCAPE MATERIAL AWAY FROM BUILDING - TYPICAL.

SLOPE GARAGE FLOOR 1/8" PER FOOT TO GARAGE DOOR OPENING.

-VERIFY CURB CUT BLOCKOUT WITH GARAGE DOOR MANUFACTURER.

-REFER TO CIVIL DRAWINGS FOR FINISH SURFACE ELEVATIONS.

-TYP. STOOP AT INSWING/SLIDER DOORS: 36" DEEP BY THE WIDTH OF THE DOOR SERVED, MINIMUM (PER NCRC SECTIONS R311.3) PROVIDE A SLIP-RESISTANT FINISH.

-AT VENTED CRAWL SPACE:

APPLY AN APPROVED VAPOR RETARDER OR EQUIVALENT, 6 MIL POLY-VINYL, GROUND COVER OVER FINISH GRADE OR CRAWL SPACE PER NCRC SECTION 408.2

-PROVIDE VENTS SPACED AROUND PERIMETER TO PROMOTE CROSS VENTILATION AT A RATE OF 1 SF VENT FOR EVERY 1500 SF OF CRAWL FLOOR AREA. ONE VENT MUST BE LOCATED WITHIN 3'-0" OF EACH CORNER OF THE BUILDING AND LOCATED TO ALLOW FOR CROSS VENTILATION. (PER NCRC SECTION R408.1.1 EXCEPTION.)


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-WOOD CONTACTING CONCRETE OR MASONRY OR LESS THAN CODE REQUIRED SEPARATION TO GRADE SHALL BE PRESSURE TREATED OR FOUNDATION GRADE REDWOOD. SET ALL EXTERIOR WALL SILLS IN MASTIC.

REFER TO STRUCTURAL **DRAWINGS FOR ALL** FOUNDATION DIMENSIONS

FOUNDATION KEYNOTE LEGEND

		MB/MONTELLING IL LEGEN
F1 LIN		LINE OF SLAB ABOVE
	F2	LINE OF FRAMED WALL ABOVE



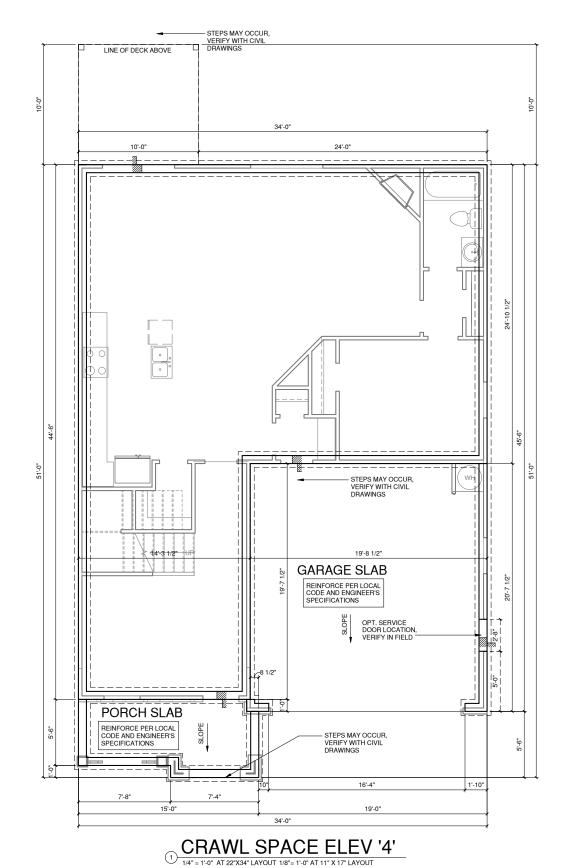

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JEREMIAH

CONSTRUCTION SET

CLIENTS NAME: Client Name

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SHEET TITLE:

CRAWL SPACE ELEV '4'

PRINT DATE: 12.16.16

FULL HEIGHT FULL HEIGHT 2X4 WOOD STUD PARTITION 2X6 WOOD STUD PARTITION

DRYWALL OPENING HEIGHT AS NOTED ON PLAN

STONE VENEER BRICK VENEER

STUD WALL BELOW HEIGHT AND STUD SIZE AS NOTED

FLOOR PLAN KEYNOTE LEGEND

HOUSE TO GARAGE FIRE SEPARATION, GARAGE/HOUSE SEPARATION AT VERTICAL SURFACES SHALL BE PROTECTED WITH ONE (1) LAYER 1/2" GYPSUM BOARD. GARAGE/HOUSE SEPARATION AT HORIZONTAL SURFACES SHALL BE PROTECTED WITH ONE (1) LAYER 5/8" TYPE "X" GYPSUM BOARD

BENEATH STAIRS AND LANDINGS. 1/2" GYPSUM BOARD ON WALLS AND CEILING OF ENCLOSED ACCESSIBLE AREAS


GAS WATER HEATER ON 18" HIGH PLATFORM
PRE-FABRICATED METAL FIREPLACE, INSTALL PER MANUFACTURER WRITTEN INSTRUCTIONS

TEMPERED SAFETY GLASS HALF WALL, HEIGHT AS NOTED


2 INTERIOR SOFFITS: FFL = 8'-1" U.N.O. SFL = 7'-6" U.N.O., OPT. CASED OPENING U.N.O.

SHOWER, TEMPERED GLASS ENCLOSURE

14 TUB-SHOWER COMBO

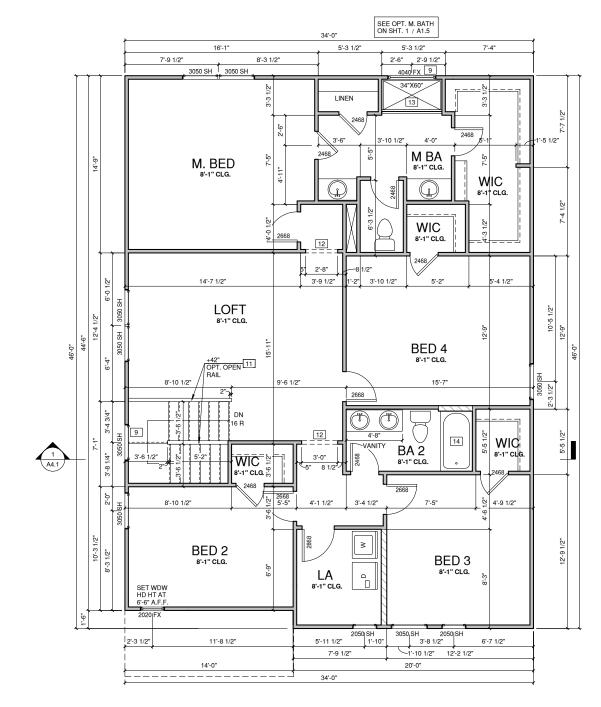



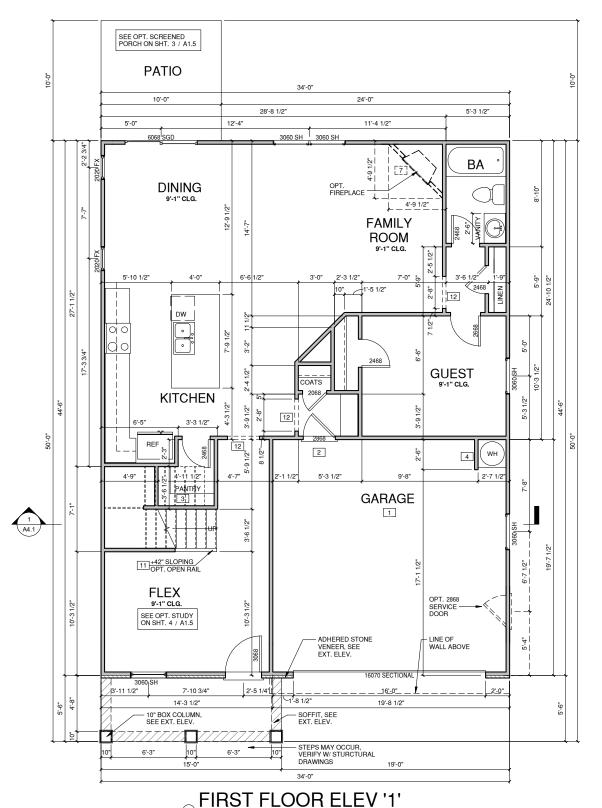

1/4" = 1'-0" AT 22"X34" LAYOUT 1/8"= 1'-0" AT 11" X 17" LAYOUT



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PROJECT TITLE:

JEREMIAH

CONSTRUCTION SET

CLIENTS NAME: Client Name

PROJECT NO:

SHEET TITLE:

FLOOR PLANS ELEV '1'

PRINT DATE: 12.16.16

SHEET NO

FULL HEIGHT FULL HEIGHT 2X4 WOOD STUD PARTITION 2X6 WOOD STUD PARTITION

DRYWALL OPENING HEIGHT AS NOTED ON PLAN STONE VENEER

BRICK VENEER

STUD WALL BELOW HEIGHT AND STUD SIZE AS NOTED

FLOOR PLAN KEYNOTE LEGEND

HOUSE TO GARAGE FIRE SEPARATION, GARAGE/HOUSE SEPARATION AT VERTICAL SURFACES SHALL BE PROTECTED WITH ONE (1) LAYER 1/2" GYPSUM BOARD. GARAGE/HOUSE SEPARATION AT HORIZONTAL SURFACES SHALL BE PROTECTED WITH ONE (1) LAYER 5/8" TYPE "X" GYPSUM BOARD HOUSE TO GARAGE DOOR SEPARATION. PROVIDE 1 3/8" SOLID CORE DOOR OR APPROVED 20 MINUTE RATED DOOR

BENEATH STAIRS AND LANDINGS. 1/2" GYPSUM BOARD ON WALLS AND CEILING OF ENCLOSED ACCESSIBLE AREAS


ACCESSIBLE AREAS

GAS WATER HEATER ON 18" HIGH PLATFORM


PRE-FABRICATED METAL FIREPLACE, INSTALL PER MANUFACTURER WRITTEN INSTRUCTIONS TEMPERED SAFETY GLASS

HALF WALL, HEIGHT AS NOTED INTERIOR SOFFITS: FFL = 8-1" U.N.O. SFL = 7-6" U.N.O., OPT. CASED OPENING U.N.O. SHOWER, TEMPERED GLASS ENCLOSURE

14 TUB-SHOWER COMBO

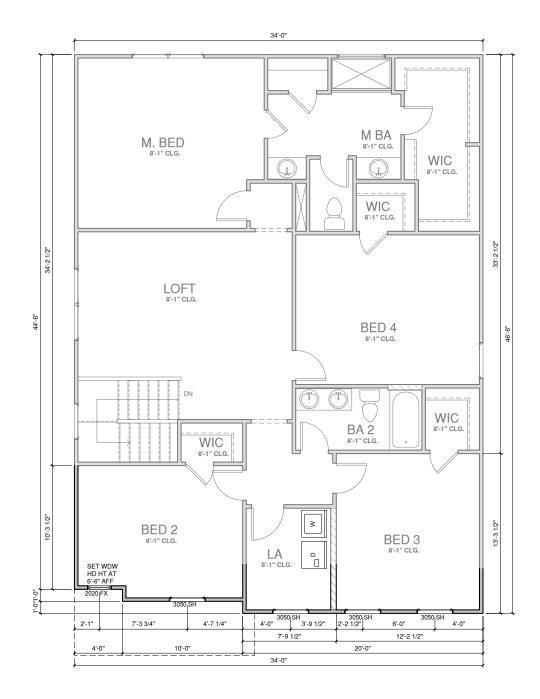




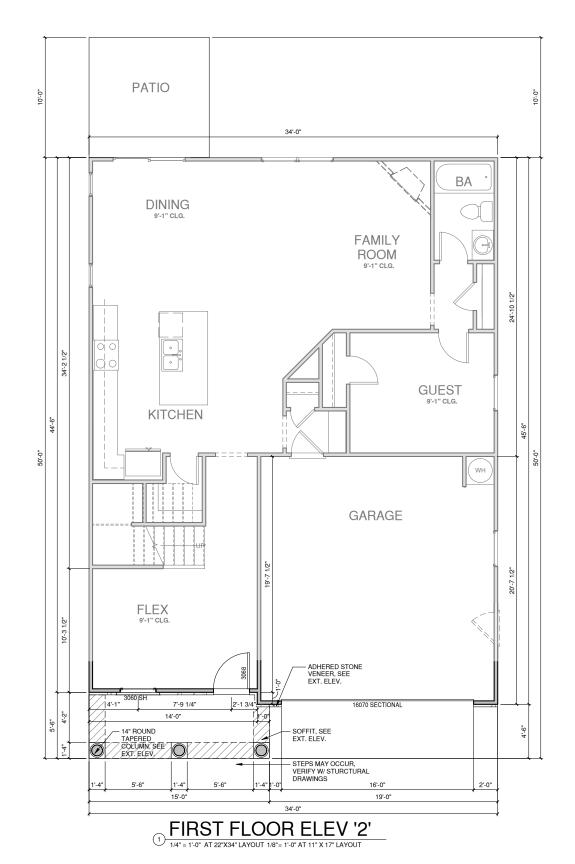



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SHEET TITLE: **FLOOR PLANS**

ELEV '2'

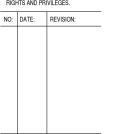PRINT DATE: 12.16.16

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FULL HEIGHT FULL HEIGHT 2X4 WOOD STUD PARTITION 2X6 WOOD STUD PARTITION

DRYWALL OPENING HEIGHT AS NOTED ON PLAN STONE VENEER

BRICK VENEER

STUD WALL BELOW HEIGHT AND STUD SIZE AS NOTED

FLOOR PLAN KEYNOTE LEGEND

HOUSE TO GARAGE FIRE SEPARATION, GARAGE/HOUSE SEPARATION AT VERTICAL SURFACES SHALL BE PROTECTED WITH ONE (1) LAYER 1/2" GYPSUM BOARD. GARAGE/HOUSE SEPARATION AT HORIZONTAL SURFACES SHALL BE PROTECTED WITH ONE (1) LAYER 5/8" TYPE "X" GYPSUM BOARD HOUSE TO GARAGE DOOR SEPARATION. PROVIDE 1 3/8" SOLID CORE DOOR OR APPROVED 20 MINUTE RATED DOOR

BENEATH STAIRS AND LANDINGS. 1/2" GYPSUM BOARD ON WALLS AND CEILING OF ENCLOSED ACCESSIBLE ADEAS

ACCESSIBLE AREAS


GAS WATER HEATER ON 18" HIGH PLATFORM
PRE-FABRICATED METAL FIREPLACE, INSTALL PER MANUFACTURER WRITTEN INSTRUCTIONS

TEMPERED SAFETY GLASS

HALF WALL, HEIGHT AS NOTED


INTERIOR SOFFITS: FFL = 8'-1" U.N.O. SFL = 7'-6" U.N.O., OPT. CASED OPENING U.N.O.

3 SHOWER, TEMPERED GLASS ENCLOSURE

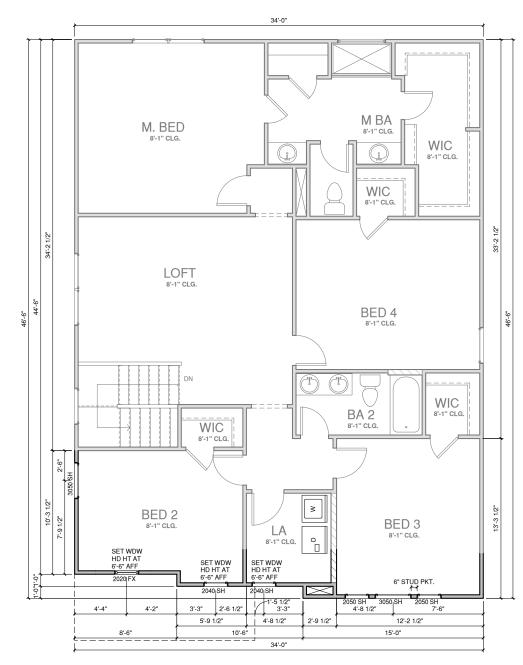

SECOND FLOOR ELEV '3'

| 1/4" = 1"-0" AT 29"YA4" | AVCALIT FOR STATE

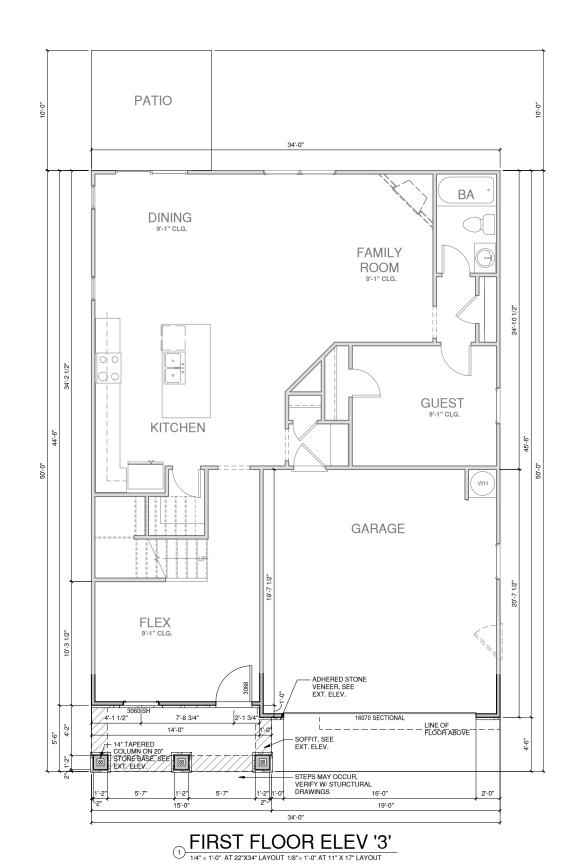



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PROJECT TITLE:

PROFESSIONAL SEAL:

JEREMIAH

CONSTRUCTION SET

CLIENTS NAME: Client Name

PROJECT NO:

SHEET TITLE: **FLOOR PLANS**

ELEV '3'

PRINT DATE: 12.16.16

SHEET NO:

FULL HEIGHT FULL HEIGHT 2X4 WOOD STUD PARTITION 2X6 WOOD STUD PARTITION

STONE VENEER DRYWALL OPENING HEIGHT AS NOTED ON PLAN

BRICK VENEER

STUD WALL BELOW HEIGHT AND STUD SIZE AS NOTED

FLOOR PLAN KEYNOTE LEGEND

HOUSE TO GARAGE FIRE SEPARATION, GARAGE/HOUSE SEPARATION AT VERTICAL SURFACES SHALL BE PROTECTED WITH ONE (1) LAYER 1/2" GYPSUM BOARD, GARAGE/HOUSE SEPARATION AT HORIZONTAL SURFACES SHALL BE PROTECTED WITH ONE (1) LAYER 5/8" TYPE "X" GYPSUM BOARD HOUSE TO GARAGE DOOR SEPARATION, PROVIDE 1 3/8" SOLID CORE DOOR OR APPROVED 20 MINUTE RATED DOOR


BENEATH STAIRS AND LANDINGS. 1/2" GYPSUM BOARD ON WALLS AND CEILING OF ENCLOSED ACCESSIBLE AREAS

GAS WATER HEATER ON 18" HIGH PLATFORM


PRE-FABRICATED METAL FIREPLACE, INSTALL PER MANUFACTURER WRITTEN INSTRUCTIONS

TEMPERED SAFETY GLASS
HALF WALL, HEIGHT AS NOTED

INTERIOR SOFFITS: FTL 8*-1" U.N.O. SFL = 7*-6" U.N.O., OPT. CASED OPENING U.N.O. SHOWER, TEMPERED GLASS ENCLOSURE

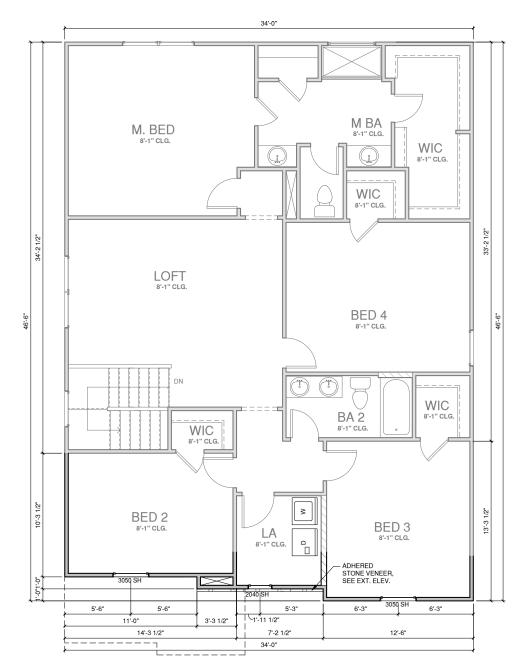




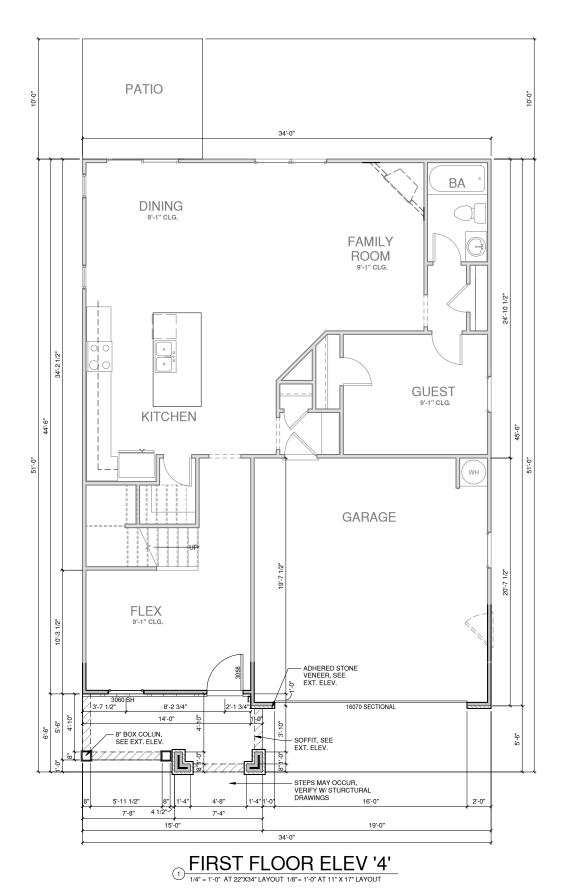



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PROFESSIONAL SEAL:

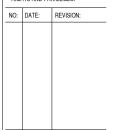PROJECT TITLE:

JEREMIAH

CONSTRUCTION SET

CLIENTS NAME: Client Name

PROJECT NO:

SHEET TITLE:

FLOOR PLANS ELEV '4'

PRINT DATE:

12.16.16

SHEET NO: **A1.4**

FULL HEIGHT FULL HEIGHT 2X6 WOOD STUD PARTITION

STONE VENEER DRYWALL OPENING HEIGHT AS NOTED ON PLAN

BRICK VENEER

STUD WALL BELOW HEIGHT AND STUD SIZE AS NOTED

FLOOR PLAN KEYNOTE LEGEND

	1	HOUSE TO GARAGE FIRE SEPARATION, GARAGE/HOUSE SEPARATION AT VERTICAL SURFACES SHALL BE PROTECTED WITH ONE (1) LAYER 1/2" GYPSUM BOARD. GARAGE/HOUSE SEPARATION AT HORIZONTAL SURFACES SHALL BE PROTECTED WITH ONE (1) LAYER 5/8" TYPE "X" GYPSUM BOARD		
	2	HOUSE TO GARAGE DOOR SEPARATION. PROVIDE 1 3/8" SOLID CORE DOOR OR APPROVED 20 MINUTE RATED DOOR		
	3	BENEATH STAIRS AND LANDINGS. 1/2" GYPSUM BOARD ON WALLS AND CEILING OF ENCLOSED ACCESSIBLE AREAS		
4 GAS WATER HEATER ON 18" HIGH PLATFORM		GAS WATER HEATER ON 18" HIGH PLATFORM		
	7	PRE-FABRICATED METAL FIREPLACE, INSTALL PER MANUFACTURER WRITTEN INSTRUCTIONS		


TEMPERED SAFETY GLASS

HALF WALL, HEIGHT AS NOTED


INTERIOR SOFFITS: FFL = 8'-1" U.N.O. SFL = 7'-6" U.N.O., OPT. CASED OPENING U.N.O.

SHOWER, TEMPERED GLASS ENCLOSURE


14 TUB-SHOWER COMBO

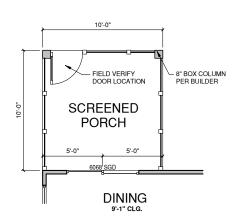


OPT. SCREENED PORCH 3 1/4" = 1'-0" AT 22"X34" LAYOUT 1/8"= 1'-0" AT 11" X 17" LAYOUT

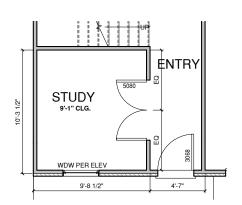

 $\underbrace{\text{OPT. STUDY I.L.O. FLEX}}_{\text{1/4" = 1'-0" AT 22"X34" LAYOUT 1/8" = 1'-0" AT 11" X 17" LAYOUT}}$

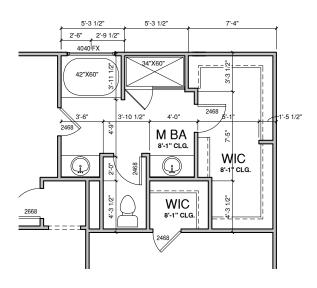

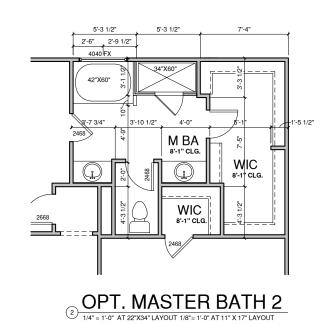



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NO:	DATE:	REVISION:

PROFESSIONAL SEAL:

PROJECT TITLE:

JEREMIAH

CONSTRUCTION SET

CLIENTS NAME: Client Name

PROJECT NO:

SHEET TITLE:

FLOOR PLAN OPTIONS

PRINT DATE:

12.16.16

SHEET NO:





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PROFESSIONAL SEAL:

PROJECT TITLE:

JEREMIAH

CONSTRUCTION SET

CLIENTS NAME: Client Name

PROJECT NO:

Plan 4 SHEET TITLE:


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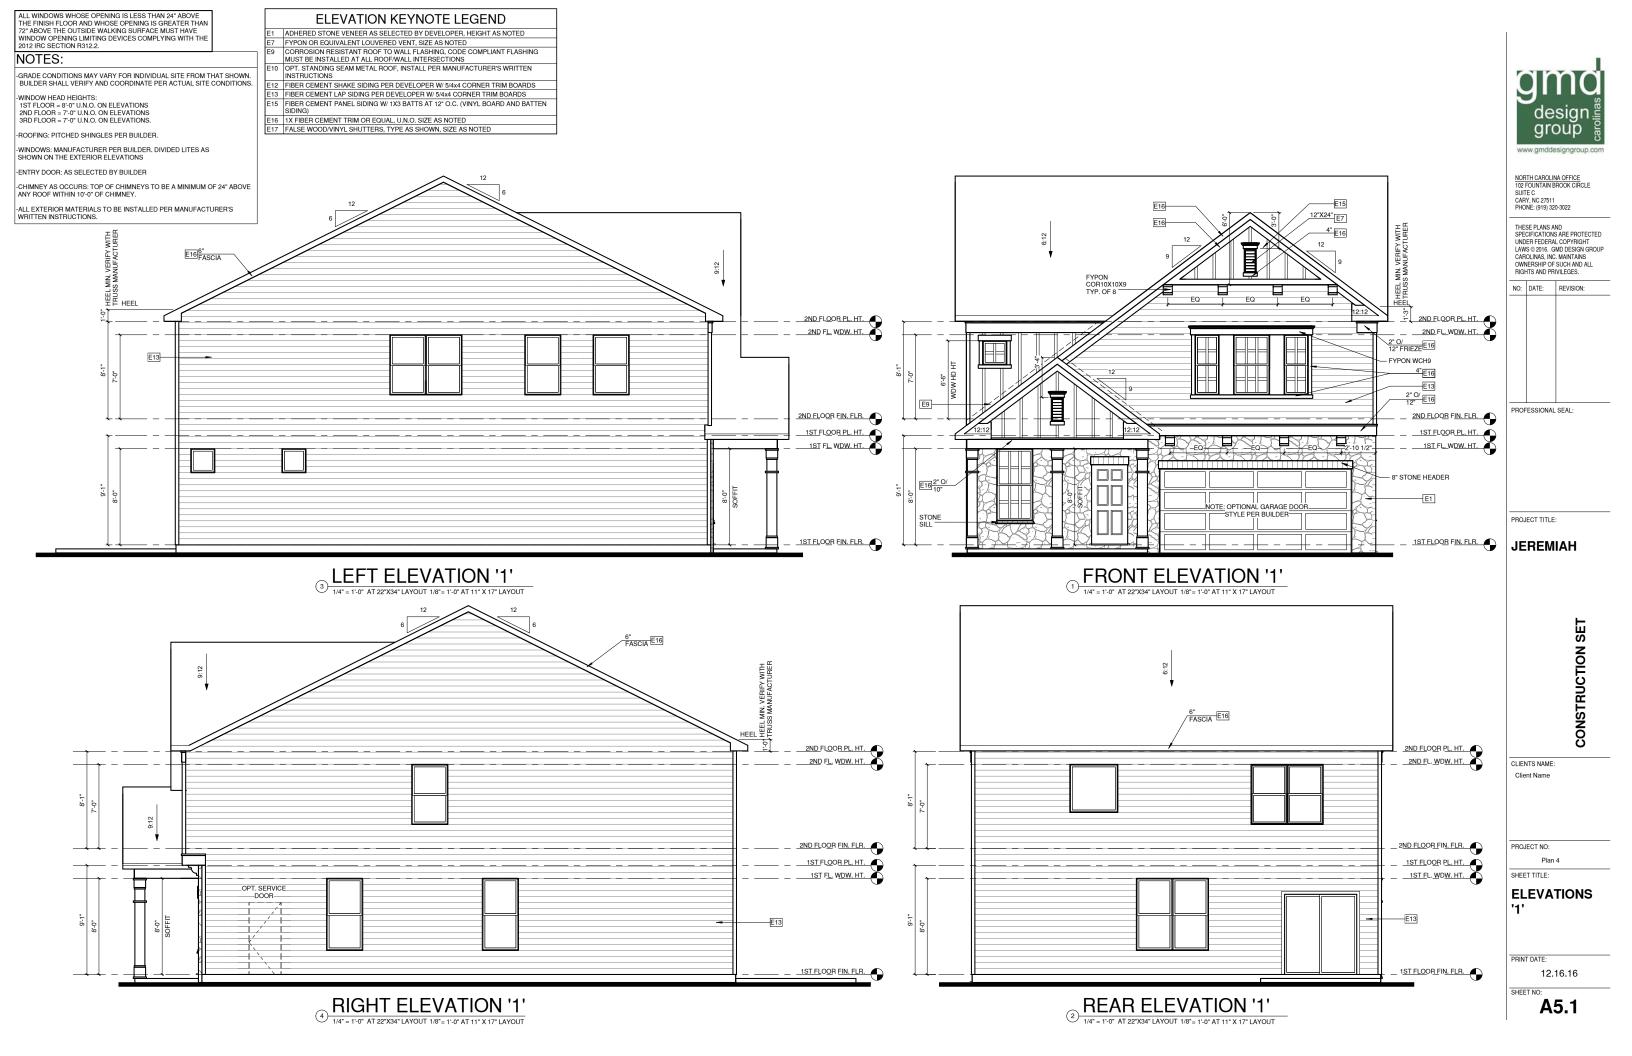
PRINT DATE:

12.16.16

SHEET NO:

A4.1



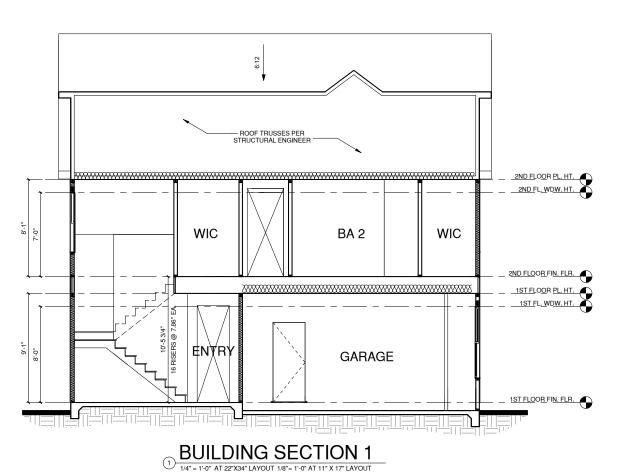

ALL WINDOWS WHOSE OPENING IS LESS THAN 24" ABOVE THE FINISH FLOOR AND WHOSE OPENING IS GREATER THAN 72" ABOVE THE OUTSIDE WALKING SURFACE MUST HAVE WINDOW OPENING LIMITING DEVICES COMPLYING WITH THE 2012 IRC SECTION R312.2.

NOTES:

-GRADE CONDITIONS MAY VARY FOR INDIVIDUAL SITE FROM THAT SHOWN. BUILDER SHALL VERIFY AND COORDINATE PER ACTUAL SITE CONDITIONS.

-WINDOW HEAD HEIGHTS: 1ST FLOOR = 8'-0" U.N.O. ON ELEVATIONS 2ND FLOOR = 7'-0" U.N.O. ON ELEVATIONS 3RD FLOOR = 7'-0" U.N.O. ON ELEVATIONS.

-ROOFING: PITCHED SHINGLES PER BUILDER.

-ENTRY DOOR: AS SELECTED BY BUILDER

-CHIMNEY AS OCCURS: TOP OF CHIMNEYS TO BE A MINIMUM OF 24" ABOVE ANY ROOF WITHIN 10'-0" OF CHIMNEY.

-ALL EXTERIOR MATERIALS TO BE INSTALLED PER MANUFACTURER'S

ELEVATION KEYNOTE LEGEND

- ADHERED STONE VENEER AS SELECTED BY DEVELOPER, HEIGHT AS NOTED
- FYPON OR EQUIVALENT LOUVERED VENT, SIZE AS NOTED


 CORROSION RESISTANT ROOF TO WALL FLASHING, CODE COMPLIANT FLASHING
 MUST BE INSTALLED AT ALL ROOF/WALL INTERSECTIONS
- E10 OPT. STANDING SEAM METAL ROOF, INSTALL PER MANUFACTURER'S WRITTEN INSTRUCTIONS
- 2 FIBER CEMENT SHAKE SIDING PER DEVELOPER W/ 5/4x4 CORNER TRIM BOARDS
- E15 FIBER CEMENT PANEL SIDING W/ 1X3 BATTS AT 12* O.C. (VINYL BOARD AND BATTEN SIDING) FIBER CEMENT LAP SIDING PER DEVELOPER W/ 5/4x4 CORNER TRIM BOARDS
- E16 1X FIBER CEMENT TRIM OR EQUAL, U.N.O. SIZE AS NOTED


 E17 FALSE WOOD/VINYL SHUTTERS, TYPE AS SHOWN, SIZE AS NOTEI



REAR ELEVATION W/ OPT. SCREENED PORCH

1/4" = 1'-0" AT 22"X34" LAYOUT 1/8"= 1'-0" AT 11" X 17" LAYOUT

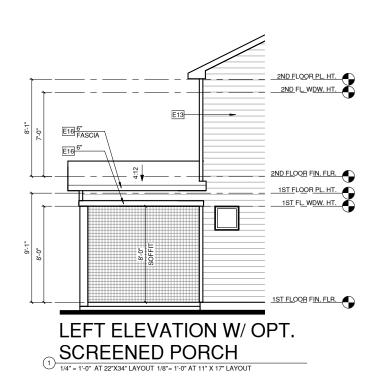

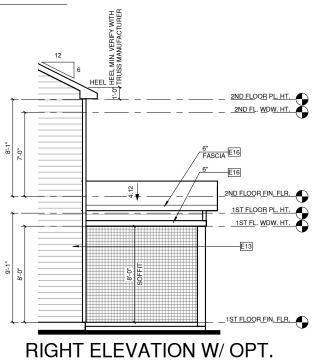

② SCREENED PORCH

(2) 1/4" = 1'-0" AT 22"X34" LAYOUT 1/8" = 1'-0" AT 11" X 17" LAYOUT



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NO:	DATE:	REVISION:

PROFESSIONAL SEAL:

PROJECT TITLE:

JEREMIAH

CONSTRUCTION SET

CLIENTS NAME: Client Name

PROJECT NO:

SHEET TITLE:

ELEV OPTIONS

PRINT DATE:

12.16.16

A5.1.1

GENERAL CONTRACTOR SHALL VERIFY THE
NET FREE VENTILATION OF THE VENT PRODUCT
SELECTED BY OWNER. VERIFY WITH
MANUFACTURER OF HIGH AND LOW VENTS TO
BE USED FOR MINIMUM CALCULATED VENTS REQUIRED. THE REQUIRED VENTILATION SHALL BE MAINTAINED. PROVIDE INSULATION STOP SUCH THAT INSULATION DOES NOT OBSTRUCT FREE AIR MOVEMENT AS REQUIRED BY THE BUILDING OFFICIAL.

ALL OVERLAP FRAMED ROOF AREAS SHALL HAVE OPENINGS BETWEEN THE ADJACENT ATTICS IN THE ROOF SHEATHING (AS ALLOWED BY THE STRUCTURAL ENGINEER) TO ALLOW PASSAGE AND ATTIC VENTILATION BETWEEN THE TAYLOR OF THE STRUCTURAL CONTINUE THE OFFICE OF THE STRUCTURAL OF THE OFFICE OF THE OFFICE OFFI THE TWO OR ISOLATED ATTIC SPACES SHALL BE VENTED INDEPENDENTLY TO CBC REQUIREMENTS.

PER DEVELOPER, AT ALL CANTILEVERED FLOORS, CANTILEVERED ARCHITECTURAL POP-OUTS, AND ANY DOUBLE FRAMING PROJECTIONS THAT ARE SEPARATED FROM THE VENTING CALCULATIONS SHOWN ABOVE, PROVIDE A CONTINUOUS 2" CORROSION RESISTANT SOFFIT VENT AT UNDERSIDE OF FRAMED ELEMENT.

1/300 RATIO:

AS AN ALTERNATE TO THE 1/150 RATIO LISTED, THE NET FREE CROSS-VENTILATION AREA MAY BE REDUCED TO 1/300 WHEN A VAPOR BARRIER IS HAVING A TRANSMISSION RATE NOT EXCEEDING I-PERM INSTALLED ON THE WARM-IN-WINTER SIDE OF THE CEILING.

GENERAL CONTRACTOR SHALL VERIFY THE NET FREE VENTILATION OF THE VENT PRODUCT SELECTED BY OWNER. VERIFY WITH MANUFACTURER OF HIGH AND LOW VENTS TO BE USED FOR MINIMUM CALCULATED VENTS REQUIRED. THE REQUIRED VENTILATION SHALL BE MAINTAINED. PROVIDE INSULATION STOP SUCH THAT INSULATION DOES NOT OBSTRUCT FREE AIR MOVEMENT AS REQUIRED BY THE BUILDING OFFICIAL.

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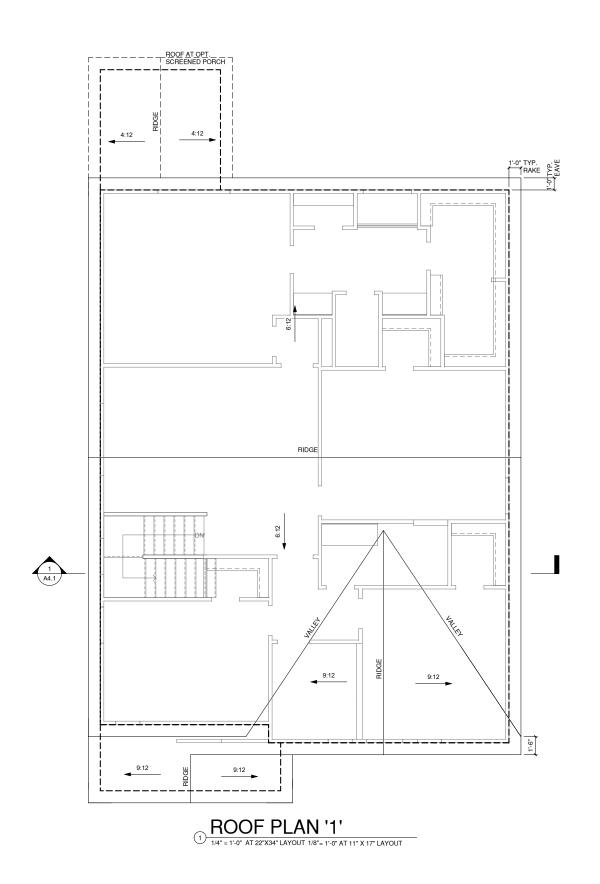
PER DEVELOPER, AT ALL CANTILEVERED FLOORS,
CANTILEVERED ARCHITECTURAL POP-OUTS, AND ANY
DOUBLE FRAMING PROJECTIONS THAT ARE SEPARATED
FROM THE VENTING CALCULATIONS SHOWN ABOVE,
PROVIDE A CONTINUOUS 2" CORROSION RESISTANT SOFFIT
VENT AT UNDERSIDE OF FRAMED ELEMENT.

NOTES:

- ALL ROOF DRAINAGE SHALL BE PIPED TO STREET OR APPROVED DRAINAGE FACILITY.
- DASHED LINES INDICATE WALL BELOW. LOCATE GUTTER AND DOWNSPOUTS PER BUILDER.

 PITCHED ROOFS AS NOTED.
- TRUSS MANUFACTURER SHALL SUBMIT STRUCTURAL CALCS AND SHOP DRAWING TO THE BUILDER'S GENERAL CONTRACTOR AND BUILDING DEPARTMENT FOR REVIEW PRIOR TO FABRICATIONS.
- ALL PLUMBING VENTS SHALL BE COMBINED INTO A MINIMUM AMOUNT OF ROOF PENETRATIONS. ALL ROOF PENETRATIONS SHALL OCCUR TO THE REAR OF THE MAIN RIDGE.

ROOF VENT CALC. ELEV. '1'			
Name	Area	1/300 RATIO AT HIGH & LOW	1/150 RATIO AT HIGH & LOW
AREA 1	1542 SF	370.07 in ²	740.13 in ²
AREA 2	82 SF	19.70 in ²	39.39 in ²
AREA 3	100 SF	24.00 in ²	48.00 in ²





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PROFESSIONAL SEAL:

PROJECT TITLE:

JEREMIAH

CONSTRUCTION SET

CLIENTS NAME: Client Name

PROJECT NO:

Plan 4 SHEET TITLE:


ROOF PLAN '1'

PRINT DATE:

12.16.16

SHEET NO

A5.1.2

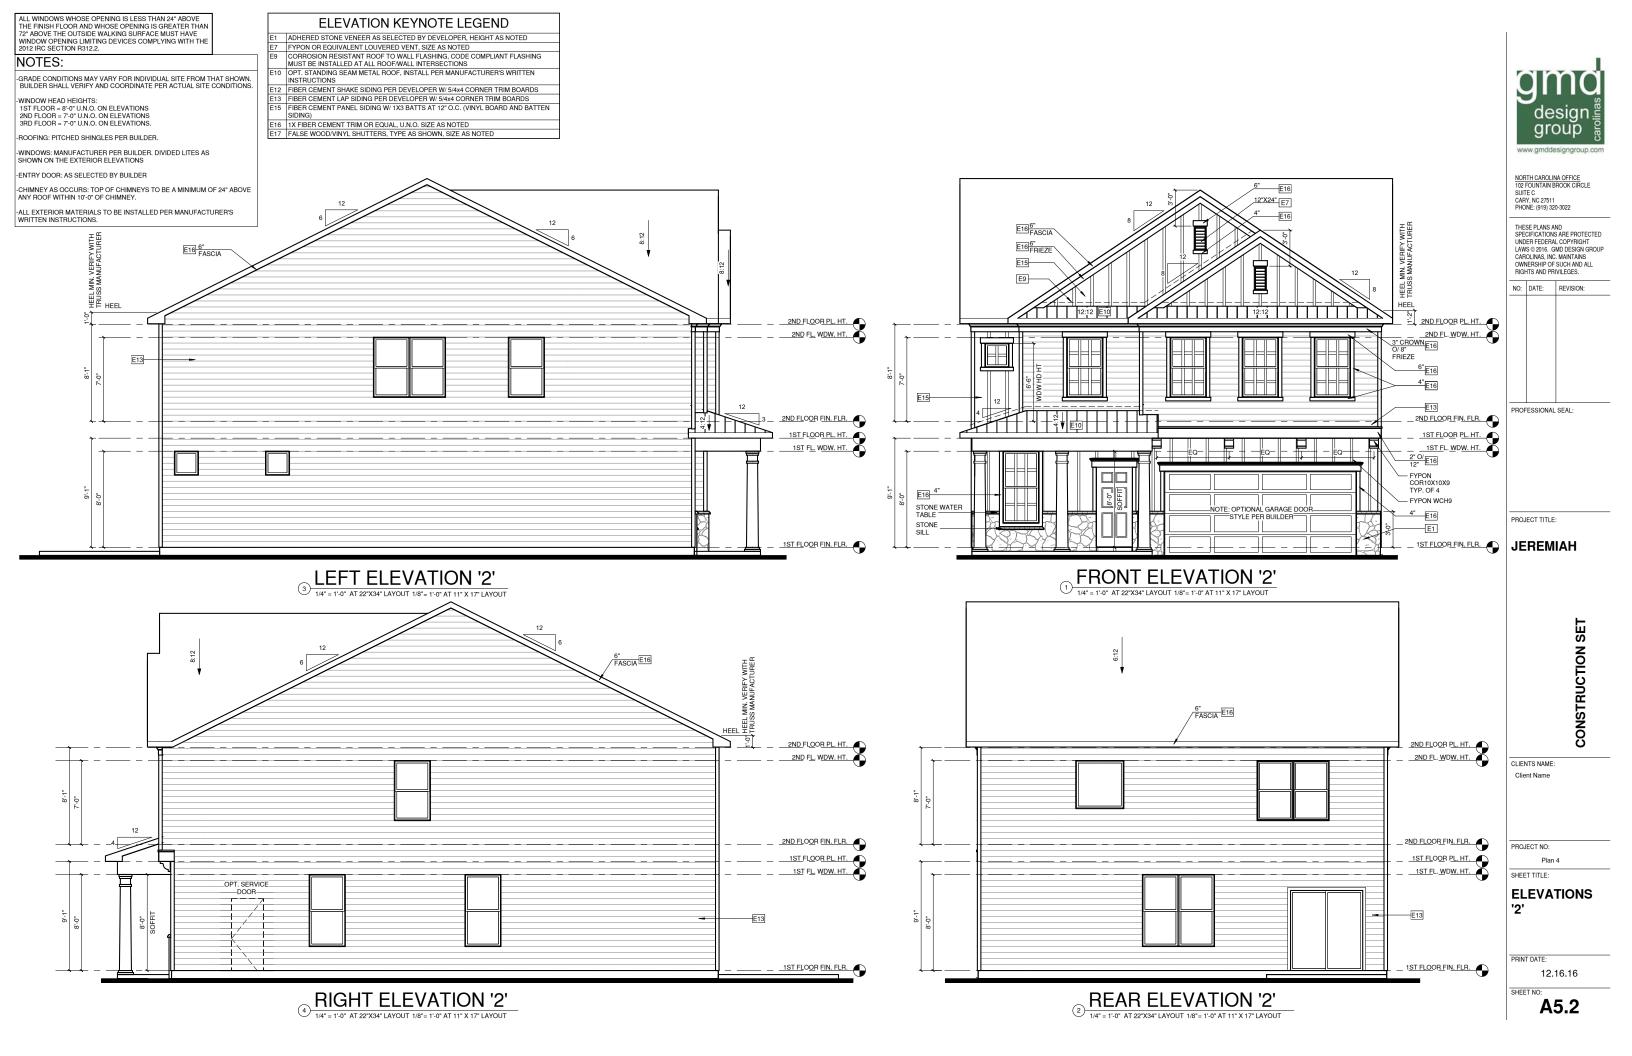

GENERAL CONTRACTOR SHALL VERIFY THE NET FREE VENTILATION OF THE VENT PRODUCT SELECTED BY OWNER. VERIFY WITH MANUFACTURER OF HIGH AND LOW VENTS TO MANUFACTURER OF HIGH AND LOW VENTS TO BE USED FOR MINIMUM CALCULATED VENTS REQUIRED. THE REQUIRED VENTILATION SHALL BE MAINTAINED. PROVIDE INSULATION STOP SUCH THAT INSULATION DOES NOT OBSTRUCT FREE AIR MOVEMENT AS REQUIRED BY THE BUILDING OFFICIAL.

ALL OVERLAP FRAMED ROOF AREAS SHALL HAVE OPENINGS BETWEEN THE ADJACENT ATTICS IN THE ROOF SHEATHING (AS ALLOWED BY THE STRUCTURAL ENGINEER) TO ALLOW PASSAGE AND ATTIC VENTILATION BETWEEN THE TWO OR ISOLATED ATTIC SPACES SHALL BE VENTED INDEPENDENTLY TO CBC REQUIREMENTS.

PER DEVELOPER, AT ALL CANTILEVERED FLOORS, CANTILEVERED ARCHITECTURAL POPOUTS, AND ANY DOUBLE FRAMING PROJECTIONS THAT ARE SEPARATED FROM THE VENTING CALCULATIONS SHOWN ABOVE, PROVIDE A CONTINUOUS 2" CORROSION RESISTANT SOFFIT VENT AT UNDERSIDE OF FRAMED ELEMENT.

1/300 RATIO:

AS AN ALTERNATE TO THE 1/150 RATIO LISTED, THE NET FREE CROSS-VENTILATION AREA MAY BE REDUCED TO 1/300 WHEN A VAPOR BARRIER IS HAVING A TRANSMISSION RATE NOT EXCEEDING I-PERM INSTALLED ON THE WARM-IN-WINTER SIDE OF THE CEILING.

GENERAL CONTRACTOR SHALL VERIFY THE NET FREE
VENTILATION OF THE VENT PRODUCT SELECTED BY OWNER.
VERIFY WITH MANUFACTURER OF HIGH AND LOW VENTS TO
BE USED FOR MINIMUM CALCULATED VENTS REQUIRED. THE
REQUIRED VENTILATION SHALL BE MAINTAINED. PROVIDE
INSULATION STOP SUCH THAT INSULATION DOES NOT
OBSTRUCT FREE AIR MOVEMENT AS REQUIRED BY THE
BUILD DIVE OFFICIAL. BUILDING OFFICIAL.

ALL OVERLAP FRAMED ROOF AREAS SHALL HAVE OPENINGS BETWEEN THE ADJACENT ATTICS IN THE ROOF SHEATHING (AS ALLOWED BY THE STRUCTURAL ENGINEER) TO ALLOW PASSAGE AND ATTIC VENTILATION BETWEEN THE TWO OR ISOLATED ATTIC SPACES SHALL BE VENTED INDEPENDENTLY TO CBC REQUIREMENTS.


PER DEVELOPER, AT ALL CANTILEVERED FLOORS, CANTILEVERED ARCHITECTURAL POP-OUTS, AND ANY DOUBLE FRAMING PROJECTIONS THAT ARE SEPARATED FROM THE VENTING CALCULATIONS SHOWN ABOVE, PROVIDE A CONTINUOUS 2" CORROSION RESISTANT SOFFIT VENT AT UNDERSIDE OF FRAMED ELEMENT.

NOTES:

- ALL ROOF DRAINAGE SHALL BE PIPED TO STREET OR APPROVED DRAINAGE FACILITY.
 DASHED LINES INDICATE WALL BELOW.
 LOCATE GUTTER AND DOWNSPOUTS PER
- BUILDER.

 PITCHED ROOFS AS NOTED.
- TRUSS MANUFACTURER SHALL SUBMIT STRUCTURAL CALCS AND SHOP DRAWING TO THE BUILDER'S GENERAL CONTRACTOR AND BUILDING DEPARTMENT FOR REVIEW PRIOR TO FABRICATIONS.
 ALL PLUMBING VENTS SHALL BE COMBINED INTO A MINIMUM AMOUNT OF ROOP PENETRATIONS. ALL ROOP PENETRATIONS SHALL OCCUR TO THE REAR OF THE MAIN RIDGE.

ROOF VENT CALC. ELEV. '2'			
Name	Area	1/300 RATIO AT HIGH & LOW	1/150 RATIO AT HIGH & LOW
AREA 1	1563 SF	375.12 in ²	750.24 in ²
AREA 2	71 SF	16.92 in ²	33.84 in ²
AREA 3	100 SF	24.00 in ²	48.00 in ²

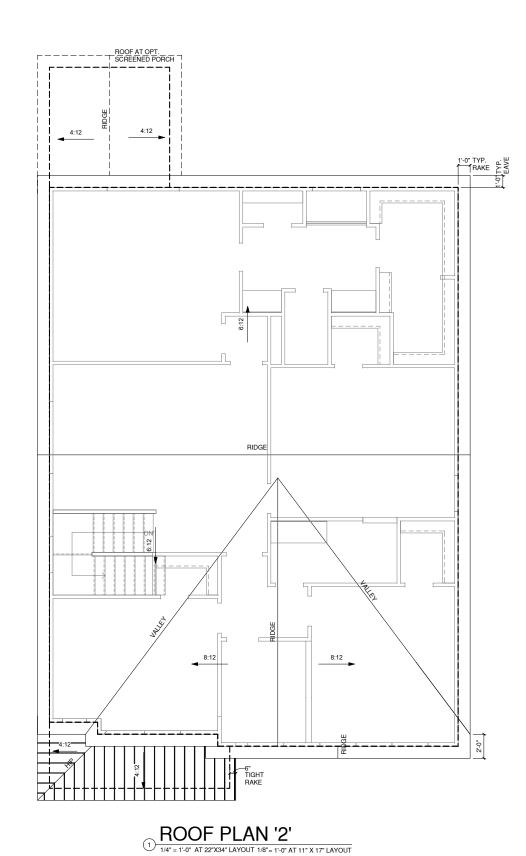



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PROFESSIONAL SEAL:

PROJECT TITLE:

JEREMIAH

CONSTRUCTION SET

CLIENTS NAME: Client Name

PROJECT NO:

Plan 4 SHEET TITLE:

ROOF PLAN '2'

PRINT DATE:

12.16.16

SHEET NO

A5.2.1



GENERAL CONTRACTOR SHALL VERIFY THE
NET FREE VENTILATION OF THE VENT PRODUCT
SELECTED BY OWNER. VERIFY WITH
MANUFACTURER OF HIGH AND LOW VENTS TO
BE USED FOR MINIMUM CALCULATED VENTS
REQUIRED. THE REQUIRED VENTILATION SHALL
BE MAINTAINED. PROVIDE INSULATION STOP
SUCH THAT INSULATION DOES NOT OBSTRUCT
EBES AIR MOVEMENT AS BEQUIRED BY THE FREE AIR MOVEMENT AS REQUIRED BY THE BUILDING OFFICIAL.

ALL OVERLAP FRAMED ROOF AREAS SHALL HAVE OPENINGS BETWEEN THE ADJACENT ATTICS IN THE ROOF SHEATHING (AS ALLOWED BY THE STRUCTURAL ENGINEER) TO ALLOW PASSAGE AND ATTIC VENTILATION BETWEEN THE TWO OR ISOLATED ATTIC SPACES SHALL BE VENTED INDEPENDENTLY TO CBC REQUIREMENTS.

PER DEVELOPER, AT ALL CANTILEVERED FLOORS, CANTILEVERED ARCHITECTURAL POPOUTS, AND ANY DOUBLE FRAMING PROJECTIONS THAT ARE SEPARATED FROM THE VENTING CALCULATIONS SHOWN ABOVE, PROVIDE A CONTINUOUS 2" CORROSION RESISTANT SOFFIT VENT AT UNDERSIDE OF FRAMED ELEMENT.

NOTES:

1/300 RATIO:

- ALL ROOF DRAINAGE SHALL BE PIPED TO STREET OR APPROVED DRAINAGE FACILITY.
 DASHED LINES INDICATE WALL BELOW.
 LOCATE GUTTER AND DOWNSPOUTS PER
- BUILDER. PITCHED ROOFS AS NOTED.

AS AN ALTERNATE TO THE 1/150 RATIO LISTED, THE NET FREE CROSS-VENTILATION AREA MAY BE REDUCED TO 1/300 WHEN A VAPOR BARRIER IS HAVING A TRANSMISSION RATE NOT EXCEEDING I-PERM INSTALLED ON THE WARM-IN-WINTER SIDE OF THE CEILING.

GENERAL CONTRACTOR SHALL VERIFY THE NET FREE VENTILATION OF THE VENT PRODUCT SELECTED BY OWNER. VERIFY WITH MANUFACTURER OF HIGH AND LOW VENTS TO BE USED FOR MINIMUM CALCULATED VENTS REQUIRED. THE

REQUIRED VENTILATION SHALL BE MAINTAINED. PROVIDE INSULATION STOP SUCH THAT INSULATION DOES NOT OBSTRUCT FREE AIR MOVEMENT AS REQUIRED BY THE BUILDING OFFICIAL.


ALL OVERLAP FRAMED ROOF AREAS SHALL HAVE OPENINGS BETWEEN THE ADJACENT ATTICS IN THE ROOF SHEATHING (AS ALLOWED BY THE STRUCTURAL ENGINEER) TO ALLOW PASSAGE AND ATTIC VENTILATION BETWEEN THE TWO OR ISOLATED ATTIC SPACES SHALL BE VENTED INDEPENDENTLY TO GBC REQUIREMENTS.

PER DEVELOPER, AT ALL CANTILEVERED FLOORS, CANTILEVERED ARCHITECTURAL POP-OUTS, AND ANY DOUBLE FRAMING PROJECTIONS THAT ARE SEPARATED FROM THE VENTING CALCULATIONS SHOWN ABOVE, PROVIDE A CONTINUOUS 2" CORROSION RESISTANT SOFFIT VENT AT UNDERSIDE OF FRAMED ELEMENT.

TRUSS MANUFACTURER SHALL SUBMIT STRUCTURAL CALCS AND SHOP DRAWING TO THE BUILDER'S GENERAL CONTRACTOR AND BUILDING DEPARTMENT FOR REVIEW PRIOR TO FABRICATIONS.

ALL PLUMBING VENTS SHALL BE COMBINED INTO A MINIMUM AMOUNT OF ROOF PENETRATIONS. ALL ROOF PENETRATIONS SHALL OCCUR TO THE REAR OF THE MAIN RIDGE.

ROOF VENT CALC, ELEV, '3'				
TIOOT VEIVI OALO, LLLV. 3				
Name	Area	1/300 RATIO AT HIGH & LOW	1/150 RATIO AT HIGH & LOW	
AREA 1	1554 SF	372.84 in ²	745.68 in ²	
AREA 2	76 SF	18.24 in ²	36.48 in ²	
AREA 3	100 SF	24 00 in ²	48 00 in ²	

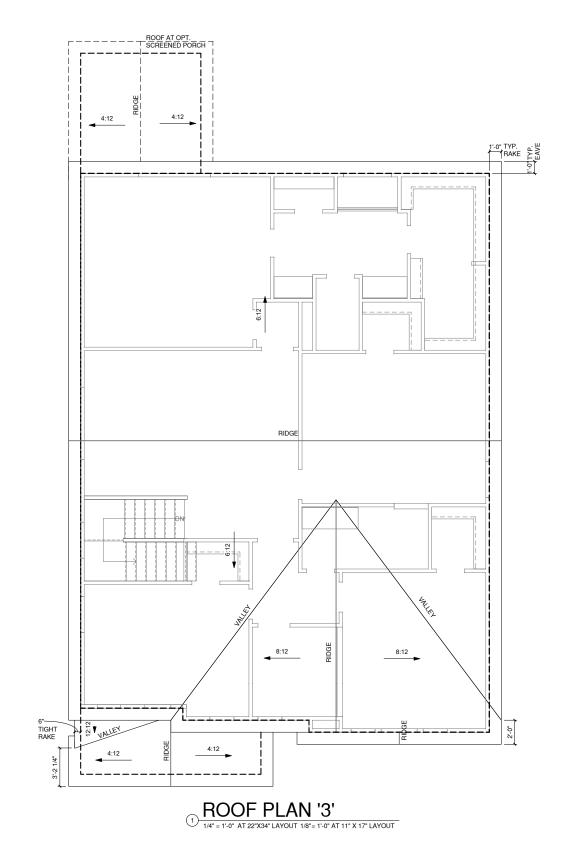



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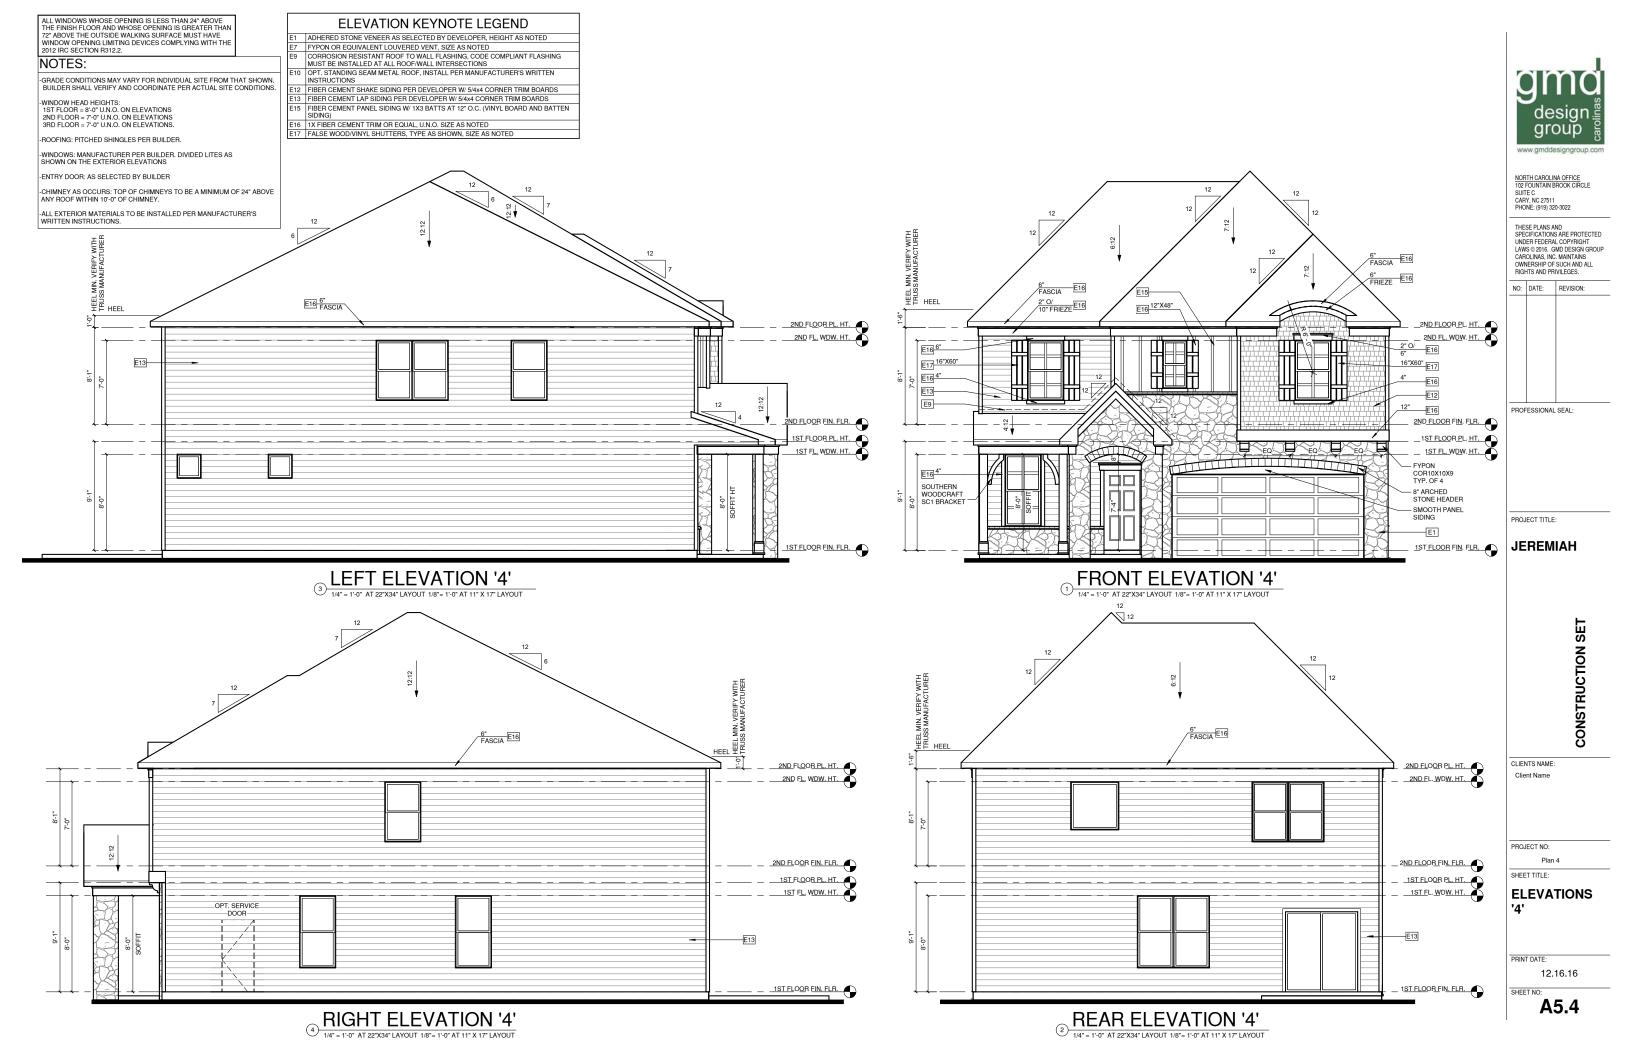
Plan 4 SHEET TITLE:

ROOF PLAN '3'

PRINT DATE: 12.16.16

SHEET NO

A5.3.1



GENERAL CONTRACTOR SHALL VERIFY THE
NET FREE VENTILATION OF THE VENT PRODUCT
SELECTED BY OWNER. VERIFY WITH
MANUFACTURER OF HIGH AND LOW VENTS TO
BE USED FOR MINIMUM CALCULATED VENTS
REQUIRED. THE REQUIRED VENTILATION SHALL
BE MAINTAINED. PROVIDE INSULATION STOP
SUCH THAT INSULATION DOES NOT OBSTRUCT
FREE AIR MOVEMENT AS REQUIRED BY THE
BILLI DING OSEICIA! BUILDING OFFICIAL.

ALL OVERLAP FRAMED ROOF AREAS SHALL HAVE OPENINGS BETWEEN THE ADJACENT ATTICS IN THE ROOF SHEATHING (AS ALLOWED BY THE STRUCTURAL ENGINEER) TO ALLOW PASSAGE AND ATTIC VENTILATION BETWEEN THE TWO OR ISOLATED ATTIC SPACES SHALL BE VENTED INDEPENDENTILY JO FOR BE VENTED INDEPENDENTLY TO CBC REQUIREMENTS.

PER DEVELOPER, AT ALL CANTILEVERED FLOORS, CANTILEVERED ARCHITECTURAL POPOUTS, AND ANY DOUBLE FRAMING PROJECTIONS THAT ARE SEPARATED FROM THE VENTING CALCULATIONS SHOWN ABOVE, PROVIDE A CONTINUOUS 2" CORROSION RESISTANT SOFFIT VENT AT UNDERSIDE OF FRAMED ELEMENT.

1/300 RATIO:

AS AN ALTERNATE TO THE 1/150 RATIO LISTED, THE NET FREE CROSS-VENTILATION AREA MAY BE REDUCED TO 1/300 WHEN A VAPOR BARRIER IS HAVING A TRANSMISSION RATE NOT EXCEEDING I-PERM INSTALLED ON THE WARM-IN-WINTER SIDE OF THE CEILING.

GENERAL CONTRACTOR SHALL VERIFY THE NET FREE VENTILATION OF THE VENT PRODUCT SELECTED BY OWNER. VERIFY WITH MANUFACTURER OF HIGH AND LOW VENTS TO BE USED FOR MINIMUM CALCULATED VENTS REQUIRED. THE REQUIRED VENTILATION SHALL BE MAINTAINED. PROVIDE INSULATION STOP SUCH THAT INSULATION DOES NOT OBSTRUCT FREE AIR MOVEMENT AS REQUIRED BY THE BUILDING OFFICIAL.


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NOTES:

- ALL ROOF DRAINAGE SHALL BE PIPED TO STREET OR APPROVED DRAINAGE FACILITY.
 DASHED LINES INDICATE WALL BELOW.
 LOCATE GUTTER AND DOWNSPOUTS PER
- PITCHED ROOFS AS NOTED.
- TRUSS MANUFACTURER SHALL SUBMIT STRUCTURAL CALCS AND SHOP DRAWING TO THE BUILDER'S GENERAL CONTRACTOR AND BUILDING DEPARTMENT FOR REVIEW PRIOR TO FABRICATIONS. ALL PLUMBING VENTS SHALL BE COMBINED INTO A MINIMUM AMOUNT OF ROOF PENETRATIONS. ALL ROOF PENETRATIONS SHALL GOOF PENETRATIONS.

	ROOF VENT CALC. ELEV. '4'			
	Name	Area	1/300 RATIO AT HIGH & LOW	1/150 RATIO AT HIGH & LOW
AF	REA 1	1549 SF	371.64 in ²	743.28 in ²
AF	REA 2	86 SF	20.60 in ²	41.20 in ²
AF	REA 3	100 SF	24.00 in ²	48.00 in ²



design group
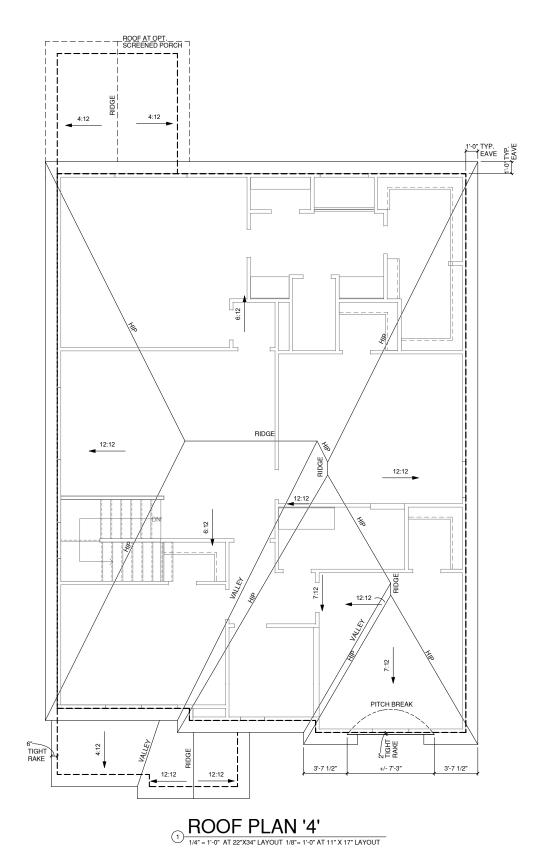
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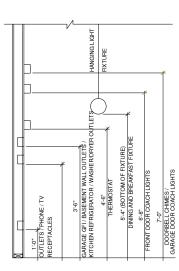
ROOF PLAN '4'

PRINT DATE:


12.16.16

SHEET NO

A5.4.1



STANDARD ELECTRICAL BOX HEIGHTS

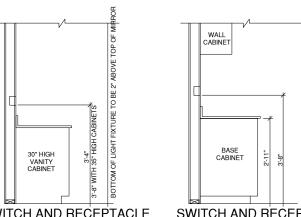

SWITCH AND RECEPTACLE BOXES OVER BATH CABINETS BOXES OVER KITCHEN CABINETS

NOTES:

-PROVIDE GROUNDING ELECTRICAL ROD PER LOCAL CODES.

-PROVIDE AND INSTALL ARC FAULT CIRCUIT-INTERRUPTERS (AFCI) AS REQUIRED BY NATIONAL ELECTRICAL CODE (NEC) AND MEETING THE REQURIEMENTS OF ALL GOVERNING CODES.

ALL EXHAUST FANS SHALL HAVE BACKDRAFT DAMPERS

-FAN/LIGHTS IN WET/DAMP LOCATIONS SHALL BE LABLED "SUITABLE FOR WET OR DAMP LOCATIONS."

-ELECTRICAL SYSTEMS ARE SHOWN FOR INTENT ONLY. THESE SYSTEMS SHALL BE ENGINEERED BY OTHERS. THE CONTRACTOR SHALL BE RESPONSIBLE FOR PROPER INSTALLATION AND PLACEMENT.

-PROVIDE AND INSTALL LOCALLY CERTIFIED SMOKE DETECTORS AND CO2 DETECTORS AS REQUIRED BY NATIONAL FIRE PROTECTION ASSOCIATION (NFPA) AND MEETING THE REQUIREMENTS OF ALL GOVERNING CODES.

-PROVIDE AND INSTALL GROUND FAULT CIRCUIT-INTERRUPTERS (GFI) AS REQUIRED BY NATIONAL ELECTRICAL CODE (NEC) AND MEETING THE REQUIREMENTS OF ALL GOVERNING CODES.


-ELECTRICAL CONTRACTOR TO PROVIDE REQURIED DIRECT HOOK-UPS/CUTOFFS.

-HVAC CONTRACTOR TO VERIFY THERMOSTAT LOCATIONS.


-ALL ELECTRICAL AND MECHANICAL EQUIPMENT (FURNACES, A/C UNITS, ELECTRICAL PANELS, SANITARY SUMP PITS, DRAING TILE SUMP, AND WATER HEATERS) ARE SUBJECT TO RELOCATOIN DUE TO FIELD CONDITIONS.

PROVIDE POWER, LIGHT AND SWITCH AS REQUIRED FOR ATTIC FURNACE PER CODE AND MANUFACTURER'S WRITTEN INSTRUCTIONS.


MANUFAC	TURER'S WRITTEN INSTRUCTIONS.		
LEGE	ND:		
P	DUPLEX OUTLET	1-6-	CEILING MOUNTED INCANDESCENT LIGHT FIXTURE
₩P/GFI	WEATHERPROOF GFI DUPLEX OUTLET	1	WALL MOUNTED INCANDESCENT LIGHT FIXUTRE
Pgfi	GROUND-FAULT CIRCUIT- INTERRUPTER DUPLEX OUTLET	H	RECESSED INCANDESCENT LIGHT FIXTURE
P	HALF-SWITCHED DUPLEX OUTLET	74	(VP) = VAPOR PROOF
₽ ₂₂₀ ∨	220 VOLT OUTLET		EXHAUST FAN (VENT TO EXTERIOR)
()	REINFORCED JUNCTION BOX	-	EXHAUST FAN/LIGHT COMBINATION (VENT TO EXTERIOR)
\$	WALL SWITCH	<u> </u>	(,,,,,,,,,,,,,,,,,,,,,,,,,,,,,,,,,,,,,,
\$3	THREE-WAY SWITCH	\boxtimes	FLUORESCENT LIGHT FIXTURE
\$4	FOUR-WAY SWITCH		TECH HUB SYSTEM
СН	CHIMES		CEILING FAN
Ŧ	PUSHBUTTON SWITCH		(PROVIDE ADEQUATE SUPPORT)
SD	110V SMOKE DETECTOR W/ BATTERY BACKUP	S.C.	CEILING FAN WITH INCANDESCENT LIGHT FIXTURE
@	CO2 DETECTOR		(PROVIDE ADEQUATE SUPPORT)
T	THERMOSTAT		GAS SUPPLY WITH VALVE
PH	TELEPHONE	<u> </u>	
TV	TELEVISION	HB	HOSE BIBB
	ELECTRIC METER	-t _{cw}	1/4" WATER STUB OUT
_	ELECTRIC PANEL	- X	WALL SCONCE
_	DISCONNECT SWITCH	74	WALL SCONCE

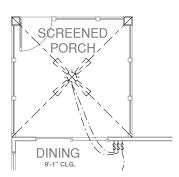

2 OPT. SCREENED PORCH 1/4" = 1'-0" AT 22"X34" LAYOUT 1/8" = 1'-0" AT 11" X 17" LAYOUT

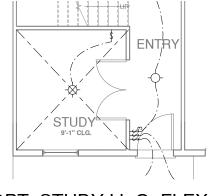



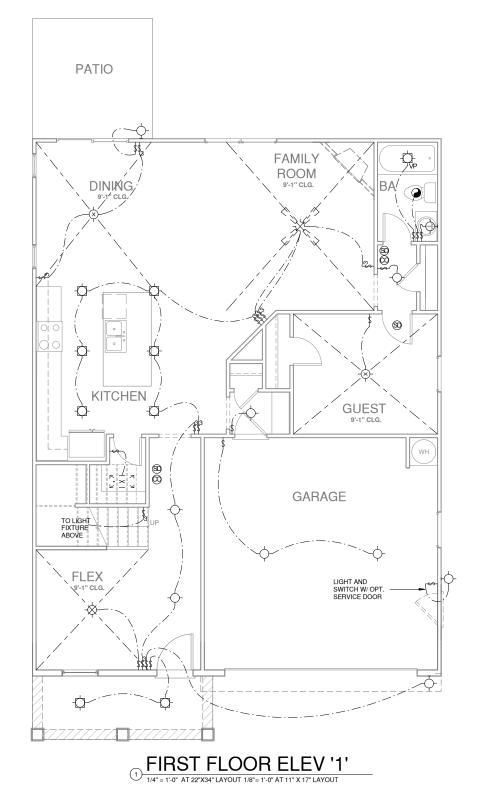



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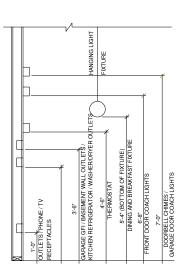
Plan SHEET TITLE:

FIRST FLOOR UTILITY PLAN


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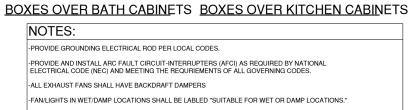
SHEET NO:

E1.0



STANDARD ELECTRICAL BOX HEIGHTS



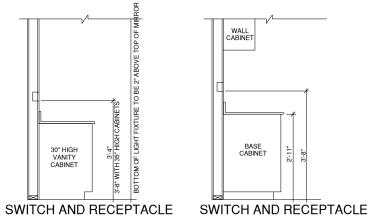

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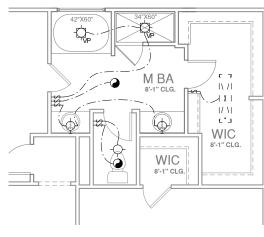
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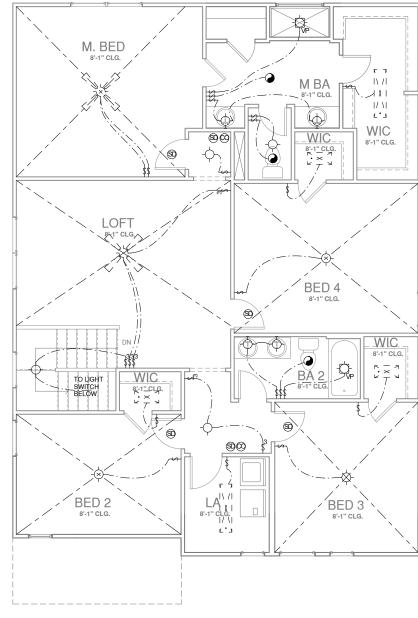
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P _{GFI}	GROUND-FAULT CIRCUIT- INTERRUPTER DUPLEX OUTLET	1	RECESSED INCANDESCENT LIGHT FIXTURE
P	HALF-SWITCHED DUPLEX OUTLET	4	(VP) = VAPOR PROOF
₽ 220V	220 VOLT OUTLET		EXHAUST FAN (VENT TO EXTERIOR)
3	REINFORCED JUNCTION BOX	-	EXHAUST FAN/LIGHT COMBINATION (VENT TO EXTERIOR)
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\$4	FOUR-WAY SWITCH		TECH HUB SYSTEM
СН	CHIMES		CEILING FAN
Ŧ	PUSHBUTTON SWITCH		(PROVIDE ADEQUATE SUPPORT)
SD	110V SMOKE DETECTOR W/ BATTERY BACKUP	54	CEILING FAN WITH INCANDESCENT LIGHT FIXTURE
@	CO2 DETECTOR		(PROVIDE ADEQUATE SUPPORT)
T	THERMOSTAT		GAS SUPPLY WITH VALVE
PH	TELEPHONE	1.~	
TV	TELEVISION	HB	HOSE BIBB
8	ELECTRIC METER	-cw	,1/4" WATER STUB OUT
-	ELECTRIC PANEL		•
—	DISCONNECT SWITCH	K I	WALL SCONCE



OPT. MASTER BATH 1 2) 1/4" = 1'-0" AT 22"X34" LAYOUT 1/8"= 1'-0" AT 11" X 17" LAYOUT



SECOND FLOOR ELEV '1'



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Plan 4 SHEET TITLE:

SECOND **FLOOR UTILITY PLAN**

PRINT DATE:

12.16.16

SHEET NO: **E2.0**