ABBREVIATIONS	INDEX
ABV ARCONDITIONING AD. AREA DRAIN AD. AREA DRAIN AD. AREA DRAIN AD. AAUSTORY ALT ALTERNATE LAW AUMTORY ALT ALTERNATE BE ALTERNATE BE AUTORY BE AUTORY BE AUTORY BE AUTORY BE AUTORY BE AUTORY BE AUTORY BE AUTORY BE AUTORY BE AUTORY AUTORY ALTERNATE BE AUTORY A	A0.1.1       SLAB ELEV '1'         A0.1.2       SLAB ELEV '2'         A0.1.3       SLAB ELEV '2'         A0.1.4       SLAB ELEV '4'         A0.2.1       STEM WALL ELEV '1'         A0.2.2       STEM WALL ELEV '1'         A0.2.3       STEM WALL ELEV '1'         A0.2.4       STEM WALL ELEV '1'         A0.3.1       CRAWL SPACE ELEV '1'         A0.3.2       CRAWL SPACE ELEV '1'         A0.3.3       CRAWL SPACE ELEV '1'         A0.3.4       CRAWL SPACE ELEV '1'         A0.3.5       CRAWL SPACE ELEV '1'         A1.1       FLOOR PLANS ELEV '1'         A1.2       FLOOR PLANS ELEV '1'         A1.3       FLOOR PLANS ELEV '2'         A1.3       FLOOR PLANS ELEV '1'         A1.5       FLOOR PLANS ELEV '1'         A1.5       FLOOR PLANS ELEV '1'         A1.5       FLOOR PLAN S'1'         A5.1       ELEVATIONS '1'         A5.1       ELEVATIONS '1'         A5.2       ELEVATIONS '2'         A5.3       ELEVATIONS '2'         A5.3       ELEVATIONS '2'         A5.3       ELEVATIONS '2'         A5.3       ELEVATIONS '3'         A5.4       ELEVATIONS '4'
BUILDING CODE COMPLIANCE / PROJECT INFORMATION	
ALL CONSTRUCTION TO COMPLY WITH LOCAL CODES AND ORDINANCES CURRENTLY IN USE WITH THE LOCAL JURISDICTION. APPLICABLE CODES: FOLLOW ALL APPLICABLE STATE AND LOCAL CODES. 2012 NORTH CAROLINA STATE SUPPLEMENTS AND AMENDMENTS	ALL CONSULTANT DRAWINGS ACCOMPANYING THESE GMD DESIGN GROUP DRAWINGS HAVE NOT BEE PREPARED BY OR UNDER THE DIRECTION OF GMD DESIGN GROUP, INC. GMD DESIGN GROUP INC. THEREFORE ASSUMES NO LIABILITY FOR THE COMPLETENESS OR CORRECTNESS OF THESE DRAWINGS.
CONTRACTOR AND BUILDER SHALL REVIEW ENTIRE PLAN TO VERIFY CONFORMANCE WITH ALL CURRENT APPLICABLE CODES IN EFFECT AT TIME OF CONSTRUCTION. BY USING THESE DRAWINGS FOR CONSTRUCTION IT IS UNDERSTOOD THAT CONFORMACE WITH ALL APPLICABLE CODES IS THE RESPONSIBILITY OF THE BUILDER AND CONTRACTOR.	
PRODUCT: SINGLE FAMILY RESIDENCE / 3 STORY TOWNHOMES	
OCCUPANCY CLASSIFICATION RESIDENTIAL R-3	

THESE DOCUMENTS ARE THE PROPERTY OF THE DESIGNER AND SHALL NOT BE COPIED, DUPLICATED, ALTERED, MODIFIED OR REVISED IN ANY WAY WITHOUT THE EXPRESSED WRITTEN APPROVAL OF THE DESIGNER. CONTRACTOR SHALL VERIFY ALL CONDITIONS AND DIMENSIONS AT THE SITE AND

ALL INCONSISTENCES SHALL BE BROUGHT TO THE ATTENTION OF THE DEVELOPER AND THE DESIGNER BEFORE PROCEEDING WITH WORK.

ANY ERRORS OR OMISSIONS FOUND IN THESE DRAWINGS SHALL BE BROUGHT TO DEVELOPERS AND DESIGNERS ATTENTION IMMEDIATELY. DO NOT SCALE DRAWINGS, WRITTEN DIMENSIONS TAKE PRECEDENCE OVER SCALED

DIMENSIONS. ALL DIMENSIONS ARE TO FACE OF STUD OR TO FACE OF FRAMING UNLESS

OTHERWISE NOTED. ALL TRUSS DRAWINGS TO BE REVIEWED AND APPROVED BY THE STRUCTURAL ENGINEER PRIOR TO ISSUANCE OF BUILDING PERMIT.

ALL OR EQUAL SUBSTITUTIONS MUST BE SUBMITTED TO AND APPROVED BY CITY BUILDING OFFICIAL PRIOR TO INSTALLATION.

ALL ANGLED PARTITIONS ARE 45 DEGREES UNLESS OTHERWISE NOTED. PROVIDE FIREBLOCKING. (PER LOCAL CODES.)

ALL ELECTRICAL AND MECHANICAL EQUIPMENT AND METERS ARE SUBJECT TO RELOCATION DUE TO FIELD CONDITIONS, CONTRACTOR TO VERIFY.

PROVIDE BLOCKING AND/OR BACKING AT ALL TOWEL BAR, TOWEL BING AND/OR TOILET PAPER HOLDER LOCATIONS, AS SHOWN PER PLAN, TYPICAL AT ALL BATHROOMS AND POWDER ROOMS. VERIFY LOCATIONS AT FRAINING WALK. ELASTOMERIC SHEET WATERPROOFING: FURNISH AND INSTALL ALL WATERPROOFING COMPLETE A JUL, SELFADERING MEMBRANE OF RUBBERIZED ASPHALT INTEGRALLY BONDED TO POLYETHYLENE SHEETING, OR EQUAL. INSTALL FER MANUFACTURES AND LATADA ASSOCIATIONS PRINTED INSTALLATION INSTRUCTIONS, 6" MINIMUM LAP AT ALL ADJACENT WALL SURFACES.

TO THE BEST OF THE DESIGNER'S KNOWLEDGE THESE DOCUMENTS ARE IN CONFORMANCE WITH THE REQUIREMENTS OF THE BUILDING AUTHORITIES HAVING JURISDICTION OVER THIS TYPE OF CONSTRUCTION AND OCCUPANCY.

JUNIDED TOR OVER THIS THE OF CONSTRUCTION AND OCCUPANCT. SHOP DRAWING REVIEW AND DISTRIBUSTION, ALONG WITH PRODUCT SUBMITTALS, RECOUSTED IN THE CONSTRUCTION DOCUMENTS, SHALL BE THE SOLE RESPONSIBILITY OF THE GENERAL CONTRACTOR, UNLESS DIRECTED OTHERWISE

UNDER A SEPARATE AGREEMENT. DEVIATIONS FROM THESE DOCUMENTS IN THE CONSTRUCTION PHASE SHALL BE REVIEWED BY THE DESIGNER AND THE OWNER PRIOR TO THE START OF WORK IN QUESTION, ANY DEVIATIONS FROM THESE DOCUMENTS WITHOUT PRIOR REVIEW, SHALL BE THE SOLE RESPONSIBILITY OF THE GENERAL CONTRACTOR.

THE GENERAL CONTRACTOR SHALL BE RESPONSIBLE FOR ALL WORK AND MATERIALS REPRESENTED ON THESE DOCUMENTS INCLUDING THE WORK AND MATERIALS FURNISHED BY SUBCONTRACTORS AND VENDORS. THE OWNER SHALL FURNISH ANY AND ALL REPORTS RECEIVED FROM THE GEOTECHNICAL ENGINEER (SOLIS REPORT). ON THE STUDY OF THE PROPOSED SITE, TO THE DESIGNER, STRUCTURAL ENGINEER, AND GENERAL CONTRACTOR. IN THE EVENT THE GEOTECHNICAL REPORTS DO NOT EXIST. THE SOLIS CONDITION SHALL BE ASSUMED TO BE A MINIMUM DESION SOLI PRESSURE STATED BY THE STRUCTURAL ENGINEER OF RECORD FOR THE PURPOSE OF STRUCTURAL DESIGN. GENERAL CONTRACTOR SHALL ASSURE THE SOLI CONDITIONS MEET OR EXCEED THE CRITERIA.

ALL WORK PERFORMED BY THE GENERAL CONTRACTOR SHALL COMPLY AND CONFORM WITH LOCAL AND STATE BUILDING CODES, ORDINANCES AND REGULATIONS, ALONG WITH ALL OTHER AUTHORITIES HAVING SURSIDICTION. THE GENERAL CONTRACTOR IS RESPONSIBLE TO BE AWARE OF THESE REQUIREMENTS AND GOVERNING REGULATIONS.


PROVIDE AN APPROVED WASHER DRAIN PAN AT SECOND FLOOR ONLY THAT DRAINS TO EXTERIOR.

WINDOW SUPPLIER TO VERIFY AT LEAST ONE WINDOW IN ALL BEDROOMS TO HAVE A CLEAR OPENABLE AREA OF 4.0 SQ FT. THE MINIMUM HET CLEAR OPENING HEIGHT SHALL BE 22" AND THE MINIMUM NET CLEAR OPENING WIDTH SHALL BE 20", CLEATING TOTAL AREA OF NOT LESS THAN 5.0 SQ FT IN THE CASE OF A GROUND WINDOW AND NOT LESS THAN 5.7 SQ FT IN THE CASE OF AN UPPER STORY WINDOW (PER NGC SECTION BRID 1.1)

AND SO GH THE THE RECORD ON THE AND TH

PROVIDE STAIR HANDRAILS AND GUARDRAILS PER LOCAL CODES.

# SAVANNAH PLAN 2238

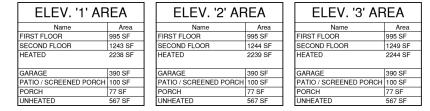

# BUILDER SET:

THE SCOPE OF THIS SET OF PLANS IS TO PROVIDE A "BUILDER'S SET" OF CONSTRUCTION DOCUMENTS AND GENERAL NOTES HEREINAFTER REFERRED TO AS "PLANS". THIS SET OF PLANS IS SUFFICIENT TO OBTINA BUILDING PENTH: HOWEVER, ALL MATERIALS AND METHODS OF CONSTRUCTION NECESSARY TO COMPLETE THE PROJECT ARE NOT NECESSARILY DESCRIBED. THE PLANS DELINATE AND DESCRIBE ONLY LOCATIONS, DIMENSIONS, TYPES OF MATERIALS, AND GENERAL METHODS OF ASSEMBLING OR FASTENING. THEY ARE NOT INTERNED TO SECIFY PARTICULAR PRODUCTS OR OTHER METHODS OF ANY SPECIFIC MATERIALS, PRODUCT OF METHOD. THE IMPLEMENTATION OF THE PLANS RECURRES A CLIENT/ CONTRACTOR THOROUGHLY KNOWLEDGEABLE WITH THE APPLICABLE BUILDING CODES AND METHODS OF CONSTRUCTION SPECIFY DATICULATOR NOT THE PLANS RECURRES A CLIENT/ CONTRACTOR THOROUGHLY KNOWLEDGEABLE WITH THE APPLICABLE BUILDING CODES

AND MILETINDED OF UND THOST MOST AND QUALITY: FROVIDE WORK OF THE SPECIFIC QUALITY: WHERE QUALITY LEVEL IS NOT INDICATED, PROVIDE WORK OF QUALITY CUSTOMARY IN SIMILAR TYPES OF WORK. WHERE THE PLANS AND SPECIFICATIONS, CODES, LAWS, REQULATIONS, MANUFACTURES RECOMMENDATIONS OF DUSTRY STANDARDS REQUIRE WORK OF HIGHER QUALITY OR PERFORMANCE, PROVIDE WORK COMPLYING WITH THOSE REQUIREMENTS AND QUALITY. WHERE TWO OF MORE QUALITY PROVISIONS OF THOSE REQUIREMENTS AND QUALITY. WHERE TWO OF MORE QUALITY PROVISIONS OF THOSE REQUIREMENTS AND CUALITY. WHERE TWO OF MORE QUALITY PROVISIONS OF THOSE REQUIREMENTS AND FLICT WITH THE MOST STRINGENT REQUIREMENT; WHERE REQUIREMENTS AND STRINGENT, OBTAIN CLARIFICATION FROM THE ARCHITECT BEFORE PROCEEDING.



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PROFESSIONAL SEAL

ELEV. '4' AREA	
Name	Area
FIRST FLOOR	995 SF
SECOND FLOOR	1262 SF
HEATED	2257 SF
GARAGE	390 SF
PATIO / SCREENED PORCH	100 SF
PORCH	77 SF
UNHEATED	567 SF

#### PROJECT TITLE:

QUACKENBUSH HOMES LLC 9220 FAIRBANKS DR SUITE 240 RALEIGH, NC 27613 919-741-7993



CLIENTS NAME:

QUACKENBUSH HOMES

PROJECT NO:

SHEET TITLE:

#### COVER SHEET

- - - ----

PRINT DATE:

SHEET NO

11.09.16

T-1

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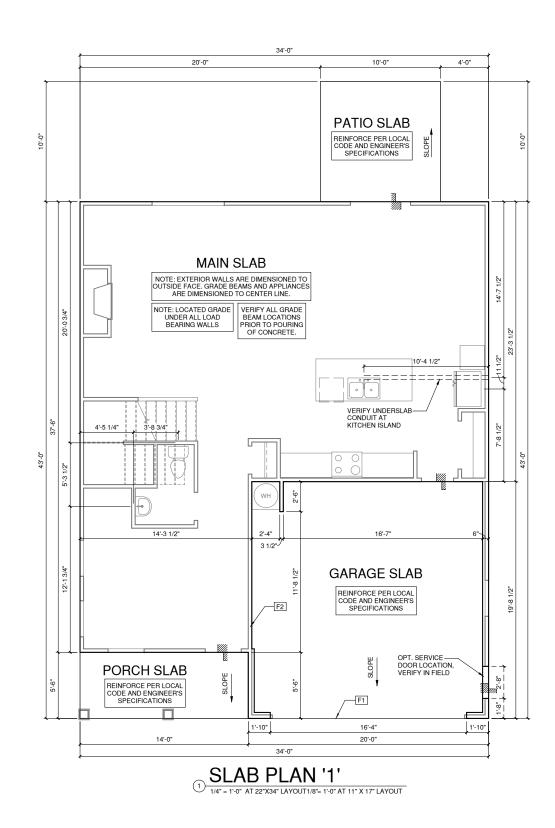
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# REFER TO STRUCTURAL DRAWINGS FOR ALL FOUNDATION DIMENSIONS

FOUNDATION KEYNOTE LEGEND





11.09.16

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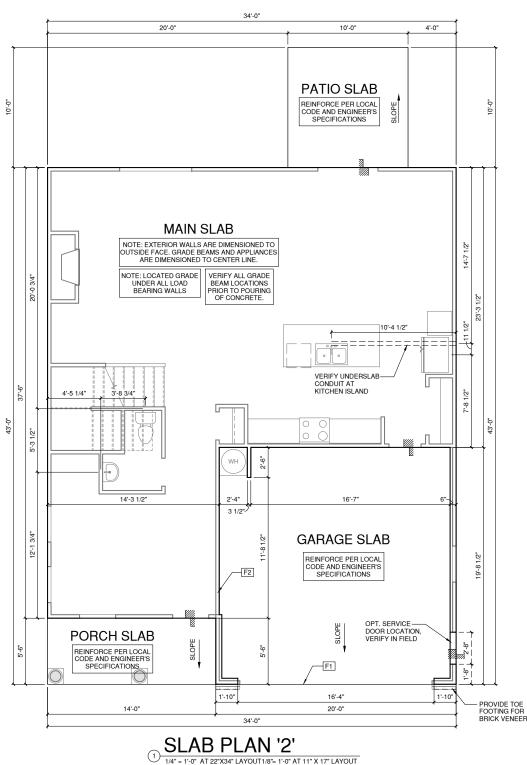
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FOUNDATION KEYNOTE LEGEND

LINE OF SLAB ABOVE LINE OF FRAMED WALL ABOVE



1/4" = 1'-0" AT 22"X34" LAYOUT1/8"= 1'-0" AT 11" X 17" LAYOUT



CONSTRUCTION SET CLIENTS NAME: QUACKENBUSH HOMES

SHEET TITLE:

PRINT DATE:

SHEET NO:

PROJECT NO:

SLAB ELEV '2'

11.09.16

A0.1.2

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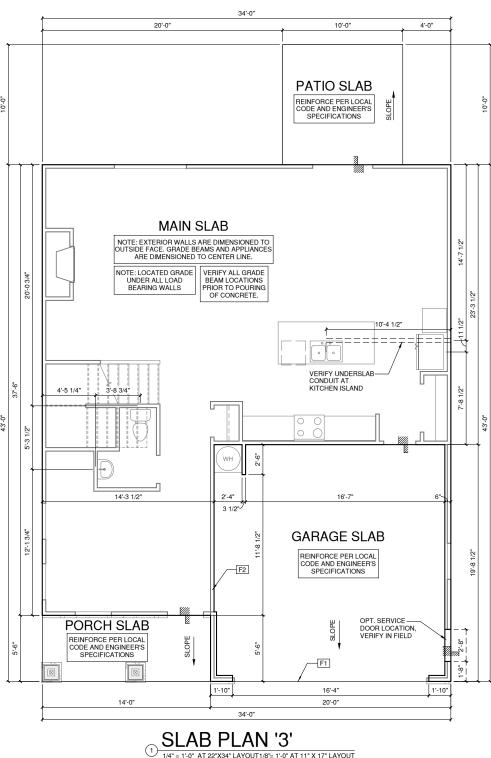
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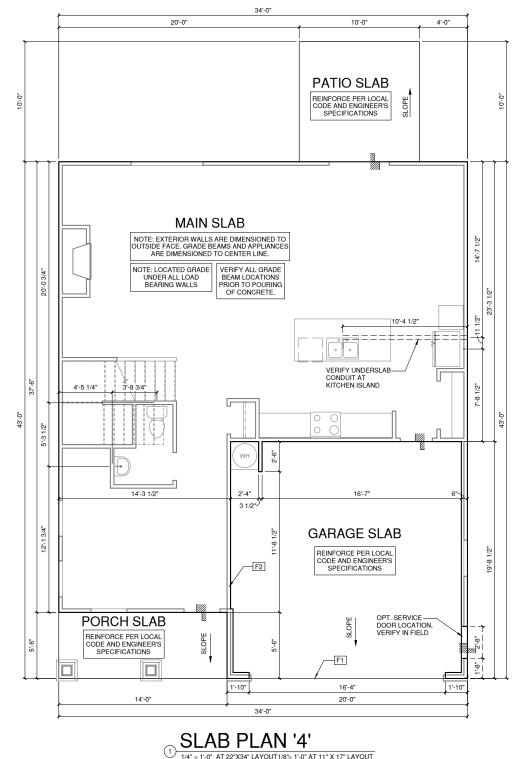
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A0.1.4

SHEET NO:

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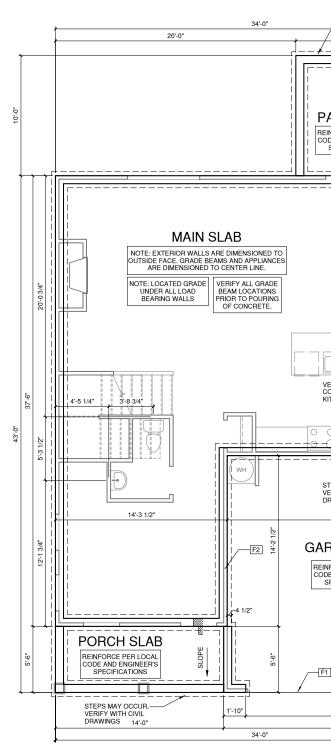
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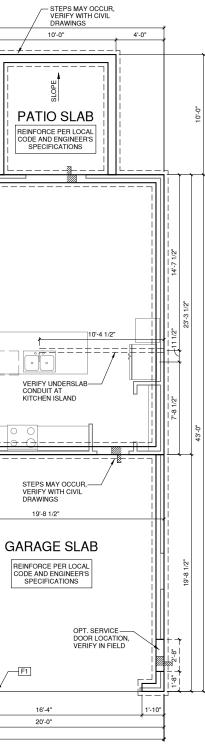
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11.09.16

A0.2.1

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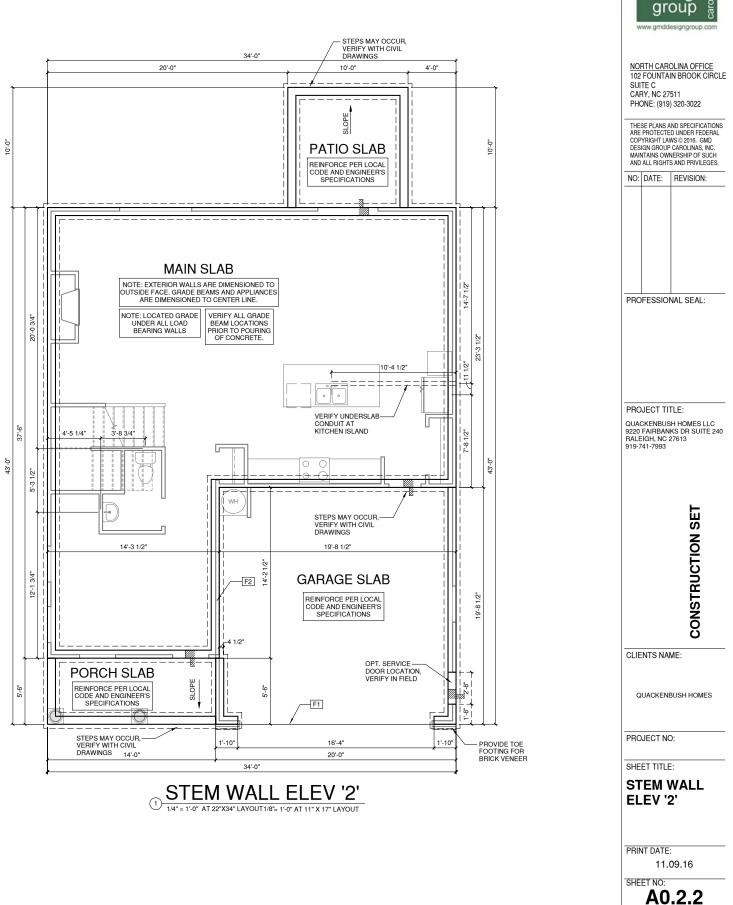
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# **REFER TO STRUCTURAL** DRAWINGS FOR ALL FOUNDATION DIMENSIONS

FOUNDATION KEYNOTE LEGEND

LINE OF SLAB ABOVE LINE OF FRAMED WALL ABOVE



desigr

IRRIGATION SYSTEM SHALL BE DESIGNED TO PREVENT THE SATURATION OF SOIL ADJACENT TO BUILDING. THIS PERIMETER DIMENSION PLAN IS FOR DIMENSIONAL INFORMATION ONLY.

SLOPE ALL STOOPS AND HARDSCAPE MATERIAL AWAY FROM BUILDING - TYPICAL

SLOPE GARAGE FLOOR 1/8" PER FOOT TO GARAGE DOOR OPENING.

VERIFY CURB CUT BLOCKOUT WITH GARAGE DOOR MANUFACTURER.

REFER TO CIVIL DRAWINGS FOR FINISH SURFACE ELEVATIONS.

FINISH GRADE SHALL PROVIDE POSITIVE DRAINAGE AWAY FROM BUILDING. REFER TO SOILS REPORT FOR ANY SPECIFIC REQUIREMENTS.

REFER TO STRUCTURAL DRAWINGS FOR HOLDDOWNS, FOOTING DETAILS, CURB THICKNESS, AND INFORMATION NOT SHOWN ON THIS PLAN.

PLUMBING FIXTURES, VENT LOCATIONS, ETC. ARE APPROXIMATE. CONTRACTOR TO VERIFY COUNT AND LOCATION

VERIFY THE SUPPLY FOR SEPARATE CONDUITS TO ANY ISLAND FOR GAS, WATER OR ELECTRIC. VERIEVALL DOOR THRESHOLD HEIGHTS TO HARD SUBFACES

8 1/4" MAX AT INSWING DOORS. (PER NCRC SECTION R311.3.1.)

TYP STOOP AT INSWING/SLIDER DOORS: 36" DEEP BY THE WIDTH OF THE DOOR SERVED, MINIMUM. (PER NCRC SECTION R311.3.) PROVIDE A SLIP-RESISTANT FINISH.

FOR THE USE OF EXPOSED GAS WATER HEATERS IN THE GARAGE, PROTECT THE WATER HEATER WITH 3" DIA CONCRETE FILLED STEEL PIPE EMBEDDED INTO CONCRETE FOOTING.


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FOUNDATION KEYNOTE LEGEND

LINE OF SLAB ABOVE LINE OF FRAMED WALL ABOVE



STEM WALL ELEV '3' 1/4" = 1'-0" AT 22"X34" LAYOUT 1/8"= 1'-0" AT 11" X 17" LAYOUT



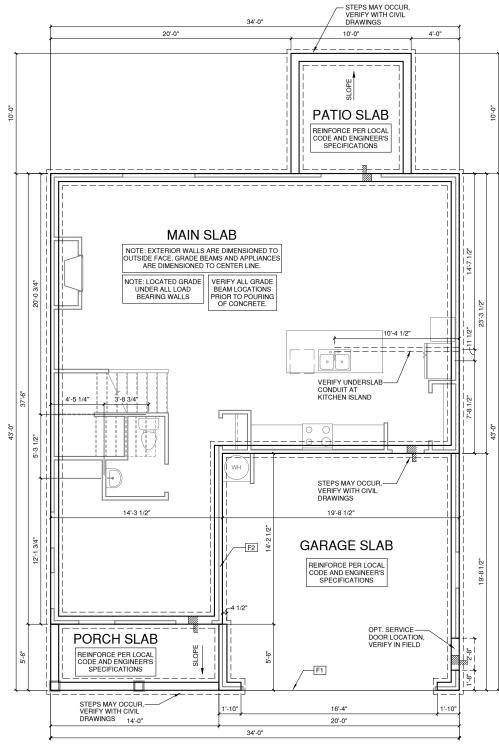

PRINT DATE:

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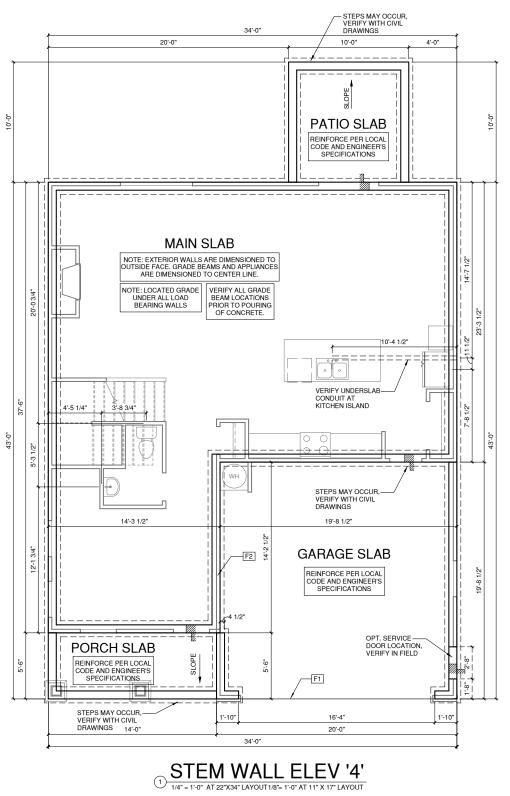
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FOUNDATION KEYNOTE LEGEND

LINE OF SLAB ABOVE LINE OF FRAMED WALL ABOVE





NORTH CAROLINA OFFICE

SUITE C CARY, NC 27511
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PROJECT TITLE:
QUACKENBUSH HOMES LLC 9220 FAIRBANKS DR SUITE 240 RALEIGH, NC 27613 919-741-7993
SET
CONSTRUCTION
CONST
CLIENTS NAME:
CLIENTS NAME: QUACKENBUSH HOMES PROJECT NO:
CLIENTS NAME:

SHEET NO:

A0.2.4

CRAWL SPACE	NOTES FOR NORTH CAROLINA:	
-REFER TO STRUCTURAL DRAW	VINGS FOR INFORMATION NOT SHOWN ON THIS PLAN.	
-FOR ADDITIONAL NOTES SEE G	ENERAL NOTES ON TITLE SHEET AND DETAILS.	
-PROVIDE FIREBLOCKING. (PER	NCRC SECTION R602.8)	
-ALL ELECTRICAL AND MECHANI TO VERIFY.	ICAL EQUIPMENT AND METERS ARE SUBJECT TO RELOCATION DUE TO FIEL	LD CONDITIONS, CONTRACTOR
-VERIFY ALL DOOR THRESHOLD 8 1/4" MAX AT INSWING DOORS.	) HEIGHTS TO HARD S URFACES. . (PER NCRC SECTION R311.3.1)	
-SLOPE ALL STOOPS AND HARD	SCAPE MATERIAL AWAY FROM BUILDING - TYPICAL.	
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-VERIFY CURB CUT BLOCKOUT V	WITH GARAGE DOOR MANUFACTURER.	
-REFER TO CIVIL DRAWINGS FOR	R FINISH SURFACE ELEVATIONS.	
	R DOORS: 36" DEEP BY THE WIDTH OF THE DOOR SERVED, 8 R311.3) PROVIDE A SLIP-RESISTANT FINISH.	
	PLIED TO FRAMING PER PRODUCT SPECIFICATIONS. (PROVIDE CHEMICAL T CCORDING TO THE STANDARDS OF THE NCDEPT. OF AGRICULTURE.)	REATMENT FOR PROTECTION
-AT VENTED CRAWL SPACE: APPLY AN APPROVED VAPOR RE PER NCRC SECTION 408.2	ETARDER OR EQUIVALENT, 6 MIL POLY-VINYL, GROUND COVER OVER FINIS	SH GRADE OR CRAWL SPACE
-PROVIDE VENTS SPACED AROL	JND PERIMETER TO PROMOTE CROSS VENTILATION AT A RATE OF 1 SF VEI	NT FOR EVERY 1500 SF OF

CRAVE FLOOR AREA. ONE VENT MUST BE LOCATED WITHIN 3:0" OF EACH CORNER OF THE BUILDING AND LOCATED TO ALLOW FOR CROSS VENTILATION. (PER NCRC SECTION R408.1.1 EXCEPTION.)


-PROVIDE AN ACCESS OPENING, MINIMUM SIZE OF 18"X24" FOR CRAWL ACCESS. COORDINATE WITH MECHANICAL CONTRACTOR FOR LARGER SIZE REQUIREMENTS IF MECHANICAL EQUIPMENT IS LOCATED IN CRAWL. (PER NCRC SECTION 408.8)

-WOOD CONTACTING CONCRETE OR MASONRY OR LESS THAN CODE REQUIRED SEPARATION TO GRADE SHALL BE PRESSURE TREATED OR FOUNDATION GRADE REDWOOD. SET ALL EXTERIOR WALL SILLS IN MASTIC.

# **REFER TO STRUCTURAL** DRAWINGS FOR ALL FOUNDATION DIMENSIONS

FOUNDATION KEYNOTE LEGEND

LINE OF SLAB ABOVE LINE OF FRAMED WALL ABOVE

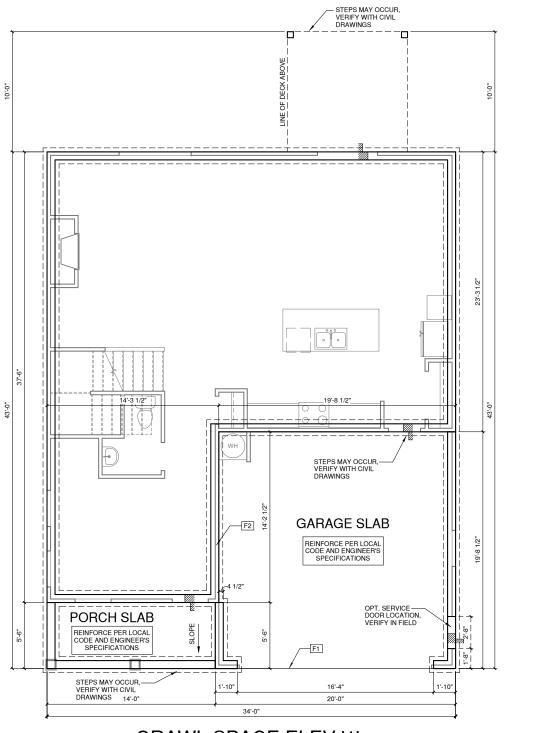

(1) CRAWL SPACE ELEV '1'

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PROFESSIONAL SEAL:

QUACKENBUSH HOMES LLC 9220 FAIRBANKS DR SUITE 240 RALEIGH, NC 27613 919-741-7993

PROJECT NO:

SHEET TITLE:

ELEV '1'

PRINT DATE:

SHEET NO:

QUACKENBUSH HOMES

**CRAWL SPACE** 

11.09.16

A0.3.1

CLIENTS NAME:



PROJECT TITLE:

#### CRAWL SPACE NOTES FOR NORTH CAROLINA: REFER TO STRUCTURAL DRAWINGS FOR INFORMATION NOT SHOWN ON THIS PLAN. FOR ADDITIONAL NOTES SEE GENERAL NOTES ON TITLE SHEET AND DETAILS. PROVIDE FIREBLOCKING. (PER NCRC SECTION R602.8) ALL ELECTRICAL AND MECHANICAL EQUIPMENT AND METERS ARE SUBJECT TO RELOCATION DUE TO FIELD CONDITIONS, CONTRACTOR O VERIF VERIFY ALL DOOR THRESHOLD HEIGHTS TO HARD S URFACES 8 1/4" MAX AT INSWING DOORS. (PER NCRC SECTION R311.3.1) SLOPE ALL STOOPS AND HARDSCAPE MATERIAL AWAY FROM BUILDING - TYPICAL SLOPE GARAGE FLOOR 1/8" PER FOOT TO GARAGE DOOR OPENING.

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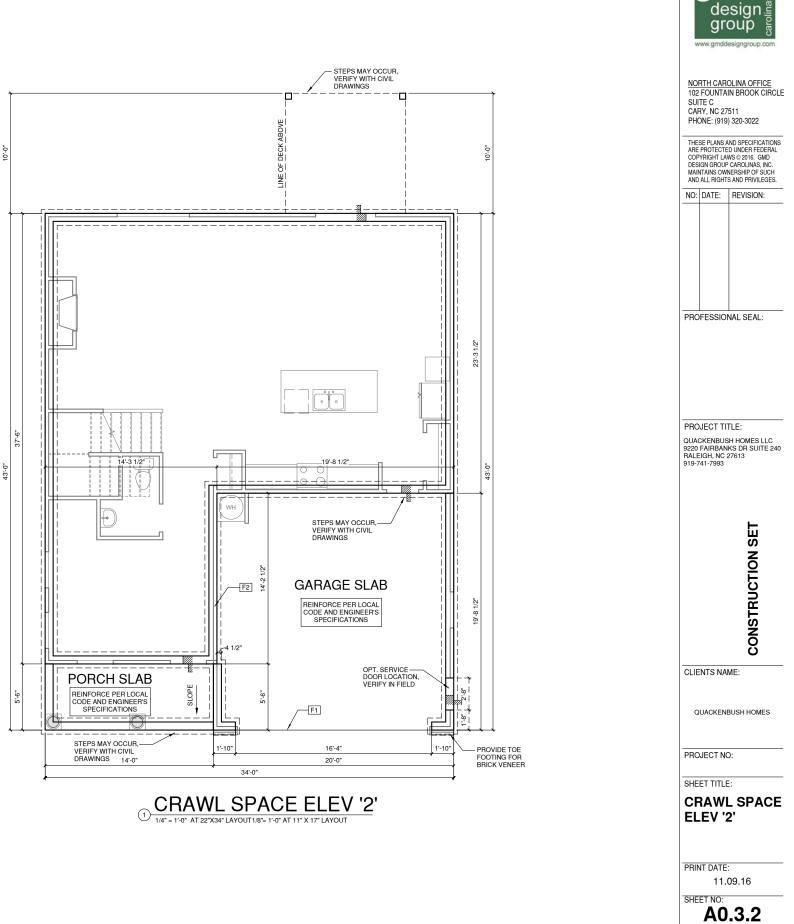
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PROVIDE AN ACCESS OPENING, MINIMUM SIZE OF 18"X24" FOR CRAWL ACCESS, COORDINATE WITH MECHANICAL CONTRACTOR FOR ARGER SIZE REQUIREMENTS IF MECHANICAL EQUIPMENT IS LOCATED IN CRAWL. (PER NCRC SECTION 408.8)

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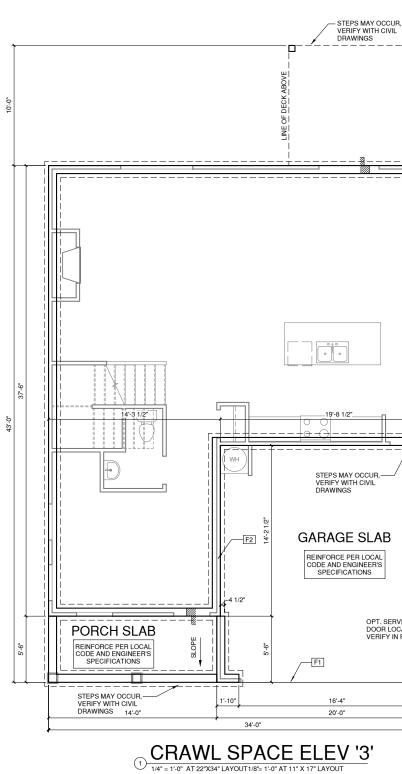
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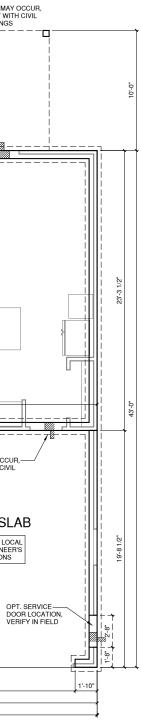
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PROJECT TITLE: QUACKENBUSH HOMES LLC 920 FAIRBANKS OR SUITE 240 RALEIGH, NC 27613 919-741-7993
CONSTRUCTION SET
TRUCTION
CONSTRUCTION
CLIENTS NAME:
CLIENTS NAME:

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### CRAWL SPACE NOTES FOR NORTH CAROLINA:

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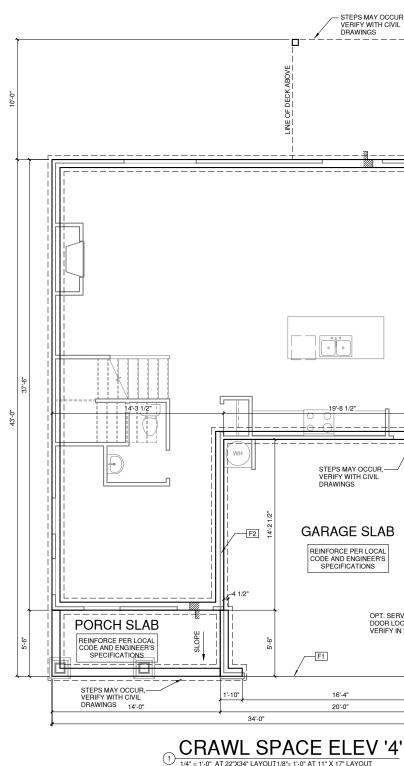
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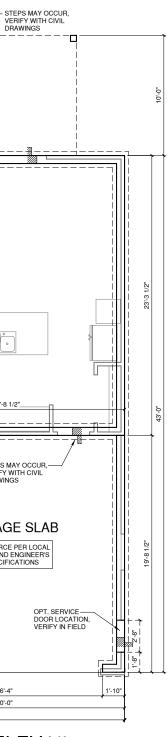
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1/4" = 1'-0" AT 22"X34" LAYOUT 1/8"= 1'-0" AT 11" X 17" LAYOUT





PROFESSIONAL SEAL:

PROJECT TITLE:

QUACKENBUSH HOMES LLC 9220 FAIRBANKS DR SUITE 240 RALEIGH, NC 27613 919-741-7993

CONSTRUCTION SET

**CRAWL SPACE** 

11.09.16

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CLIENTS NAME:

QUACKENBUSH HOMES PROJECT NO:

SHEET TITLE:

ELEV '4'

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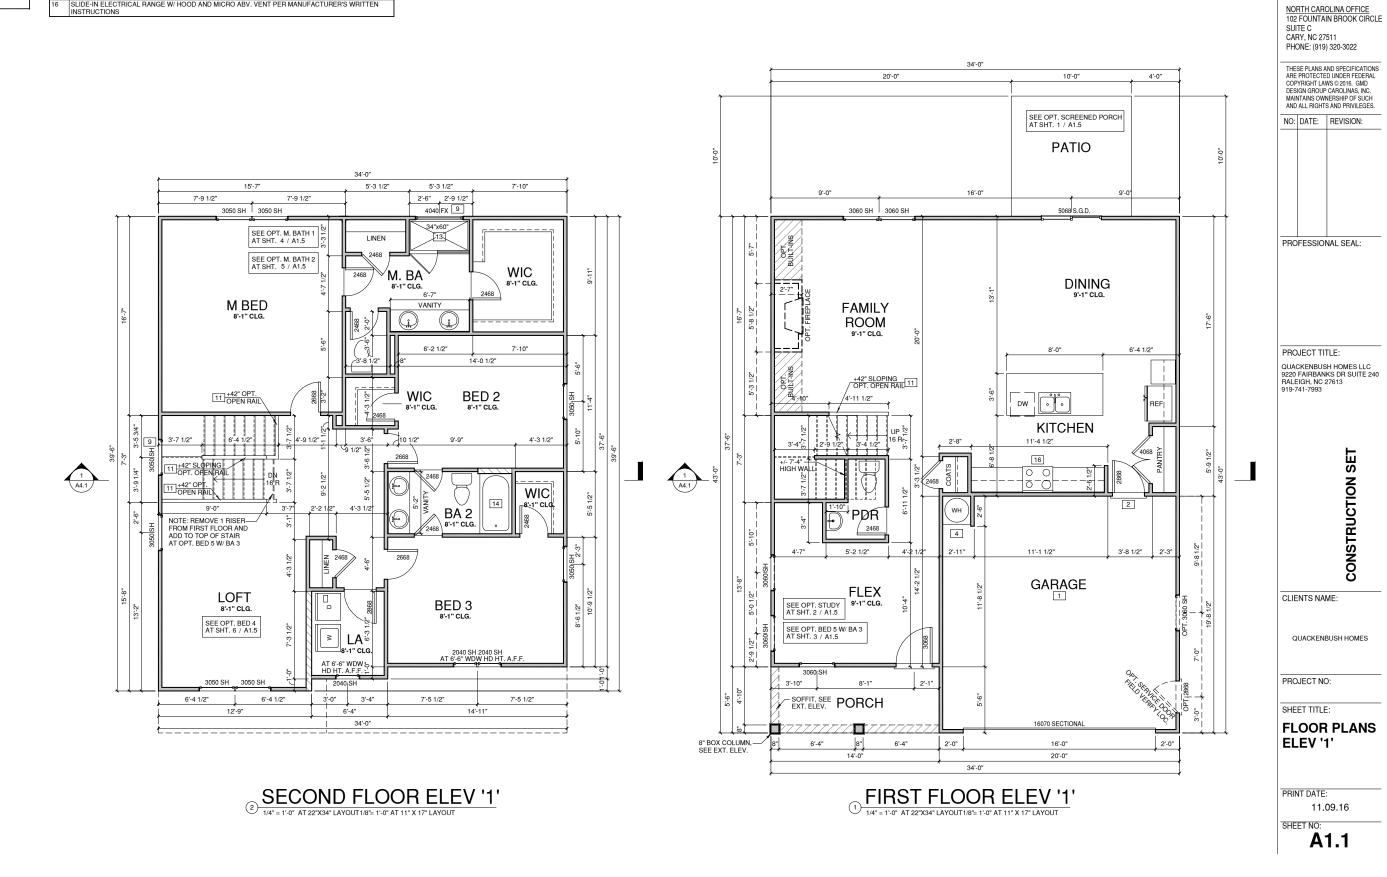
### WALL LEGEND

FULL HEIGHT	
	2X6 WOOD STUD PARTITION
STONE VENEER	DRYWALL OPENING HEIGHT AS NOTED ON PLAN
BRICK VENEER	
STUD WALL BELOW HEIGHT AND STUD SIZE AS N	IOTED

13 14

### FLOOR PLAN KEYNOTE LEGEND

HOUSE TO GARAGE FIRE SEPARATION, GARAGE/HOUSE SEPARATION AT VERTICAL SUFACES SHAL BE PROTECTED WITH ONE (1) LAYER 1/2" GYPSUM BOARD, GARAGE/HOUSE SEPARATION AT HORIZONTAL SURFACES SHALL BE PROTECTED WITH ONE (1) LAYER 5/8" TYPE "X" GYPSUM BOARD
HOUSE TO GARAGE DOOR SEPARATION. PROVIDE 1 3/8" SOLID CORE DOOR OR APPROVED 20 MINUT RATED DOOR
GAS WATER HEATER ON 18" HIGH PLATFORM
TEMPERED SAFETY GLASS
HALF WALL, HEIGHT AS NOTED
SHOWER, TEMPERED GLASS ENCLOSURE
TUB-SHOWER COMBO
ACRYLIC TUB W/ PLATFORM, SIZE AS NOTED
SLIDE-IN ELECTRICAL RANGE W/ HOOD AND MICRO ABV. VENT PER MANUFACTURER'S WRITTEN INSTRUCTIONS





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WALL LEGEND	)
FULL HEIGHT 2X4 WOOD STUD PARTITION STONE VENEER	FULL HEIGHT 2X6 WOOD STUD PARTITION ====== DRYWALL OPENING HEIGHT AS NOTED ON PLAN
BRICK VENEER	

### FLOOR PLAN KEYNOTE LEGEND

23'-10"

39'-0" 37'-6"

13'-8"

1-6

LOFT 8'-1'' CLG.


AT 6'-6" WDW HD HT. A.F.F. 2040 SH

6'-0"


3'-0"

3'-0"

l	HOUSE TO GARAGE FIRE SEPARATION, GARAGE/HOUSE SEPARATION AT VERTICAL SURFACES SHAL BE PROTECTED WITH ONE (1) LAYER 1/2" GYPSUM BOARD, GARAGE/HOUSE SEPARATION AT HORIZONTAL SURFACES SHALL BE PROTECTED WITH ONE (1) LAYER 5/8" TYPE 'X" GYPSUM BOARD
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Ļ	GAS WATER HEATER ON 18" HIGH PLATFORM
)	TEMPERED SAFETY GLASS
1	HALF WALL, HEIGHT AS NOTED
3	SHOWER, TEMPERED GLASS ENCLOSURE
4	TUB-SHOWER COMBO
5	ACRYLIC TUB W/ PLATFORM, SIZE AS NOTED
6	SLIDE-IN ELECTRICAL RANGE W/ HOOD AND MICRO ABV. VENT PER MANUFACTURER'S WRITTEN INSTRUCTIONS

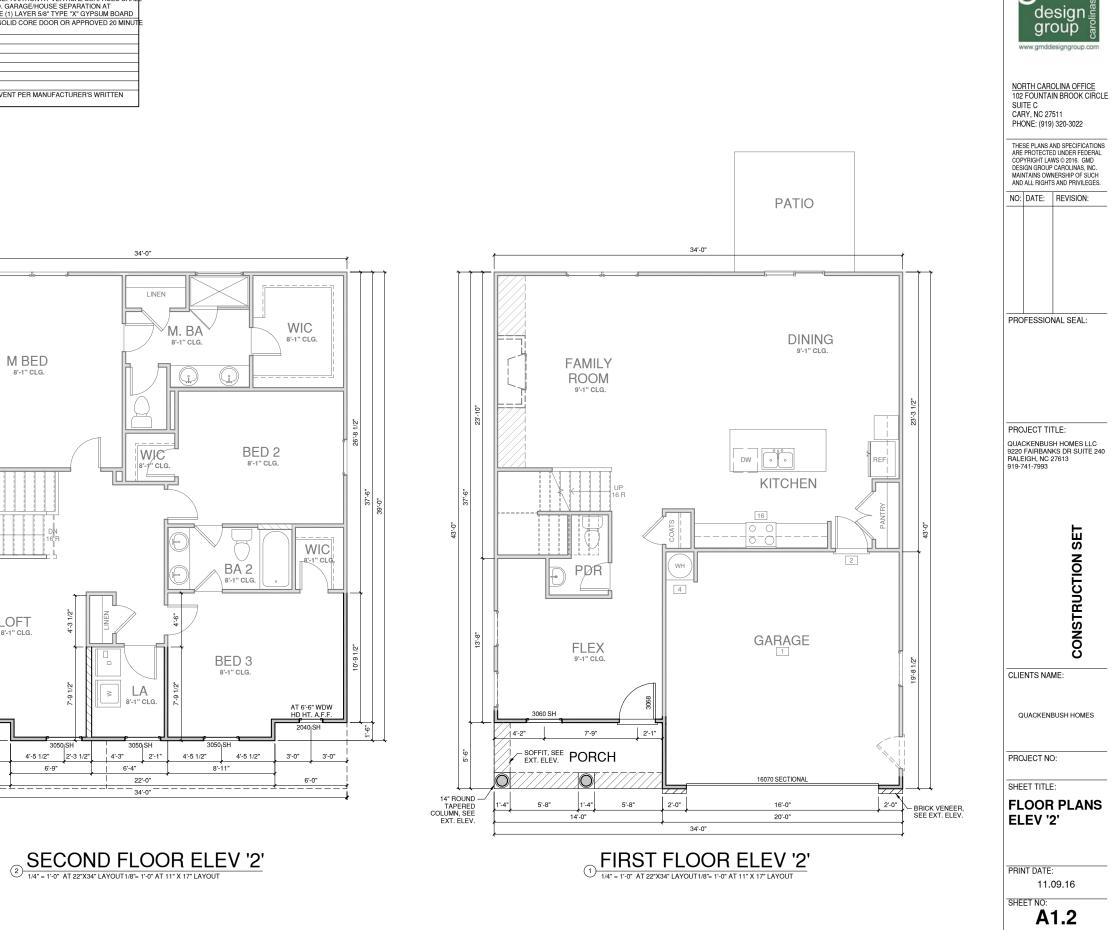




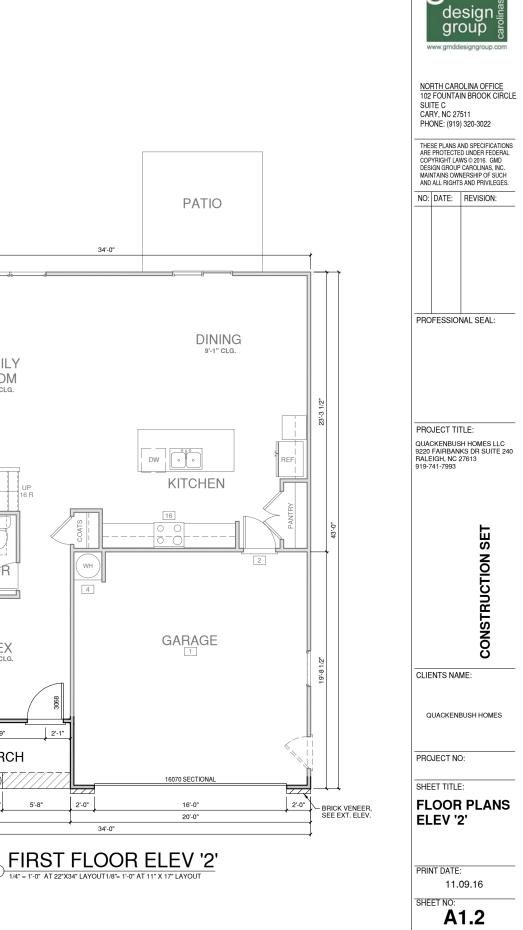


WALL LEGEND	
FULL HEIGHT 2X4 WOOD STUD PARTITION STONE VENEER STONE VENEER BRICK VENEER	TULL HEIGHT 226 WOOD STUD PARTITION TETTET DRYWALL OPENING HEIGHT AS NOTED ON PLAN
STUD WALL BELOW HEIGHT AND STUD SIZE AS N	IOTED


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9	TEMPERED SAFETY GLASS
11	HALF WALL, HEIGHT AS NOTED
13	SHOWER, TEMPERED GLASS ENCLOSURE
14	TUB-SHOWER COMBO
15	ACRYLIC TUB W/ PLATFORM, SIZE AS NOTED
16	SLIDE-IN ELECTRICAL RANGE W/ HOOD AND MICRO ABV. VENT PER MANUFACTURER'S WRITTEN INSTRUCTIONS



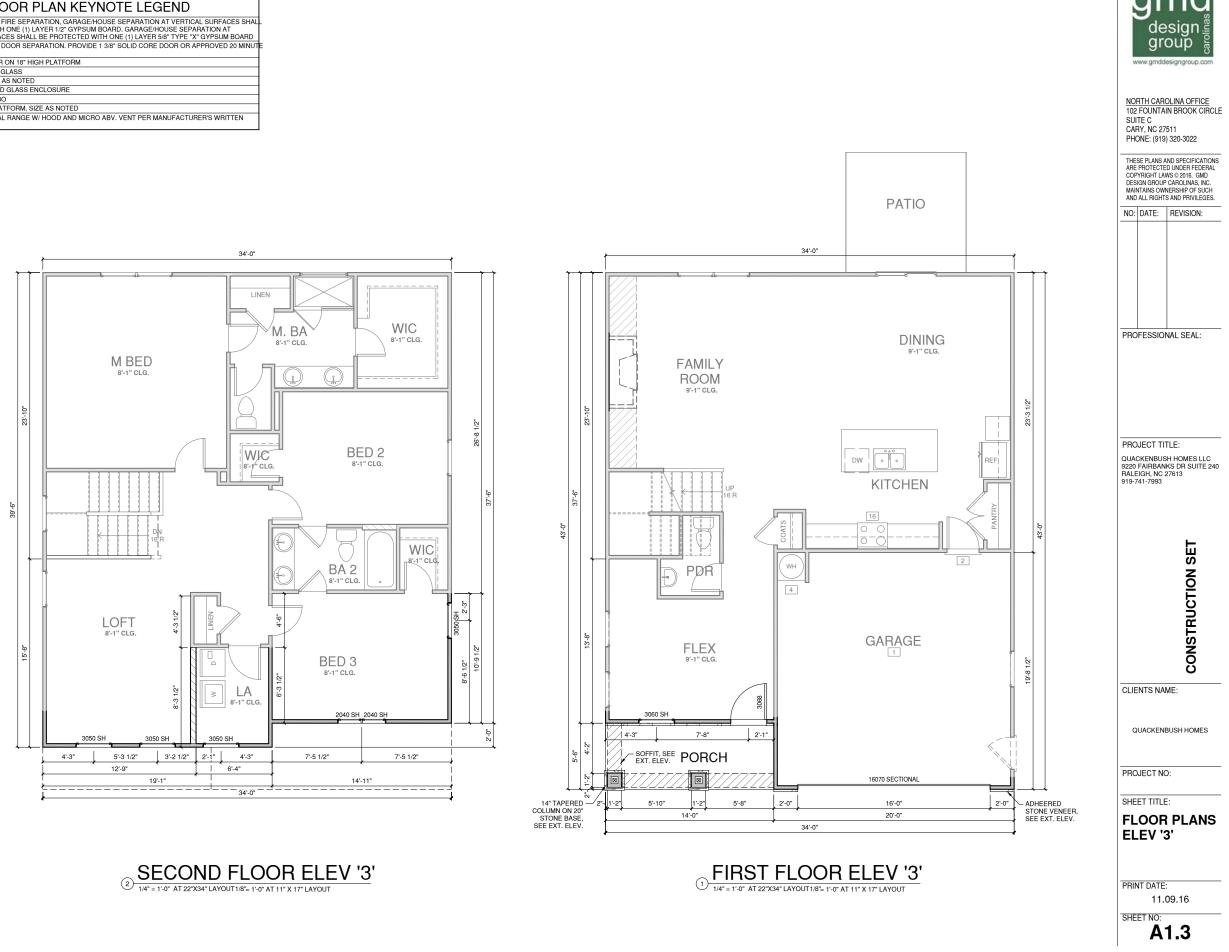




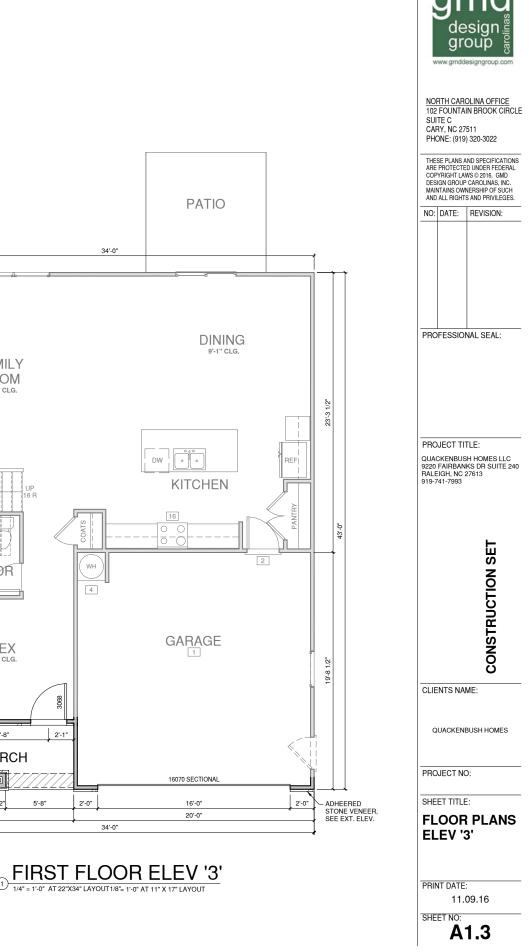
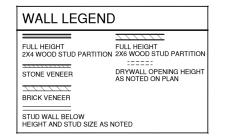
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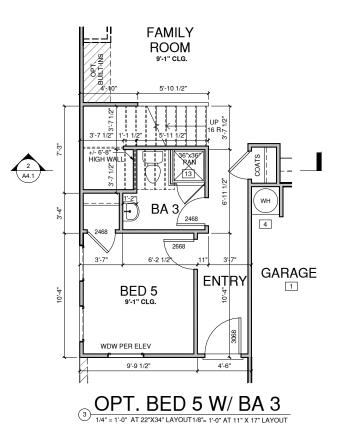



### WALL LEGEND


FULL HEIGHT	FULL HEIGHT 2X6 WOOD STUD PARTITION
2X4 WOOD STUD PARTITION	2X6 WOOD STOD FARTITION
STONE VENEER	DRYWALL OPENING HEIGHT AS NOTED ON PLAN
BRICK VENEER	
STUD WALL BELOW	
HEIGHT AND STUD SIZE AS N	NOTED
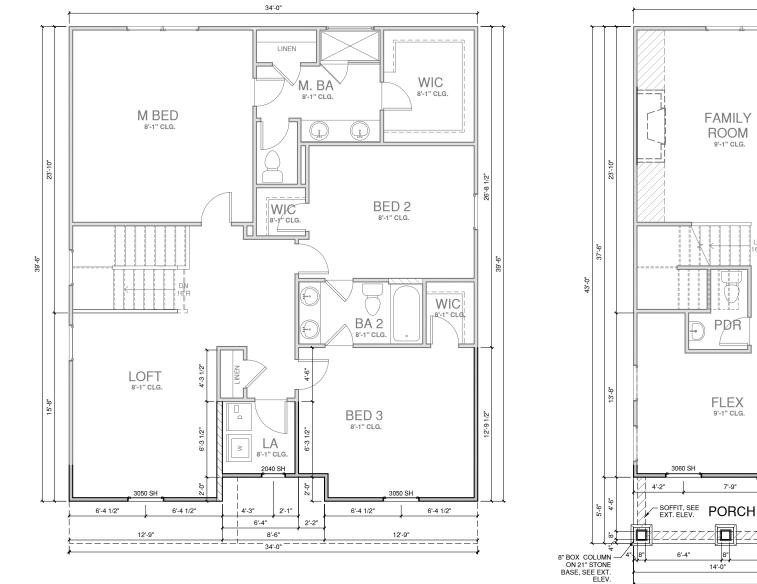
#### FLOOR PLAN KEYNOTE LEGEND

	HOUSE TO GARAGE FIRE SEARATION, GARAGEHOUSE SEPARATION AT VEHICAL SURFACES STALL BE PROTECTED WITH ONE (1) LAYER 1/2" GYPSUM BOARD, GARAGE/HOUSE SEPARATION AT HORIZONTAL SURFACES SHALL BE PROTECTED WITH ONE (1) LAYER 5/8" TYPE "X" GYPSUM BOARD
	HOUSE TO GARAGE DOOR SEPARATION. PROVIDE 1 3/8" SOLID CORE DOOR OR APPROVED 20 MINUT RATED DOOR
	GAS WATER HEATER ON 18" HIGH PLATFORM
	TEMPERED SAFETY GLASS
	HALF WALL, HEIGHT AS NOTED
3	SHOWER, TEMPERED GLASS ENCLOSURE
Ļ	TUB-SHOWER COMBO
5	ACRYLIC TUB W/ PLATFORM, SIZE AS NOTED
6	SLIDE-IN ELECTRICAL RANGE W/ HOOD AND MICRO ABV. VENT PER MANUFACTURER'S WRITTEN INSTRUCTIONS




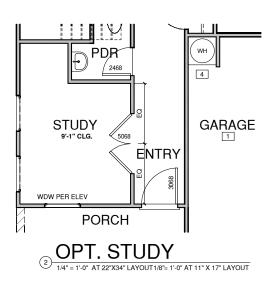


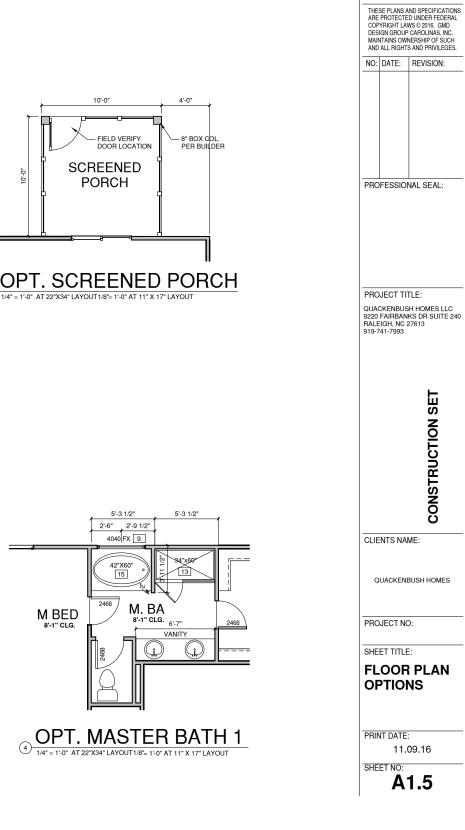



desigr group www.amddesianaroup.co


NORTH CAROLINA OFFICE 102 FOUNTAIN BROOK CIRCLE SUITE C CARY, NC 27511 PHONE: (919) 320-3022

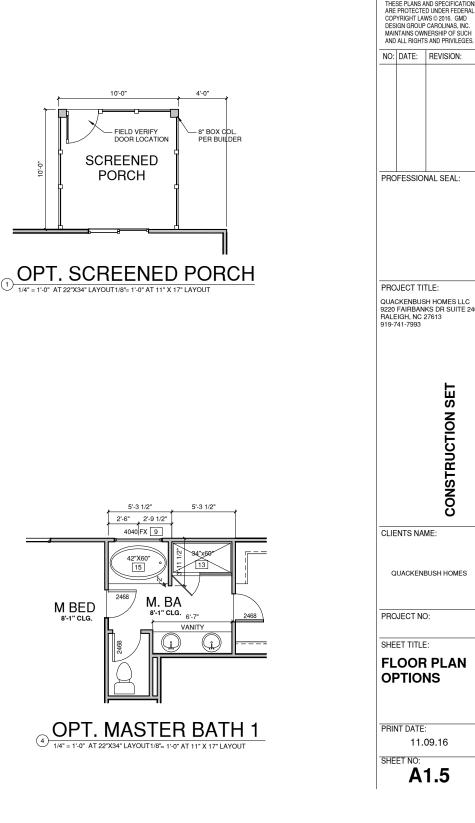

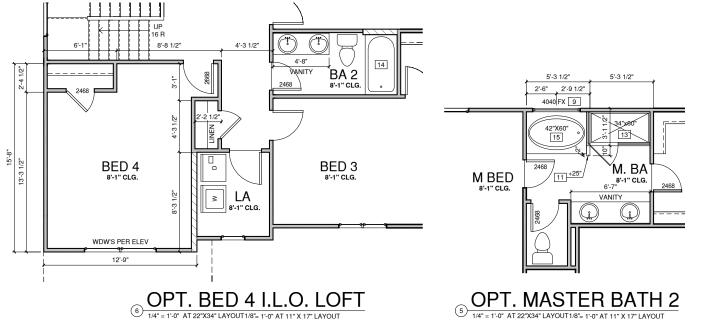

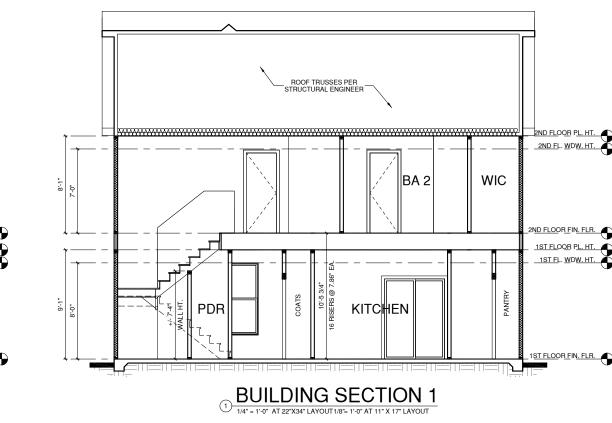

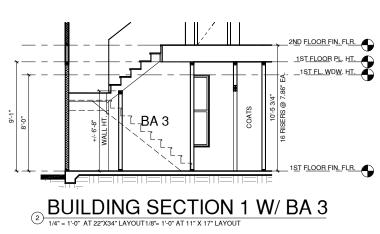

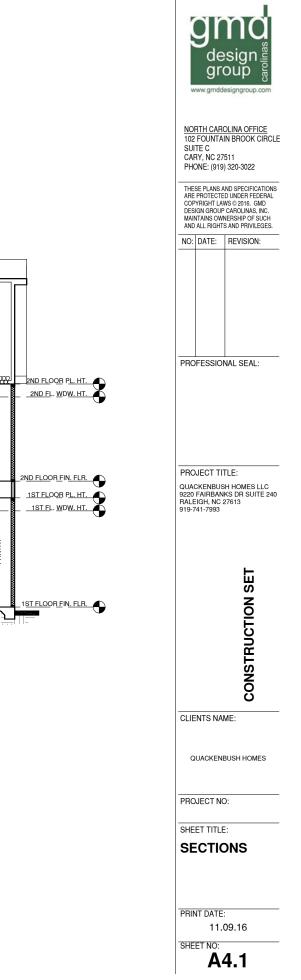



# ALL WINDOWS WHOSE OPENING IS LESS THAN 24" ABOVE THE FINISH FLOOR AND WHOSE OPENING IS GREATER TH-72" ABOVE THE OUTSIDE WALKING SUFFACE MUST HAVE WINDOW OPENING LIMITING DEVICES COMPLYING WITH TH 2012 IRC SECTION R312.2.

#### NOTES:

-GRADE CONDITIONS MAY VARY FOR INDIVIDUAL SITE FROM THAT SHOWN, BUILDER SHALL VERIFY AND COORDINATE PER ACTUAL SITE CONDITIONS

-WINDOW HEAD HEIGHTS: 1ST FLOOR = 8'-0" U.N.O. ON ELEVATIONS 2ND FLOOR = 7'-0" U.N.O. ON ELEVATIONS 3RD FLOOR = 7'-0" U.N.O. ON ELEVATIONS.

ROOFING: PITCHED SHINGLES PER BUILDER.

-WINDOWS: MANUFACTURER PER BUILDER. DIVIDED LITES AS SHOWN ON THE EXTERIOR ELEVATIONS

-ENTRY DOOR: AS SELECTED BY BUILDER

-CHIMNEY AS OCCURS: TOP OF CHIMNEYS TO BE A MINIMUM OF 24" ABOVE ANY ROOF WITHIN 10'-0" OF CHIMNEY.

-ALL EXTERIOR MATERIALS TO BE INSTALLED PER MANUFACTURER'S WRITTEN INSTRUCTIONS.

### **ELEVATION KEYNOTE LEGEND**

- ADHERED STONE VENEER AS SELECTED BY DEVELOPER, HEIGHT AS NOTED MASONRY FULL BRICK AS SELECTED BY DEVELOPER, HEIGHT AS NOTED
- ROWLOCK COURSE
- FYPON OR EQUIVALENT LOUVERED VENT, SIZE AS NOTED CORROSION RESISTANT ROOF TO WALL FLASHING, CODE COMPLIANT FLASHING MUST BE INSTALLED AT ALL ROOF/WALL INTERSECTIONS
- 0 OPT. STANDING SEAM METAL ROOF, INSTALL PER MANUFACTURER'S WRITTEN INSTRUCTIONS
- INSTRUCTIONS E12 FIBER CEMENT SHAKE SIDING PER DEVELOPER W/5/4x4 CORNER TRIM BOARDS E13 FIBER CEMENT LAP SIDING PER DEVELOPER W/5/4x4 CORNER TRIM BOARDS E15 FIBER CEMENT PANEL SIDING W/ 1X3 BATTS AT 12° O.C. (VINYL BOARD AND BATTEN SIDING)

E16 FASCIA


-0-1-

E16

E18

- SIDING) E16 1X FIBER CEMENT TRIM OR EQUAL, U.N.O. SIZE AS NOTED E17 FALSE WOOD/VINYL SHUTTERS, TYPE AS SHOWN, SIZE AS NOTED

B PROVIDE GUARDRAIL PER NCRC SECTION R312

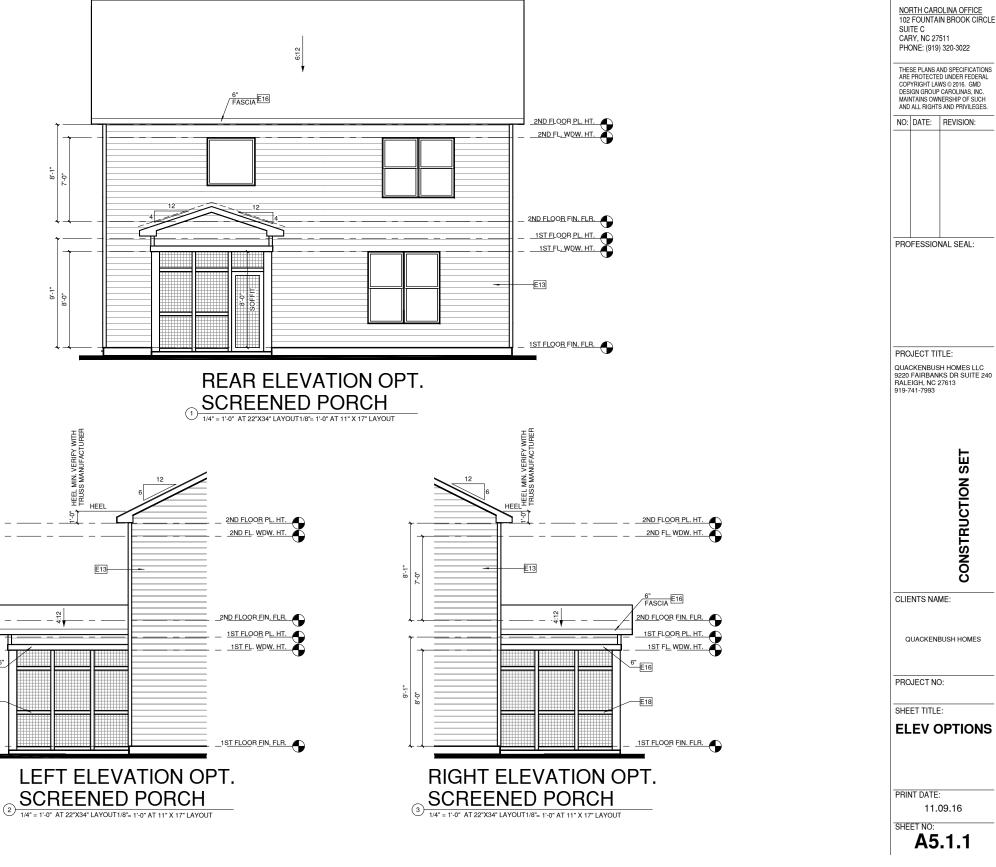



www.amddesianaroup.c

CONSTRUCTION SET

ТҮР. ТАКЕ	ROOF AT OPT SCREENED PORCH
AREA 1	



# 1/150 RATIO:

GENERAL CONTRACTOR SHALL VERIFY THE NET FREE VENTILATION OF THE VENT PRODUCT SELECTED BY OWNER. VERIFY WITH MANUFACTURER OF HIGH AND LOW VENTS TO BE USED FOR MINIMUM CALCULATED VENTS REQUIRED. THE REQUIRED VENTILATION SHALL BE MAINTAINED. PROVIDE INSULATION STOP SUCH THAT INSULATION DOES NOT OBSTRUCT EDEE AID WOVEMENT AS DECUIRED BY THE FREE AIR MOVEMENT AS REQUIRED BY THE BUILDING OFFICIAL.

ALL OVERLAP FRAMED ROOF AREAS SHALL HAVE OPENINGS BETWEEN THE ADJACENT ATTICS IN THE ROOF SHEATHING (AS ALLOWED BY THE STRUCTURAL ENGINEER) TO ALLOW PASSAGE AND ATTIC VENTILATION BETWEEN THE TWO OR ISOLATED ATTIC SPACES SHALL BE VENTED INDEPENDENTLY TO CRE BE VENTED INDEPENDENTLY TO CBC REQUIREMENTS.

PER DEVELOPER, AT ALL CANTILEVERED FLOORS, CANTILEVERED ARCHITECTURAL POP-OUTS, AND ANY DOUBLE FRAIMING PROJECTIONS THAT ARE SEPARATED FROM THE VENTING CALCULATIONS SHOWN ABOVE, PROVIDE A CONTINUOUS 2° CORROSION RESISTANT SOFFIT VENT AT UNDERSIDE OF FEMARED RE IMENT FRAMED ELEMENT.

#### NOTES:

- ALL ROOF DRAINAGE SHALL BE PIPED TO STREET OR APPROVED DRAINAGE FACILITY.
   DASHED LINES INDICATE WALL BELOW.
   LOCATE GUTTER AND DOWNSPOUTS PER
- BUILDER. PITCHED ROOFS AS NOTED.

TRUSS MANUFACTURER SHALL SUBMIT STRUCTURAL CALCS AN SHOP DRAWING TO THE BUILDER'S GENERAL CONTRACTOR AND BUILDING DEPARTMENT FOR REVIEW PRIOR TO FABRICATIONS. ALL PLUMBING VENTS SHALL BE COMBINED INTO A MINIMUM AMOUNT OF ROOF PENETRATIONS. ALL ROOF PENETRATIONS SHALL OCCUR TO THE REAR OF THE MAIN RIDGE.

AS AN ALTERNATE TO THE 1/150 RATIO LISTED, THE NET FREE CROSS-VENTILATION AREA MAY BE REDUCED TO 1/300 WHEN A VAPOR BARRIER IS HAVING A TRANSMISSION RATE NOT EXCEEDING I-PERM INSTALLED ON THE WARM-IN-WINTER SIDE OF THE CEILING.


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1/300 RATIO:

	ROOF VENT CALC. ELEV. '1'		
Name	Area	1/300 RATIO AT HIGH & LOW	1/150 RATIO AT HIGH & LOW
AREA 1	1307 SF	313.64 in <sup>2</sup>	627.28 in <sup>2</sup>
AREA 2	155 SF	37.24 in <sup>2</sup>	74.48 in <sup>2</sup>
AREA 3	100 SF	24.00 in <sup>2</sup>	48.00 in <sup>2</sup>



11.09.16
SHEET NO:
A5.1.2

### **ROOF PLAN '1'**

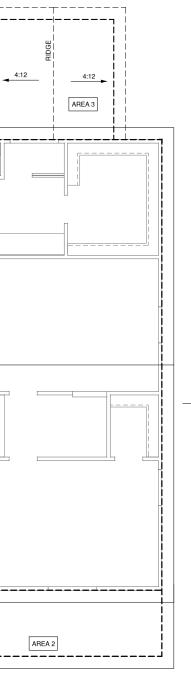SHEET TITLE:

PRINT DATE:

PROJECT NO:

QUACKENBUSH HOMES

CLIENTS NAME:



PROJECT TITLE: QUACKENBUSH HOMES LLC 9220 FAIRBANKS DR SUITE 240 RALEIGH, NC 27613 919-741-7993

PROFESSIONAL SEAL:


NO: DATE: REVISION:

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CARY, NC 27511 PHONE: (919) 320-3022


SUITE C



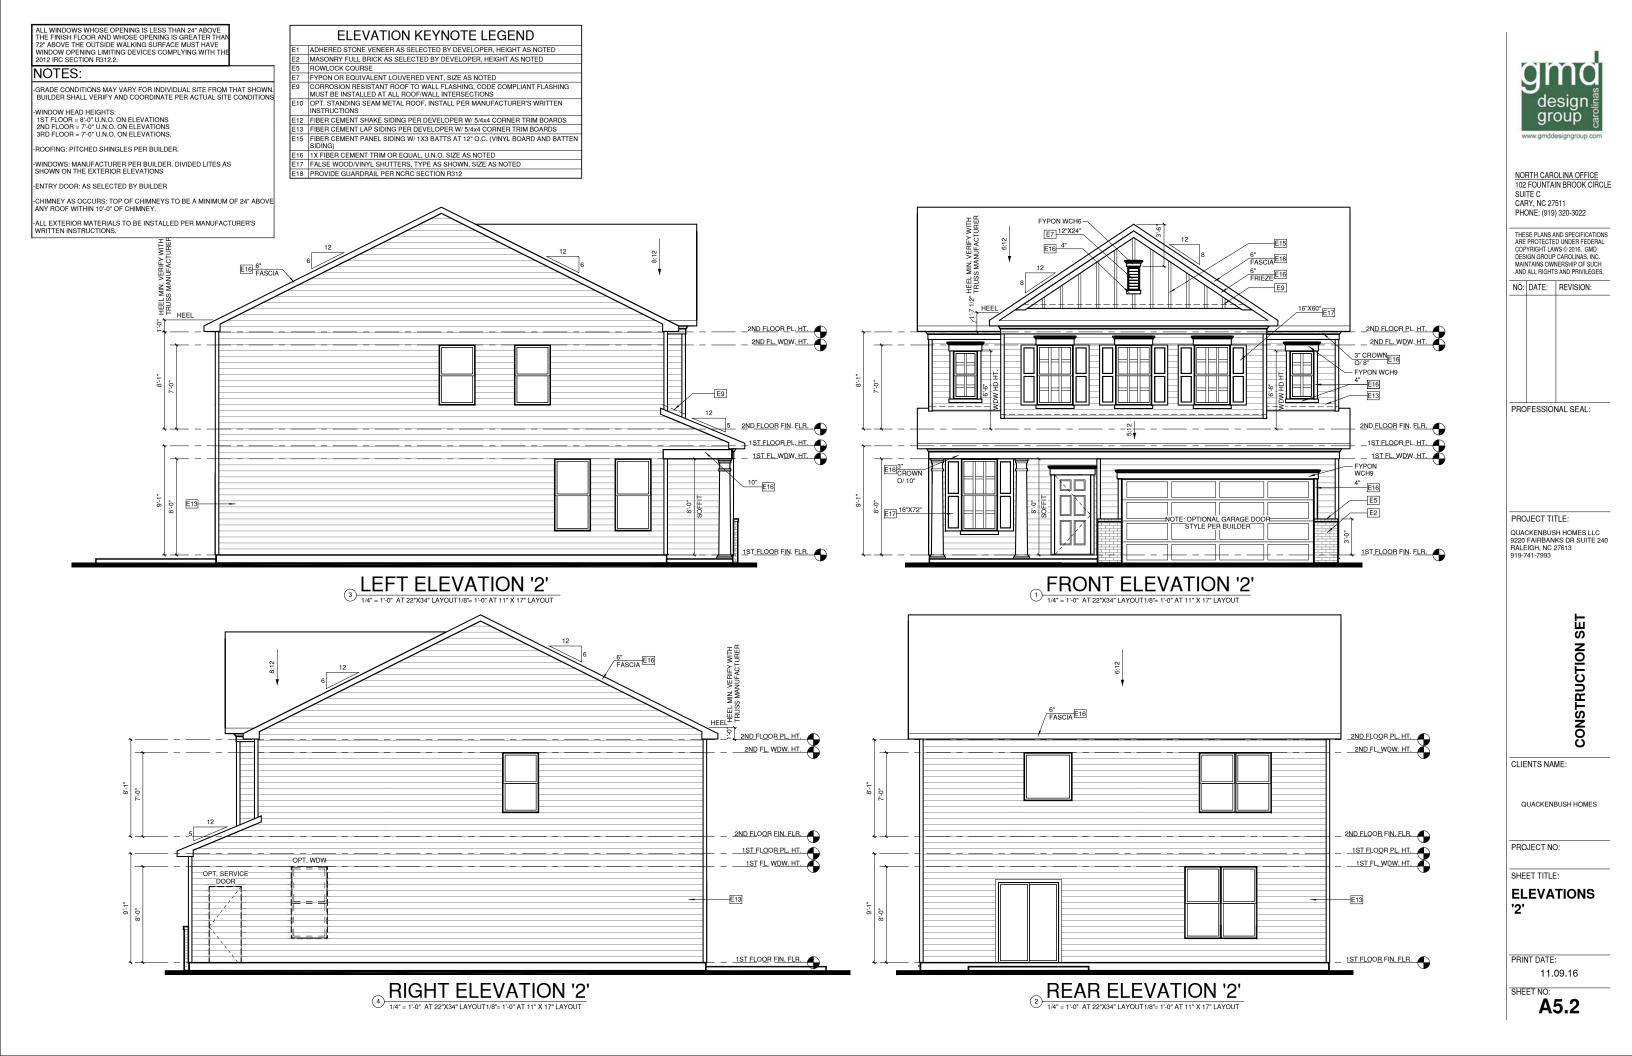

1/150 RATIO:	1/300 RATIO:
GENERAL CONTRACTOR SHALL VERIFY THE NET FREE VENTILATION OF THE VENT PRODUCT SELECTED BY OWNER. VERIFY WITH MANUFACTURER OF HIGH AND LOW VENTS TO BE USED FOR MINIMUM CALCULATED VENTS REQUIRED. THE REQUIRED VENTILATION SHALL BE MAINTAINED. PROVIDE INSUI ATION STOP	AS AN ALTERNATE TO THE 1/150 RATIO LISTED, THE NET FREE CROSS-VENTILATION AREA MAY BE REDUCED TO 1/300 WHEN A VAPOR BARIERI IS HAVING A TRANSMISSION RATE NOT EXCEEDING I-PERM INSTALLED ON THE WARM-IN- WINTER SIDE OF THE CELLING. GENERAL CONTRACTOR SHALL VERIEY THE NET FREE
SUCH THAT INSULATION DOES NOT OBSTRUCT FREE AIR MOVEMENT AS REQUIRED BY THE BUILDING OFFICIAL.	VENTILATION OF THE VENT PRODUCT SELECTED BY OWNER. VERIFY WITH MANUFACTURER OF HIGH AND LOW VENTS TO BE USED FOR MINIMUM CALCULATED VENTS REQUIRED. THE REQUIRED VENTILATION SHALL BE MAINTAINED. PROVIDE
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PROVIDE A CONTINUOUS 2" CORROSION RESISTANT SOFFIT VENT AT UNDERSIDE OF FRAMED ELEMENT.	FROM THE VENTING CALCULATIONS SHOWN ABOVE, PROVIDE A CONTINUOUS 2" CORROSION RESISTANT SOFFIT VENT AT UNDERSIDE OF FRAMED ELEMENT.
NOTES:	
ALL ROOF DRAINAGE SHALL BE PIPED TO STREET OR APPROVED DRAINAGE FACILITY.     DASHED LINES INDICATE WALL BELOW.     LOCATE GUTTER AND DOWNSPOUTS PER BUILDER.     PITCHED ROOFS AS NOTED.	<ol> <li>TRUSS MANUFACTURER SHALL SUBMIT STRUCTURAL CALCS AN SHOP DRAWING TO THE BUILDER'S GENERAL CONTRACTOR AND BUILDING DEPARTMENT FOR REVIEW PRIOR TO FABRICATIONS.</li> <li>ALL PLUMBING VENTS SHALL BE COMBINED INTO A MINIMUM AMOUNT OF ROOF PENETRATIONS. ALL ROOF PENETRATIONS SHALL OCCUR TO THE REAR OF THE MAIN RIDGE.</li> </ol>

	ROOF	VENT CALC. E	ELEV. '2'
Name	Area	1/300 RATIO AT HIGH & LOW	1/150 RATIO AT HIGH & LOW
AREA 1	1308 SF	313.92 in <sup>2</sup>	627.84 in <sup>2</sup>
AREA 2	154 SF	36.96 in <sup>2</sup>	73.92 in <sup>2</sup>
ABEA 3	100 SE	24.00 in <sup>2</sup>	48.00 in <sup>2</sup>

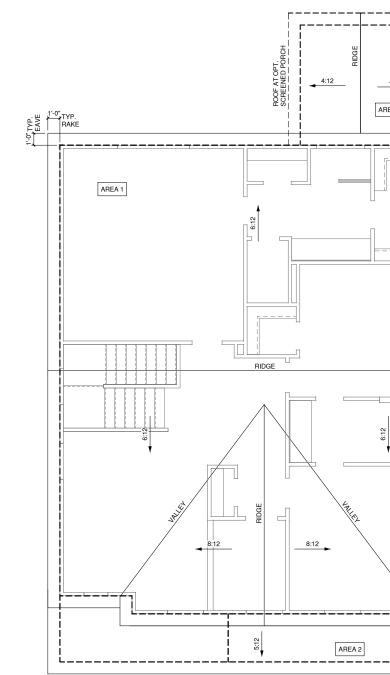





11.09.16
SHEET NO: <b>A5.2.1</b>

ROOF PLAN '2'

PROJECT NO: SHEET TITLE:

PRINT DATE:

QUACKENBUSH HOMES

CLIENTS NAME:



PROJECT TITLE: QUACKENBUSH HOMES LLC 9220 FAIRBANKS DR SUITE 240 RALEIGH, NC 27613 919-741-7993


PROFESSIONAL SEAL:

design group

NORTH CAROLINA OFFICE 102 FOUNTAIN BROOK CIRCLE SUITE C CARY, NC 27511 PHONE: (919) 320-3022

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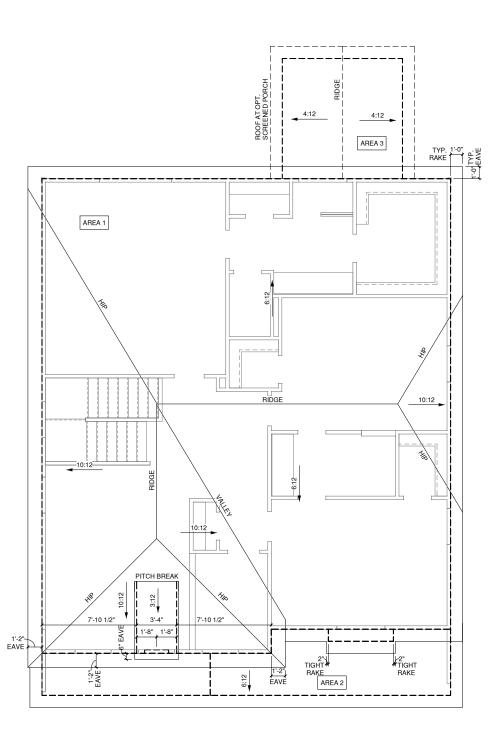
NO: DATE: REVISION:

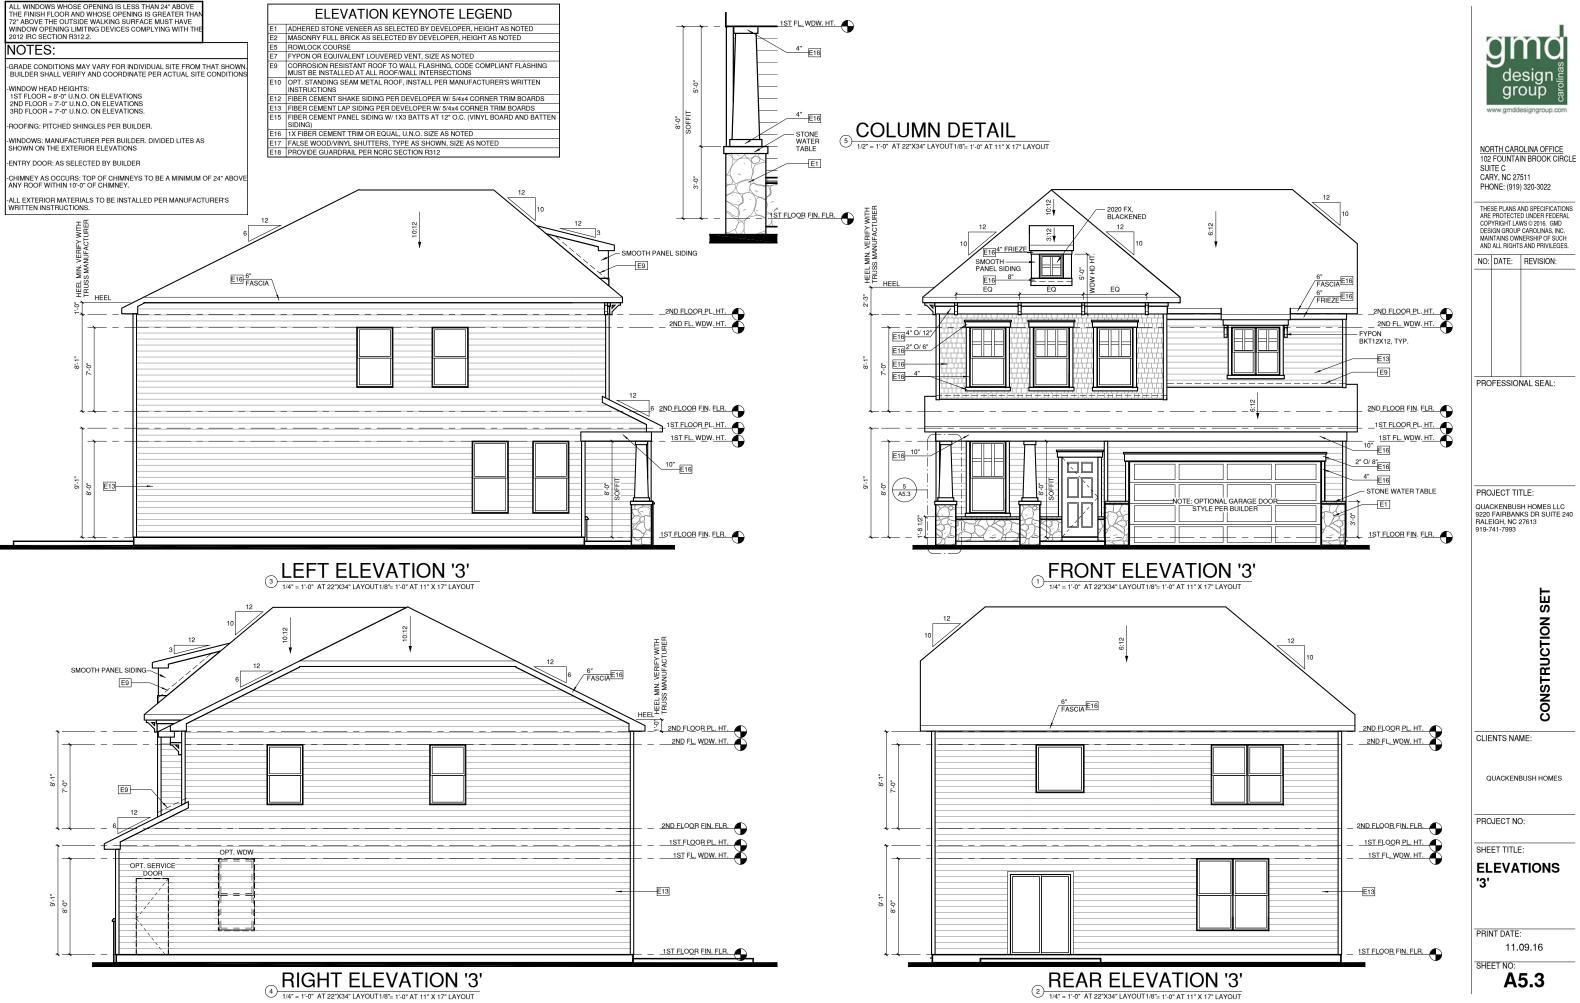

1/150 RATIO:	1/300 RATIO:
GENERAL CONTRACTOR SHALL VERIFY THE NET FREE VENTILATION OF THE VENT PRODUCT SELECTED BY OWNER. VERIFY WITH MANUFACTURER OF HIGH AND LOW VENTS TO BE USED FOR MINIMUM CALCULATED VENTS REQUIRED. THE REQUIRED VENTILATION SHALL BE MAINTAINED. PROVIDE INSULATION STOP SUCH THAT INSULATION DOES NOT OBSTRUCT FREE AIR MOVEMENT AS REQUIRED BY THE BUILDING OFFICIAL. ALL OVERLAP FRAMED ROOF AREAS SHALL HAVE OPENINGS BETWEEN THE ADJACENT ATTICS IN THE ROOF SHEATHING (AS ALLOWED BY THE STRUCTURAL ENGINEER) TO ALLOW PASSAGE AND ATTIC VENTILATION BETWEEN THE TWO OR ISOLATED ATTIC SPACES SHALL BE VENTED INDEPENDENTLY TO CBC REQUIREMENTS. PER DEVELOPER, AT ALL CANTILEVERED FLOORS, CANTILEVERED ARCHITECTURAL POP- OUTS, AND ANY DOUBLE FRAMING PROJECTIONS THAT ARE SEPARATED FROM THE VENTING CALCULATIONS SHOWN ABOVE, PROVIDE A CONTINUOUS 2° CORROSION RESISTANT SOFFIT VENT AT UNDERSIDE OF FRAMED ELEMENT.	AS AN ALTERNATE TO THE 1/150 RATIO LISTED. THE NET FREE CROSS-VENTILATION AREA MAY BE REDUCED TO 1/300 WHEN A VAPOR BARRIER IS HAVING A TRANSMISSION RATE NOT EXCEEDING I-PERM INSTALLED ON THE WARM-IN- WINTER SIDE OF THE CEILING. GENERAL CONTRACTOR SHALL VERIFY THE NET FREE VENTILATION OF THE VENT PRODUCT SELECTED BY OWNER. VERIFY WITH MANUFACTURER OF HIGH AND LOW VENTS TO BE USED FOR MINIMUM CALCILATED VENTS REQUIRED. THE REQUIRED VENTLATION SHALL BE MAINTAINED. PROVIDE INSULATION STOP SUCH THAT INSULATION DOES NOT OBSTRUCT FREE AIR MOVEMENT AS REQUIRED BY THE BUILDING OFFICIAL. ALL OVERLAP FRAMED ROOF AREAS SHALL HAVE OPENINGS BETWEEN THE ADJACENT ATTICS IN THE ROOF SHEATHING (AS ALLOWED BY THE STRUCTURAL ENGINEER) TO ALLOW PASSAGE AND ATTIC VENTLATION BETWEEN THE TWO OR ISOLATED ATTIC SPACES SHALL BE VENTED INDEPENDENTLY TO CBC REQUIREMENTS. PER DEVELOPER, AT ALL CANTILEVERED FLOORS, CANTILEVERED ARCHITECTURAL POP-OUTS, AND ANY DOUBLE FRAMING PROJECTIONS THAT ARE SEPARATED FROM THE VENTING CALCULATIONS SHOWN ABOVE. PROVIDE A CONTINUOUS 2° CORROSION RESISTANT SOFFIT VENT AT UNDERSIDE OF FRAMED ELEMENT.
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- ALL PLUMBING VENTS SHALL BE COMBINED INTO A MINIMUM AMOUNT OF ROOF PENETRATIONS. ALL ROOF PENETRATIONS SHALL OCCUR TO THE REAR OF THE MAIN RIDGE.

ROOF VENT CALC. ELEV. '3'			
Name	Area	1/300 RATIO AT HIGH & LOW	1/150 RATIO AT HIGH & LOW
AREA 1	1313 SF	315.16 in <sup>2</sup>	630.32 in <sup>2</sup>
AREA 2	149 SF	35.72 in <sup>2</sup>	71.44 in <sup>2</sup>
AREA 3	100 SF	24.00 in <sup>2</sup>	48.00 in <sup>2</sup>





11.09.16
SHEET NO:
A5.3.1

**ROOF PLAN '3'** 

PROJECT NO: SHEET TITLE:

PRINT DATE:

QUACKENBUSH HOMES

CLIENTS NAME:



PROJECT TITLE: QUACKENBUSH HOMES LLC 9220 FAIRBANKS DR SUITE 240 RALEIGH, NC 27613 919-741-7993


PROFESSIONAL SEAL:

design group www.gmddesigngroup.con

NORTH CAROLINA OFFICE 102 FOUNTAIN BROOK CIRCLE SUITE C CARY, NC 27511 PHONE: (919) 320-3022


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NO: DATE: REVISION:

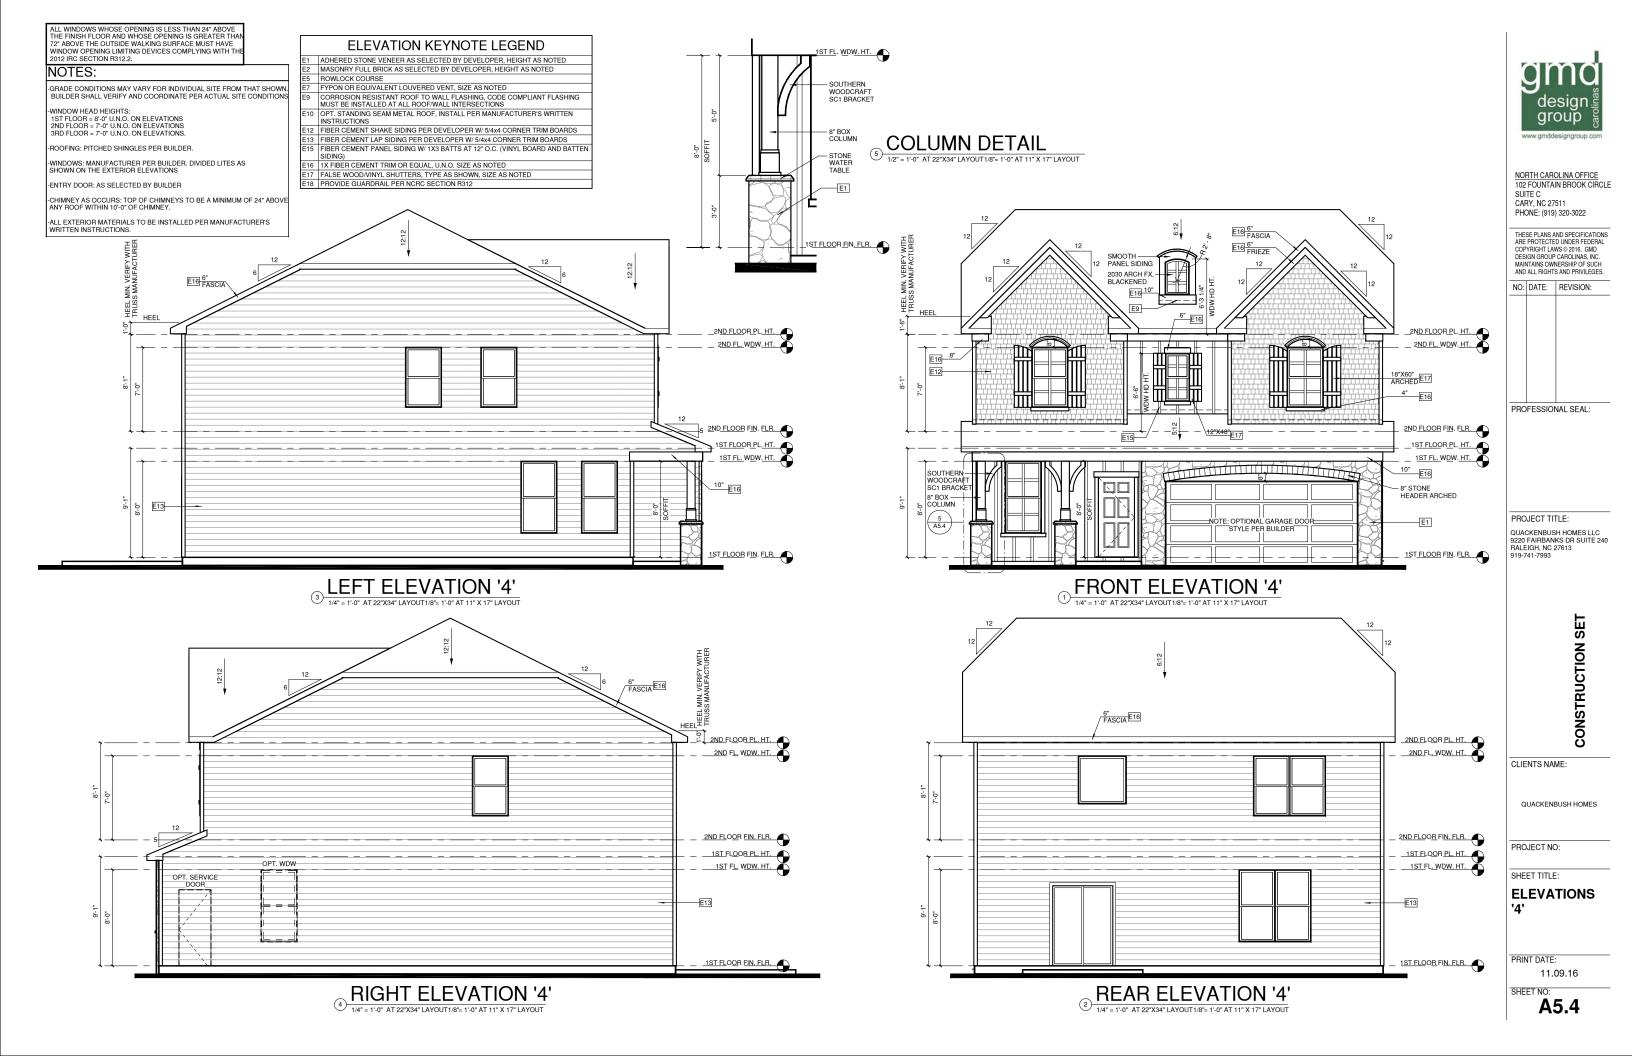

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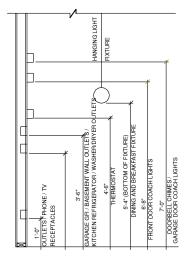
ROOF VENT CALC. ELEV. '4'						
Name	Area	1/300 RATIO AT HIGH & LOW	1/150 RATIO AT HIGH & LOW			
Area	136 SF	32.64 in <sup>2</sup>	65.28 in <sup>2</sup>			
AREA 1	1326 SF	318.24 in <sup>2</sup>	636.48 in <sup>2</sup>			
AREA 3	100 SF	24.00 in <sup>2</sup>	48.00 in <sup>2</sup>			






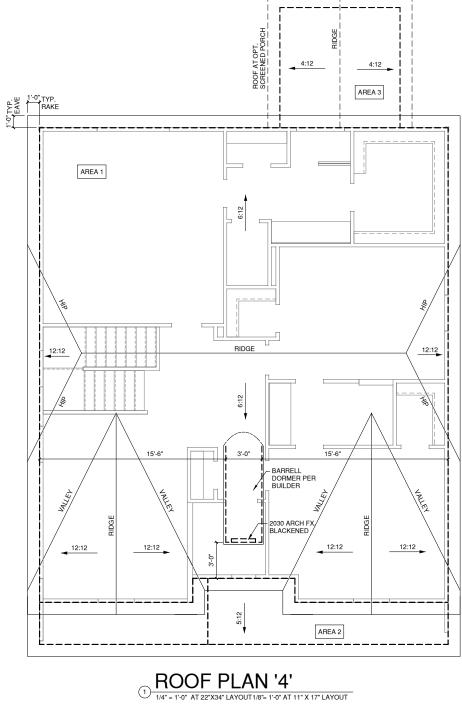

gl design group



### STANDARD ELECTRICAL BOX HEIGHTS

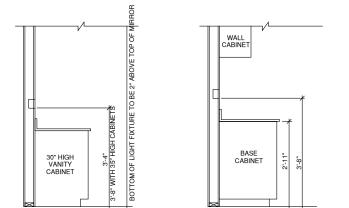

# SWITCH AND RECEPTACLE SWITCH AND RECEPTACLE

### BOXES OVER BATH CABINETSBOXES OVER KITCHEN CABINETS

### NOTES:

PROVIDE GROUNDING ELECTRICAL ROD PER LOCAL CODES.

-PROVIDE AND INSTALL ARC FAULT CIRCUIT-INTERRUPTERS (AFCI) AS REQUIRED BY NATIONAL ELECTRICAL CODE (NEC) AND MEETING THE REQURIEMENTS OF ALL GOVERNING CODES.

ALL EXHAUST FANS SHALL HAVE BACKDRAFT DAMPERS

-FAN/LIGHTS IN WET/DAMP LOCATIONS SHALL BE LABLED "SUITABLE FOR WET OR DAMP LOCATIONS."

-ELECTRICAL SYSTEMS ARE SHOWN FOR INTENT ONLY. THESE SYSTEMS SHALL BE ENGINEERED BY RS. THE CONTRACTOR SHALL BE RESPONSIBLE FOR PROPER INSTALLATION AND PLACEMENT

PROVIDE AND INSTALL LOCALLY CERTIFIED SMOKE DETECTORS AND CO2 DETECTORS AS REQUIRED BY NATIONAL FIRE PROTECTION ASSOCIATION (NFPA) AND MEETING THE REQUIREMENTS OF ALL GOVERNING CODES.

-PROVIDE AND INSTALL GROUND FAULT CIRCUIT-INTERRUPTERS (GFI) AS REQUIRED BY NATIONAL ELECTRICAL CODE (NEC) AND MEETING THE REQUIREMENTS OF ALL GOVERNING CODES.

-ELECTRICAL CONTRACTOR TO PROVIDE REQURIED DIRECT HOOK-UPS/CUTOFFS.


-HVAC CONTRACTOR TO VERIFY THERMOSTAT LOCATIONS.


ALL ELECTRICAL AND MECHANICAL EQUIPMENT (FURNACES, A/C UNITS, ELECTRICAL PANELS, SANITARY SUMP PITS DRAING TILE SUMP, AND WATER HEATERS) ARE SUBJECT TO RELOCATOIN DUE TO FIELD CONDITIONS.

-PROVIDE POWER, LIGHT AND SWITCH AS REQUIRED FOR ATTIC FURNACE PER CODE AND MANUFACTURER'S WRITTEN INSTRUCTIONS.

### LEGEND.

LEGEND:					
P	DUPLEX OUTLET	- <del>\</del>	CEILING MOUNTED INCANDESCENT LIGHT FIXTURE		
¶wp/gfi	WEATHERPROOF GFI DUPLEX OUTLET	-	WALL MOUNTED INCANDESCENT LIGHT FIXUTRE		
₽gfi	GROUND-FAULT CIRCUIT- INTERRUPTER DUPLEX OUTLET	¥.	RECESSED INCANDESCENT LIGHT FIXTURE		
0	HALF-SWITCHED DUPLEX OUTLET	Υ	(VP) = VAPOR PROOF		
₽ 220V	220 VOLT OUTLET		EXHAUST FAN (VENT TO EXTERIOR)		
J	REINFORCED JUNCTION BOX	-0-	EXHAUST FAN/LIGHT COMBINATION (VENT TO EXTERIOR)		
\$	WALL SWITCH		· · · ·		
\$3	THREE-WAY SWITCH	$\bowtie$	FLUORESCENT LIGHT FIXTURE		
\$4	FOUR-WAY SWITCH		TECH HUB SYSTEM		
СН	CHIMES	$\mathbb{N}$	CEILING FAN		
Ŧ	PUSHBUTTON SWITCH		(PROVIDE ADEQUATE SUPPORT)		
SD	110V SMOKE DETECTOR W/ BATTERY BACKUP	S	CEILING FAN WITH INCANDESCENT LIGHT FIXTURE		
0	CO2 DETECTOR	]⁄^^\	(PROVIDE ADEQUATE SUPPORT)		
Ī	THERMOSTAT		GAS SUPPLY WITH VALVE		
PH	TELEPHONE	-			
TV	TELEVISION		HOSE BIBB		
	ELECTRIC METER	l—tw	1/4" WATER STUB OUT		
	ELECTRIC PANEL DISCONNECT SWITCH	-4	WALL SCONCE		
	DISCONNECT SWITCH	1			

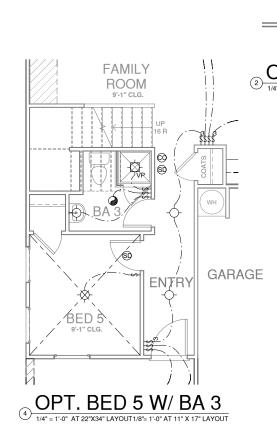

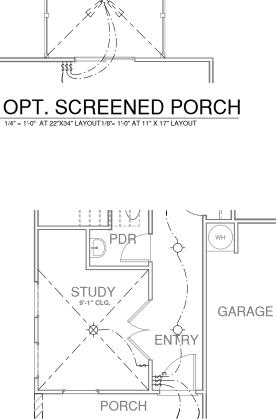



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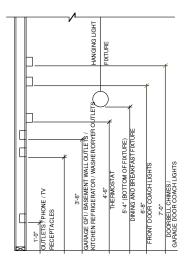
UTILITY PLAN

11.09.16


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PRINT DATE:

SHEET NO:

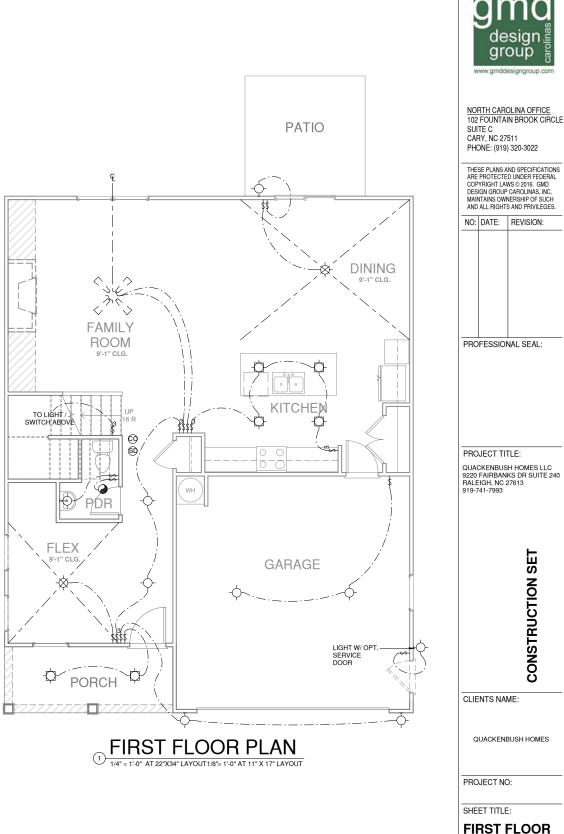
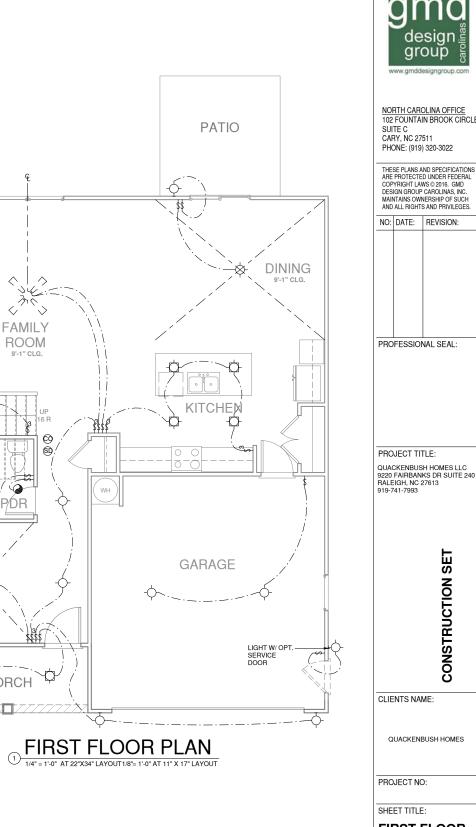
### STANDARD ELECTRICAL BOX HEIGHTS

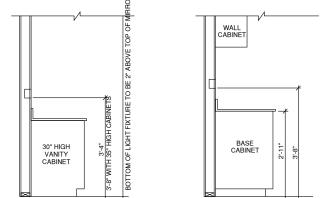

#### SWITCH AND RECEPTACLE SWITCH AND RECEPTACLE BOXES OVER BATH CABINETSBOXES OVER KITCHEN CABINETS

#### NOTES:

PROVIDE GROUNDING ELECTRICAL ROD PER LOCAL CODES.

-PROVIDE AND INSTALL ARC FAULT CIRCUIT-INTERRUPTERS (AFCI) AS REQUIRED BY NATIONAL ELECTRICAL CODE (NEC) AND MEETING THE REQURIEMENTS OF ALL GOVERNING CODES.

ALL EXHAUST FANS SHALL HAVE BACKDRAFT DAMPERS

FAN/LIGHTS IN WET/DAMP LOCATIONS SHALL BE LABLED "SUITABLE FOR WET OR DAMP LOCATIONS." -ELECTRICAL SYSTEMS ARE SHOWN FOR INTENT ONLY. THESE SYSTEMS SHALL BE ENGINEERED BY

OTHERS. THE CONTRACTOR SHALL BE RESPONSIBLE FOR PROPER INSTALLATION AND PLACEMENT

-PROVIDE AND INSTALL LOCALLY CERTIFIED SMOKE DETECTORS AND CO2 DETECTORS AS REQUIRED BY NATIONAL FIRE PROTECTION ASSOCIATION (NFPA) AND MEETING THE REQUIREMENTS OF ALL GOVERNING CODES. -PROVIDE AND INSTALL GROUND FAULT CIRCUIT-INTERRUPTERS (GFI) AS REQUIRED BY NATIONAL ELECTRICAL CODE (NEC) AND MEETING THE REQUIREMENTS OF ALL GOVERNING CODES.

-ELECTRICAL CONTRACTOR TO PROVIDE REQURIED DIRECT HOOK-UPS/CUTOFFS.


HVAC CONTRACTOR TO VERIFY THERMOSTAT LOCATIONS.

ALL ELECTRICAL AND MECHANICAL EQUIPMENT (FURNACES, A/C UNITS, ELECTRICAL PANELS, SANITARY SUMP PITS DRAING TILE SUMP, AND WATER HEATERS) ARE SUBJECT TO RELOCATOIN DUE TO FIELD CONDITIONS.


-PROVIDE POWER, LIGHT AND SWITCH AS REQUIRED FOR ATTIC FURNACE PER CODE AND MANUFACTURER'S WRITTEN INSTRUCTIONS.


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LEGEND:					
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¶wp/gfi	WEATHERPROOF GFI DUPLEX OUTLET	5	WALL MOUNTED INCANDESCENT LIGHT FIXUTRE		
₽gfi	GROUND-FAULT CIRCUIT- INTERRUPTER DUPLEX OUTLET	LY LA	RECESSED INCANDESCENT LIGHT FIXTURE		
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SD	110V SMOKE DETECTOR W/ BATTERY BACKUP	S	CEILING FAN WITH INCANDESCENT LIGHT FIXTURE		
Ø	CO2 DETECTOR		(PROVIDE ADEQUATE SUPPORT)		
T	THERMOSTAT		GAS SUPPLY WITH VALVE		
PH	TELEPHONE				
TV	TELEVISION		HOSE BIBB		
<u>۵</u>	ELECTRIC METER	l−t <sub>cw</sub>	1/4" WATER STUB OUT		
	ELECTRIC PANEL	-4	WALL SCONCE		
	DISCONNECT SWITCH	ĸ	WALL SUDINCE		

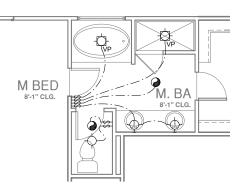

OPT. MASTER BATH 1 (2)1/4" = 1'-0" AT 22"X34" LAYOUT1/8"= 1'-0" AT 11" X 17" LAYOUT



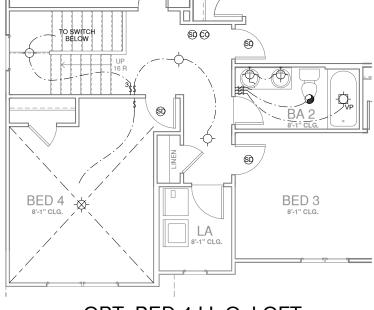

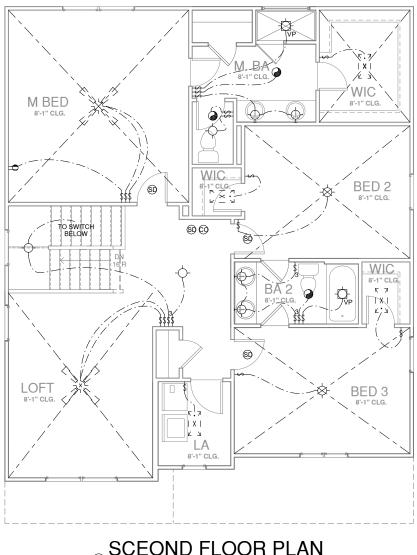

# () SCEOND FLOOR PLAN 1/4" = 1'-0" AT 22"X34" LAYOUT 1/8" = 1'-0" AT 11" X 17" LAYOUT



NORTH CAROLINA OFFICE 102 FOUNTAIN BROOK CIRCLE SUITE C CARY, NC 27511 PHONE: (919) 320-3022 THESE PLANS AND SPECIFICATIONS ARE PROTECTED UNDER FEDERAL COPYRIGHT LAWS © 2016. GMD DESIGN GROUP CAROLINAS, INC. MAINTAINS OWNERSHIP OF SUCH AND ALL RIGHTS AND PRIVILEGES. NO: DATE: REVISION: PROFESSIONAL SEAL: PROJECT TITLE: QUACKENBUSH HOMES LLC 9220 FAIRBANKS DR SUITE 240 RALEIGH, NC 27613 919-741-7993 CONSTRUCTION SET CLIENTS NAME: QUACKENBUSH HOMES PROJECT NO: SHEET TITLE: SECOND **FLOOR UTILITY** PLAN PRINT DATE: 11.09.16

SHEET NO:

E2.0