ABBREVIATIONS INDEX L LENGTH LA LAUNDRY LAV LAVATORY LVR LOUVER MAX MAXIMUM MECH MECHANICAL MFR. MANUFACTURER MIN MINIMUM MISC MISCELLANEOUS ADJ ADJUSTABLE ALT ALTERNATE ALUM ALUMINUM SLAB PERIMETER PLAN 6-PLEX FIRST FLOOR PLAN 6-PLEX ALUM ALUMINUM ARCH. ARCHITECTURAL BA BATHROOM BD BOARD BE BI-FOLD (DOOR) BLOG BUILDING BLK BLOCK (CMUs) BLW BELOW BM BEAM BP BI-PASS (DOOR) BOT BOTTOM BTWEEN CAR CARB CARBIET A2.1 SECOND FLOOR PLAN 6-PLEX ELEVATIONS 6-PLEX ELEVATIONS 6-PLEX MISC MISCELLANEOUS N. NORTH OSCALE OG.D. OVERHEAD GARAGE DOOR OH OVERHEAD GARAGE DOOR OH OFFICINAL PAR BASALEUTTON POR POWDER PROPER POWDER PER PEDESTAL A5.1.2 **ROOF PLAN 6-PLEX** DETAILS DETAILS CAB CABINET CER CERTAINC CJ. CONTROL JOINT OR CONSTRUCTION JOINT CL CLOSET OR CENTER LINE CLOSET OR CENTER LINE CLOSET OR CENTER LINE CHI COUNCE CONCERTE MASONRY UNIT COL COLUMN CONC CONCERTE CREATER SOON RESISTANT COME CAREFULLY CONTROL CO PR PAIR P.T. PRESSURE TREATED WOOD PVC POLYVINYL CHLORIDE PIPE PVM PRE-WRE PWD PLYWOOD R RISER RAG RETURN AIR GRILL SOUTH DESCRIPTION SOUTH OF THE PROPERTY OF THE SYM SYMBOL SYM SYMBOL SYM SYMBOL T TREAD (AT STAIRS) OR TILE T.B. TOWEL BAR TEMPORED (GLACO) ELEV ELEVATION ELEC ELECTRICAL EQ EQUAL EXT EXTERIOR EXT EXTRING RANGE FOR CONTROL OF THE PROPERTY TEMP. TEMPERED (GLASS) T&G TONGUE & GROOVE T.O.C. TOP OF CURB TV TELEVISION TYP TYPICAL II N O LINI ESS NOTED OTHERWISE U.N.O. UNLESS NOTED OF V.B. VAPOR BARRIER VERTICAL V.T.R. VENT THRU ROOF W. WASHING MACHINE W. WOOD WINDOW WH WATER HEATER W. WROUGHT IRON WI WROUGHT IRON WIC WALK-IN CLOSET W/ W/O WITH OR WITHOU WP WATERPROOF(ING) WWM WELDED WIRE MESH R PROPERTY LINE Ø ROUND / DIAMETER HD HEAD OR HARD HDR HEADER HGT HEGHT HVAC HEATING/VENTILATING/AIR COND. HWD HARDWOOD INT INTERIOR JST JOIST J JOINT & AND C CENTERLINE # POUND / NUMBER BUILDING CODE COMPLIANCE PROJECT INFORMATION ALL CONSULTANT DRAWINGS ACCOMPANYING THESE GMD DESIGN GROUP CAROLINAS, INC. DRAWINGS HAVE NOT BEEN ALL CONSTRUCTION TO COMPLY WITH LOCAL CODES AND ORDINANCES CURRENTLY IN USE WITH THE LOCAL JURISDICTION. PREPARED BY OR LINDER THE DIRECTION OF GMD DESIGN GROUP CAROLINAS, INC. GMD DESIGN GROUP CAROLINAS, INC. THEREFORE ASSUMES NO LIABILITY FOR THE COMPLETENESS OR CORRECTNESS OF THESE DRAWINGS. FOLLOW ALL APPLICABLE STATE AND LOCAL CODES. 2012 NORTH CAROLINA STATE SUPPLEMENTS AND AMENDMENTS CONTRACTOR AND RUILDER SHALL REVIEW ENTIRE PLANTO VERIEV CONFORMANCE WITH ALL CURRENT APPLICABLE CODES IN EFFECT AT TIME OF CONSTRUCTION. BY USING THESE DRAWINGS FOR CONSTRUCTION IT IS UNDERSTOOD THAT CONFORMANCE WITH ALL APPLICABLE CODES IS THE RESPONSIBILITY OF THE BUILDER AND CONTRACTOR. 2 STORY TOWNHOMES

VILLAGES AT INDEPENDENCE DURHAM, NC

6-PLEX LOTS 49-54

THESE PLANS AND SPECIFICATIONS ARE PROTECTED

NO: DATE: REVISION:

PROFESSIONAL SEAL

PROJECT TITLE:

QUACKENBUSH HOMES LLC

RALEIGH, NC 27613 919-741-7993

CONSTRUCTION SET

CLIENTS NAME:

QUACKENBUSH HOMES

PROJECT NO:

SHEET TITLE:

COVER SHEET

SHEET NO

PRINT DATE: 09 19 17

T-1

GENERAL NOTES:

OCCUPANCY CLASSIFICATION RESIDENTIAL R-3

DUPLICATED, ALTERED, MODIFIED OR REVISED IN ANY WAY WITHOUT THE EXPRESSED WRITTEN APPROVAL OF THE DESIGNER. CONTRACTOR SHALL VERIFY ALL CONDITIONS AND DIMENSIONS AT THE SITE AND

TYPE VB (2 HOUR DWELLING SEPARATION BETWEEN UNITS.)

ALL INCONSISTENCES SHALL BE BROUGHT TO THE ATTENTION OF THE DEVELOPER AND THE DESIGNER BEFORE PROCEEDING WITH WORK.

ANY ERRORS OR OMISSIONS FOUND IN THESE DRAWINGS SHALL BE BROUGHT TO DEVELOPERS AND DESIGNERS ATTENTION IMMEDIATELY.

DO NOT SCALE DRAWINGS, WRITTEN DIMENSIONS TAKE PRECEDENCE OVER SCALED

ALL DIMENSIONS ARE TO FACE OF STUD OR TO FACE OF FRAMING UNLESS OTHERWISE NOTED. ALL TRUSS DRAWINGS TO BE REVIEWED AND APPROVED BY THE STRUCTURAL

ENGINEER PRIOR TO ISSUANCE OF BUILDING PERMIT ALL OR EQUAL SUBSTITUTIONS MUST BE SUBMITTED TO AND APPROVED BY CITY

ALL ANGLED PARTITIONS ARE 45 DEGREES UNLESS OTHERWISE NOTED PROVIDE FIREBLOCKING. (PER LOCAL CODES.)

ALL ELECTRICAL AND MECHANICAL FOLIPMENT AND METERS ARE SUBJECT TO RELOCATION DUE TO FIELD CONDITIONS, CONTRACTOR TO VERIFY

PROVIDE BLOCKING AND/OR BACKING AT ALL TOWEL BAR, TOWEL RING AND/OR TOILET PAPER HOLDER LOCATIONS, AS SHOWN PER PLAN, TYPICAL AT ALL BATHROOMS AND POWDER BOOMS, VERIEY LOCATIONS AT FRAMING WALK.

ELASTOMERIC SHEET WATERPROOFING: EURNISH AND INSTALL ALL WATERPROOFING COMPLETE. A 40 MIL. SELF-ADHERING MEMBRANE OF RUBBERIZED
ASPHALT INTEGRALLY BONDED TO POLYETHYLENE SHEETING, OR EQUAL. INSTALLATION INSTRUCTIONS, 6" MINIMUM LAP AT ALL ADJACENT WALL SURFACES

TO THE BEST OF THE DESIGNER'S KNOWLEDGE THESE DOCUMENTS ARE IN CONFORMANCE WITH THE REQUIREMENTS OF THE BUILDING AUTHORITIES HAVING JURISDICTION OVER THIS TYPE OF CONSTRUCTION AND OCCUPANCY. SHOP DRAWING REVIEW AND DISTRIBUSTION, ALONG WITH PRODUCT SUBMITTALS,

REQUESTED IN THE CONSTRUCTION DOCUMENTS, SHALL BE THE SOLE RESPONSIBILITY OF THE GENERAL CONTRACTOR, UNLESS DIRECTED OTHERWISE

DEVIATIONS FROM THESE DOCUMENTS IN THE CONSTRUCTION PHASE SHALL BE REVIEWED BY THE DESIGNER AND THE OWNER PRIOR TO THE START OF WORK IN QUESTION. ANY DEVIATIONS FROM THESE DOCUMENTS WITHOUT PRIOR REVIEW, SHALL BE THE SOLE RESPONSIBILITY OF THE GENERAL CONTRACTOR. THE GENERAL CONTRACTOR SHALL BE RESPONSIBLE FOR ALL WORK AND MATERIALS REPRESENTED ON THESE DOCUMENTS INCLUDING THE WORK AND

MATERIALS FURNISHED BY SUBCONTRACTORS AND VENDORS.

GEOTECHNICAL ENGINEER (SOILS REPORT), ON THE STUDY OF THE PROPOSED SITE TO THE DESIGNER, STRUCTURAL ENGINEER, AND GENERAL CONTRACTOR, IN THE EVENT THE GEOTECHNICAL REPORTS DO NOT EXIST, THE SOILS CONDITION SHALL EVENT I THE GEOTECHINGLE HEPORTS DO NOT EAST, THE SOILS CONDITION SHALL BE ASSUMED TO BE A MINIMUM DESIGN SOIL PRESSURE STATED BY THE STRUCTURAL ENGINEER OF RECORD FOR THE PURPOSE OF STRUCTURAL DESIGN. GENERAL CONTRACTOR SHALL ASSURE THE SOIL CONDITIONS MEET OR EXCEED THE CONTRACT THE CRITERIA.

ALL WORK PERFORMED BY THE GENERAL CONTRACTOR SHALL COMPLY AND CONFORM WITH LOCAL AND STATE BUILDING CODES, ORDINANCES AND REGULATIONS, ALONG WITH ALL OTHER AUTHORITIES HAVING JURISDICTION. THE GENERAL CONTRCATOR IS RESPONSIBLE TO BE AWARE OF THESE REQUIREMENTS AND GOVERNING REGULATIONS.

PROVIDE AN APPROVED WASHER DRAIN PAN AT SECOND FLOOR ONLY

PROVIDE STAIR HANDRAILS AND GUARDRAILS PER LOCAL CODES.

WINDOW SUPPLIER TO VERIEY AT LEAST ONE WINDOW IN ALL REDROOMS TO HAVE A CLEAR WINDOWS SUFFICIENT VENIET AT THE MINIMUM NET CLEAR OPENING HEIGHT SHALL BE 22" AND THE MINIMUM NET CLEAR OPENING HEIGHT SHALL BE 22" AND THE MINIMUM NET CHEAR OPENING HEIGHT SHALL BE 22" AND THE MINIMUM NET OF THE MENT WITH SHALL BE 20". GLAZING TOTAL AREA OF NOT LESS THAN 5.0 S OF IT NOT LESS THAN 5.0 S OF THE MENT CASE OF AN UPPER STORY WINDOW. (PER NCRC SECTION R310.1.1) ALL HANDRAIL BALLUSTERS TO BE SPACED SUCH THAT A 4" SPHERE CANNOT PASS BETWEEN BALLUSTERS, (PER LOCAL CODES.)

BUILDER SET:

THE SCOPE OF THIS SET OF PLANS IS TO PROVIDE A "BUILDER'S SET" THE SCOPE OF THIS SET OF PLANS IS TO PROVIDE A "PULLIDERS SET" OF CONSTRUCTION DOCUMENTS AND GENERAL NOTES HEREINAFTER REFERRED TO AS "PLANS". THIS SET OF PLANS IS SUFFICIENT TO OBTAIN A BUILDING PERMIT; HOWEVER, ALL MATERIALS AND METHODS OF CONSTRUCTION NECESSARY TO COMPLETE THE PROJECT ARE NOT NECESSARILY DESCRIBED. THE PLANS DELINEATE AND DESCRIBE ONLY LOCATIONS. DIMENSIONS, TYPES OF MATERIALS, AND GENERAL METHODS OF ASSEMBLING OR FASTENING. THEY ARE NOT INTENDED TO SPECIFY PARTICULAR PRODUCTS OR OTHER METHODS OF ANY SECURITY OF A STATEMENT OF THE METHODS OF ANY SECURITY OF THE METHOD SOFT OF THE METHODS OF ANY SECURITY OF THE METHOD SOFT OF THE ME SPECIFIC MATERIALS, PRODUCT OR METHOD. THE IMPLEMENTATION OF THE PLANS REQUIRES A CLIENT / CONTRACTOR THOROUGHLY KNOWLEDGEABLE WITH THE APPLICABLE BUILDING CODES AND METHODS OF CONSTRUCTION SPECIFIC TO THIS PRODUCT TYPE AND TYPE OF CONSTRUCTION

CONSTRUCTION REQUIREMENTS AND QUALITY: PROVIDE WORK OF THE SPECIFIC QUALITY: WHERE QUALITY LEVEL IS NOT INDICATED, PROVIDE WORK OF QUALITY CUSTOMARY IN SIMILAR TYPES OF WORK, WHERE THE PLANS AND SPECIFICATIONS, CODES, LAWS, REGULATIONS, THE SUPPLY WITH, WITHER THE PLANS AND SPECIFICALIUMS, CODES, LAWS, REGULATIONS, MANUFACTURER'S RECOMMENDATIONS ON HIDDSTRY STANDARDS REQUIRE WORK OF HIGHER QUALITY OR PERFORMANCE, PROVIDE WORK COMPLYING WITH THOSE RECUIREMENTS AND QUALITY, WHERE THE OR OR MORE QUALITY PROVISIONS OF THOSE REQUIREMENTS CONFLICT WITH THE MOST STRINGENT REQUIREMENT; WHERE REQUIREMENTS ARE DIFFERENT BUT APPARENTLY EQUAL, AND WHERE IT IS HOCEFTAIN WHICH REQUIREMENT IS MOST STRINGENT, OBTAIN CLARIFICATION FROM THE ARCHITECT BEFORE PROCEEDING.

NOTES:


- REFER TO FIRE PROTECTION SHEETS FOR ALL TYPICAL FIRE PROTECTION DETAILS.

- REFER TO LARGER INDIVIDUAL PLANS AND ELEVATIONS FOR ALL TYPICAL NOTES AND DIMENSIONS NOT SHOWN HERE.
- THESE COMPOSITE PLAN ARE FOR REFERENCE ONLY. REFER TO CIVIL ENGINEERS DRAWINGS FOR ALL BUILDING LOCATIONS AND PAD HEIGHTS.

FIRE PARTITION/ FIRE BARRIER LEGEND

2- HOUI SEPERA

1-HOUR FIRE RESISTIVE WALL EXTENSION, EXTERIOR SINGLE WALL - U305

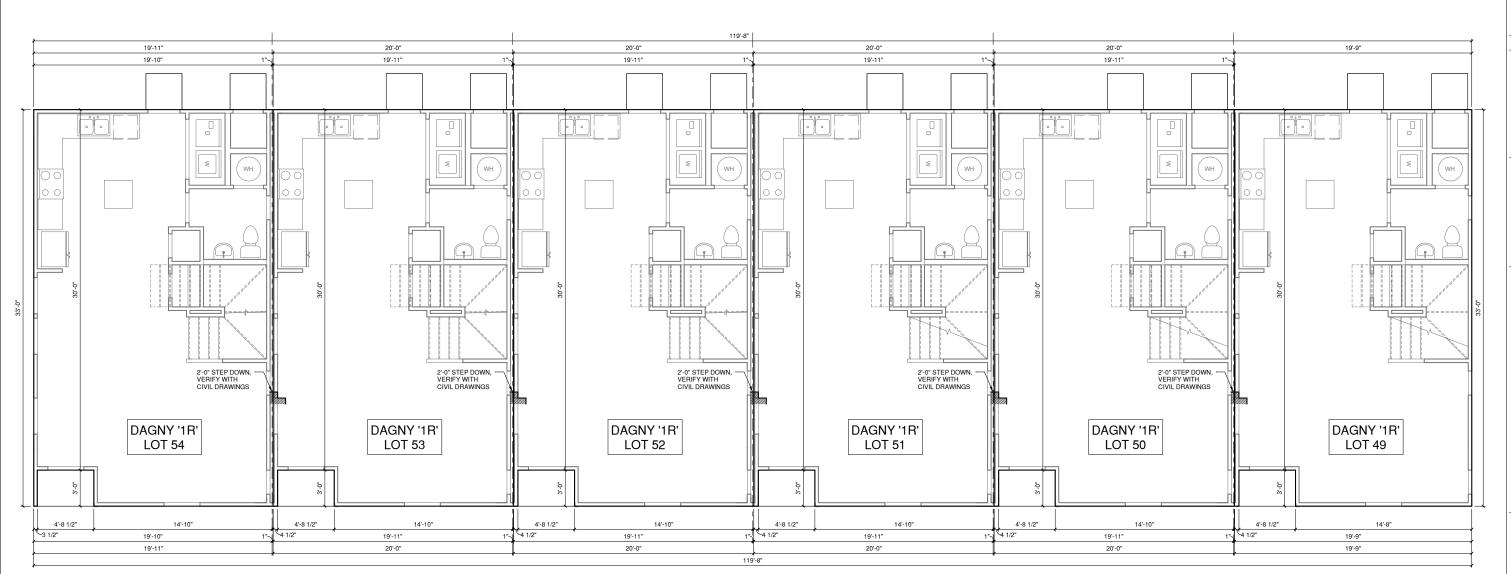



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PROFESSIONAL SEAL:

PROJECT TITLE:

DAGNY
QUACKENBUSH HOMES LLC
9220 FAIRBANKS DR SUITE 240
RALEIGH, NC 27613
919-741-7993

CONSTRUCTION SET

CLIENTS NAME:

QUACKENBUSH HOMES

PROJECT NO:

SHEET TITLE:

SLAB PERIMETER PLAN 6-PLEX

PRINT DATE:

09.19.17

SHEET NO:
A0.1

NOTES:

- REFER TO FIRE PROTECTION SHEETS FOR ALL TYPICAL FIRE PROTECTION DETAILS.

- REFER TO LARGER INDIVIDUAL PLANS AND ELEVATIONS FOR ALL TYPICAL NOTES AND DIMENSIONS NOT SHOWN HERE.
- THESE COMPOSITE PLAN ARE FOR REFERENCE ONLY. REFER TO CIVIL ENGINEERS DRAWINGS FOR ALL BUILDING LOCATIONS AND PAD HEIGHTS.

FIRE PARTITION/ FIRE BARRIER LEGEND

1-HOUR FIRE RESISTIVE WALL EXTENSION, EXTERIOR SINGLE WALL - U305



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PROFESSIONAL SEAL:

PROJECT TITLE:

DAGNY

QUACKENBUSH HOMES LLC 9220 FAIRBANKS DR SUITE 240 RALEIGH, NC 27613 919-741-7993

CONSTRUCTION SET

CLIENTS NAME:

QUACKENBUSH HOMES

PROJECT NO:


SHEET TITLE:

FIRST FLOOR PLAN 6-PLEX

> PRINT DATE: 09.19.17

SHEET NO:

A1.1

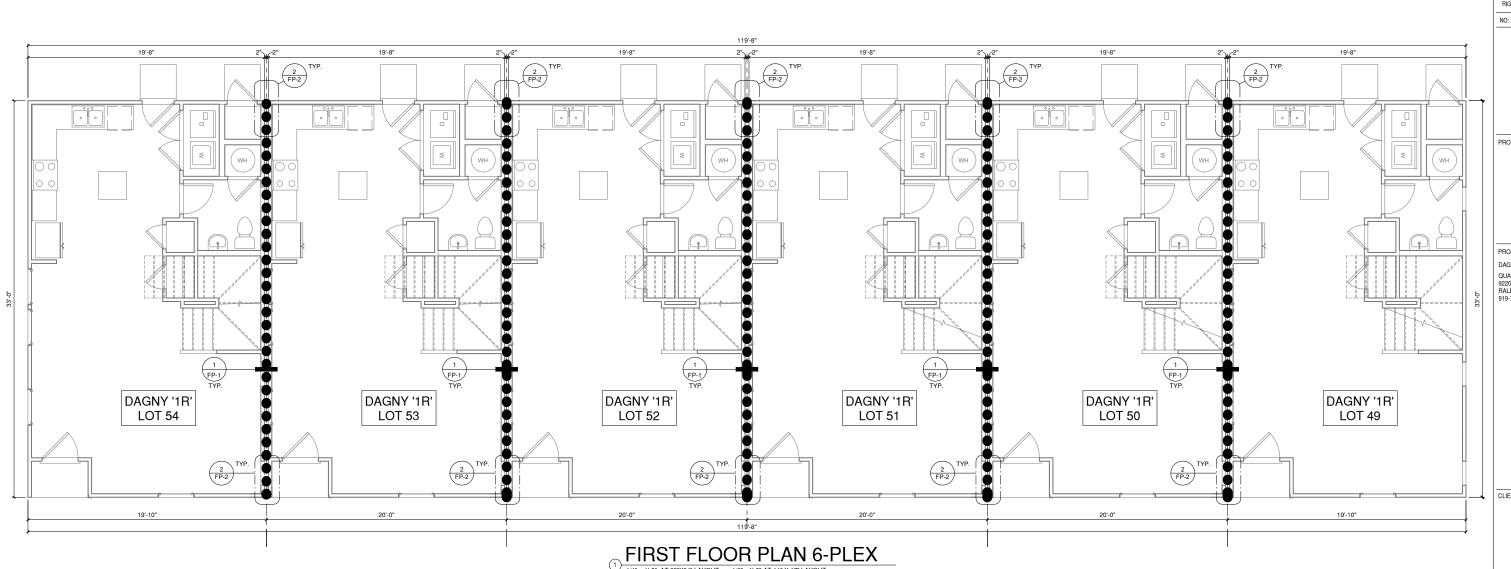

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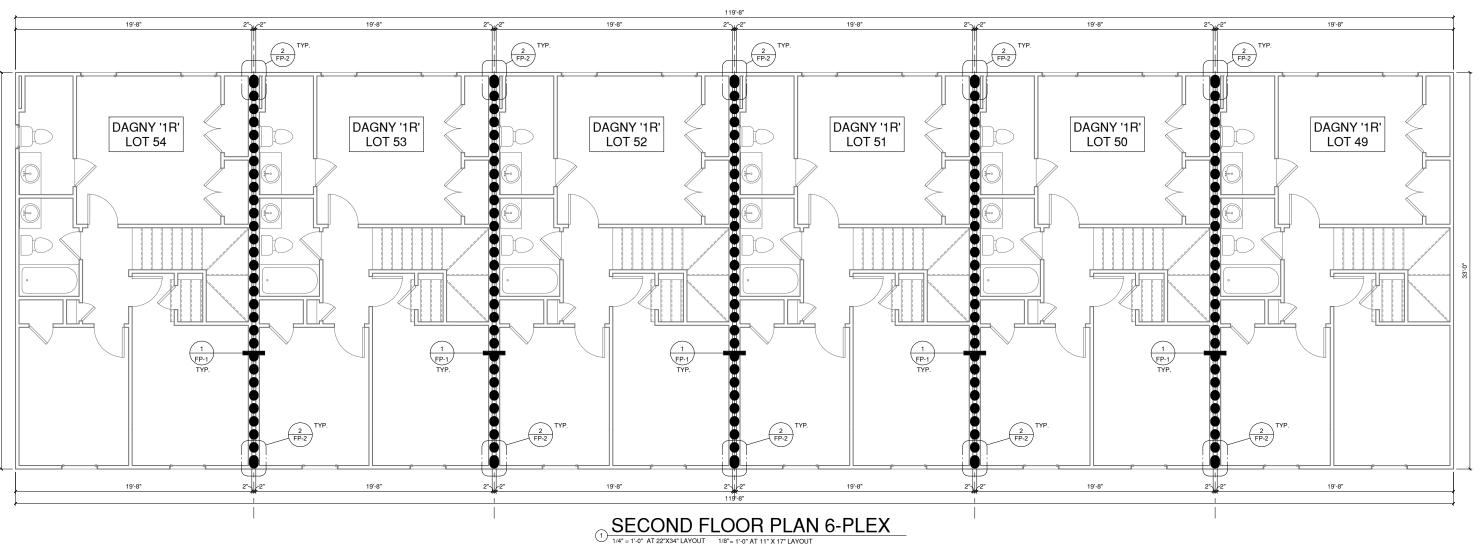
- REFER TO FIRE PROTECTION SHEETS FOR ALL TYPICAL FIRE PROTECTION DETAILS.

- REFER TO LARGER INDIVIDUAL PLANS AND ELEVATIONS FOR ALL TYPICAL NOTES AND DIMENSIONS NOT SHOWN HERE.
- THESE COMPOSITE PLAN ARE FOR REFERENCE ONLY. REFER TO CIVIL ENGINEERS DRAWINGS FOR ALL BUILDING LOCATIONS AND PAD HEIGHTS.

FIRE PARTITION/ FIRE BARRIER LEGEND

2- HOUR DWELLING SEPERATION WALL

1-HOUR FIRE RESISTIVE WALL EXTENSION, EXTERIOR SINGLE WALL - U305





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PROFESSIONAL SEAL:

PROJECT TITLE:

DAGNY

QUACKENBUSH HOMES LLC 9220 FAIRBANKS DR SUITE 240 RALEIGH, NC 27613 919-741-7993

CONSTRUCTION SET

CLIENTS NAME:

QUACKENBUSH HOMES

PROJECT NO:

SHEET TITLE:


SECOND **FLOOR PLAN** 6-PLEX

PRINT DATE:


09.19.17

SHEET NO:

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design group
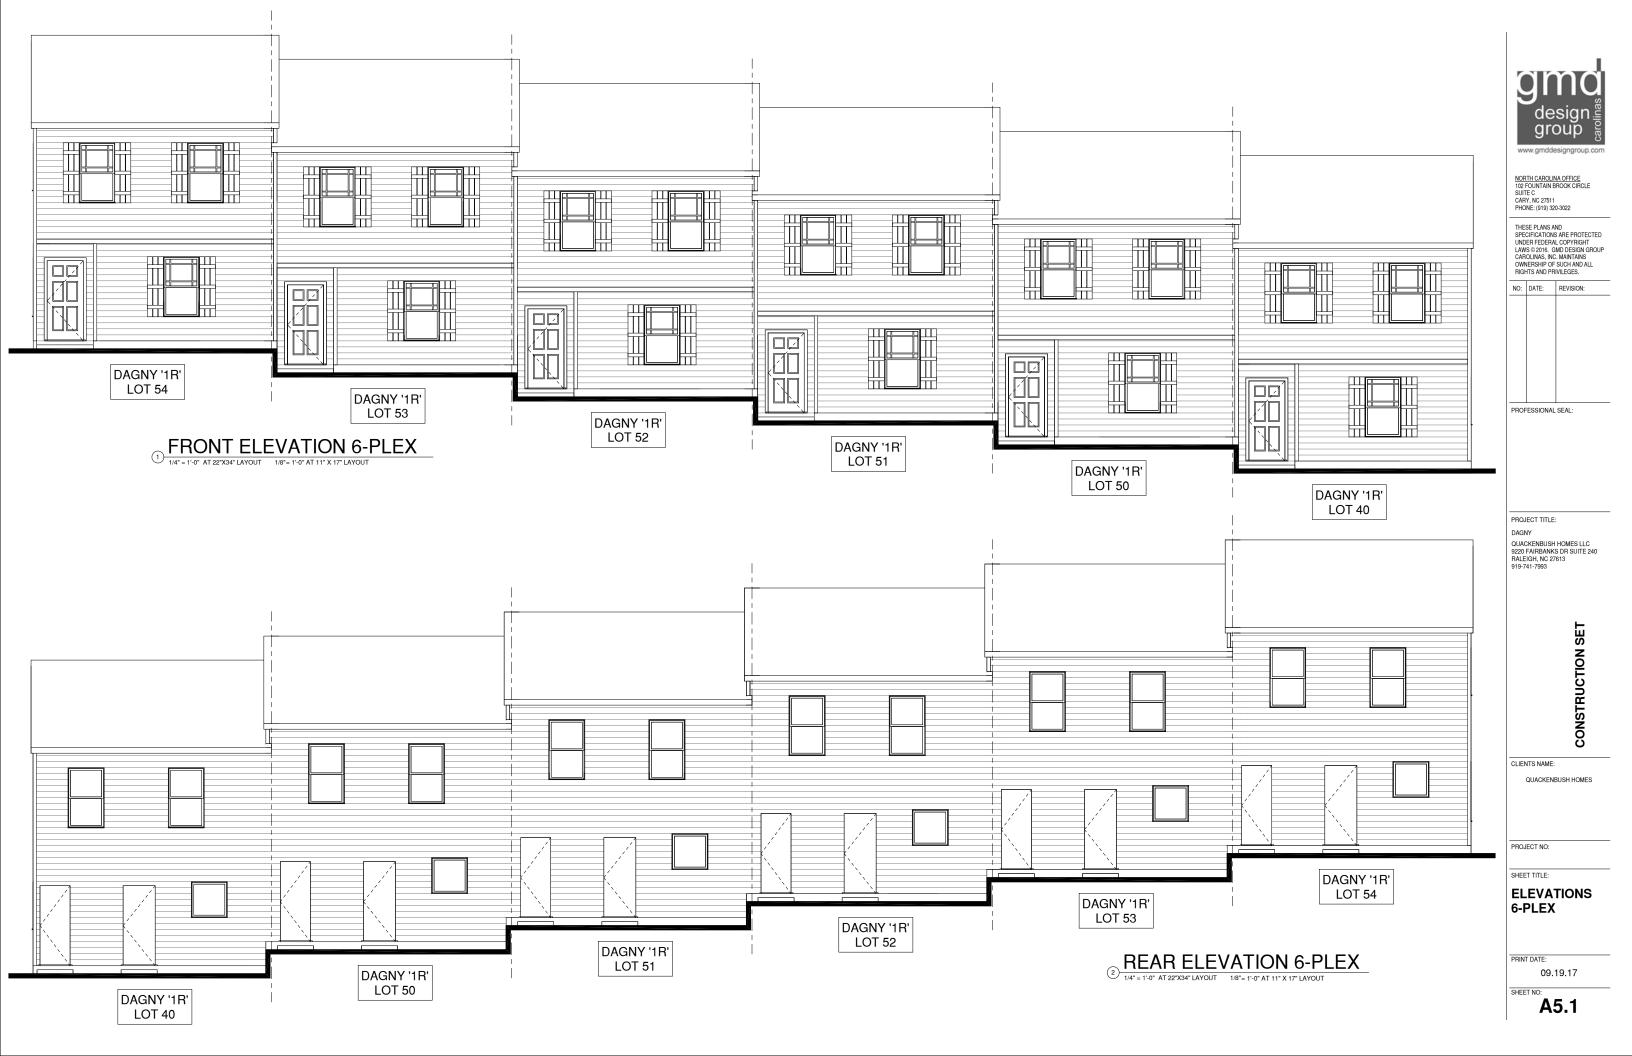
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PROFESSIONAL SEAL:

PROJECT TITLE:

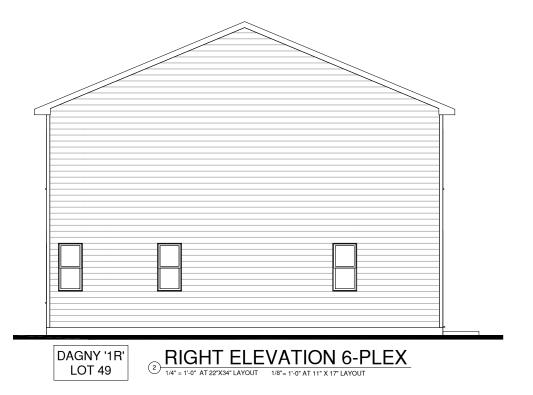DAGNY

QUACKENBUSH HOMES LLC 9220 FAIRBANKS DR SUITE 240 RALEIGH, NC 27613 919-741-7993

CONSTRUCTION SET

CLIENTS NAME: QUACKENBUSH HOMES

PROJECT NO:

SHEET TITLE:

ELEVATIONS 6-PLEX

PRINT DATE:

09.19.17

SHEET NO:

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gma design group group

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PROFESSIONAL SEAL:

PROJECT TITLE:

DAGNY QUACKENBUSH HOMES LLC 9220 FAIRBANKS DR SUITE 240 RALEIGH, NC 27613 919-741-7993

CONSTRUCTION SET

CLIENTS NAME:

QUACKENBUSH HOMES

PROJECT NO:


SHEET TITLE:

ROOF PLAN 6-PLEX

PRINT DATE:

09.19.17

A5.1.2

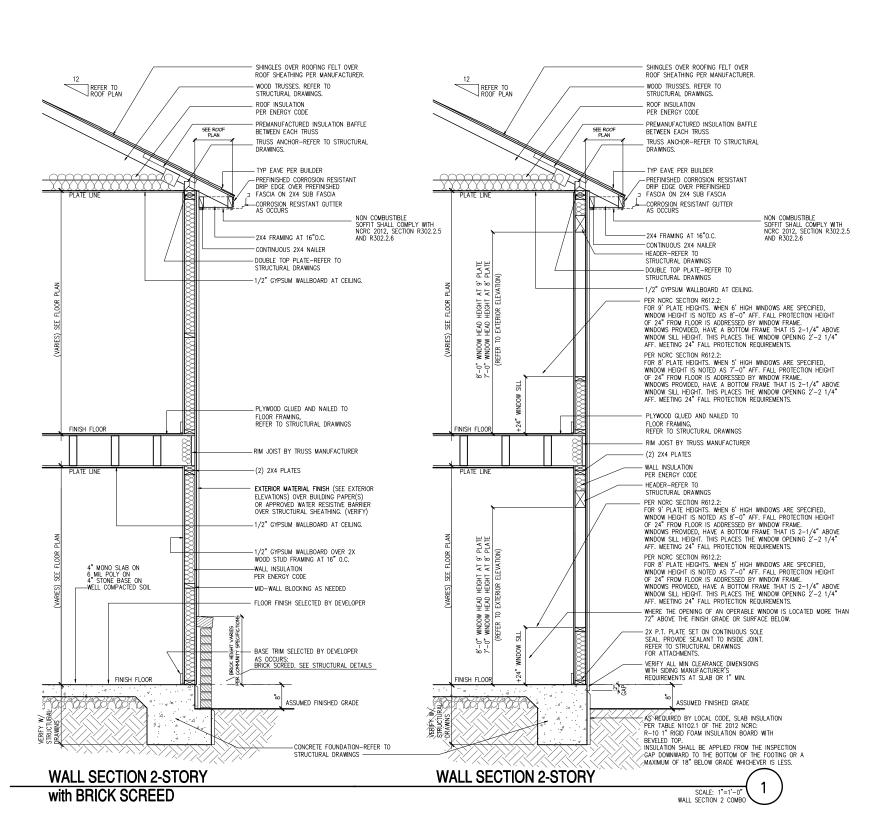



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PROFESSIONAL SEAL:

PROJECT TITLE:

FOR CONSTRUCTION

CLIENTS NAME:


PROJECT NO: SHEET TITLE:

DETAILS

INT DATE: April 1, 2016

April 1, 2


D-1

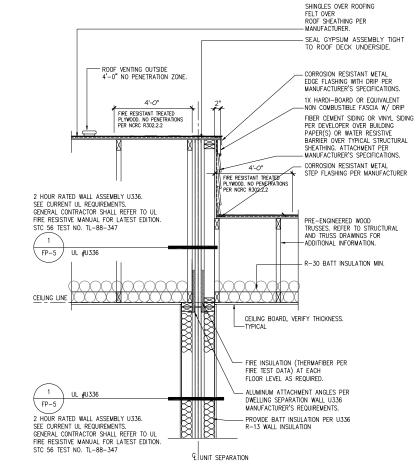

2-HOUR DWELLING SEPARATION WALL

SHAFT-U336 Roof OFF SET 2 II

AT ROOF OFF-SET (U336)

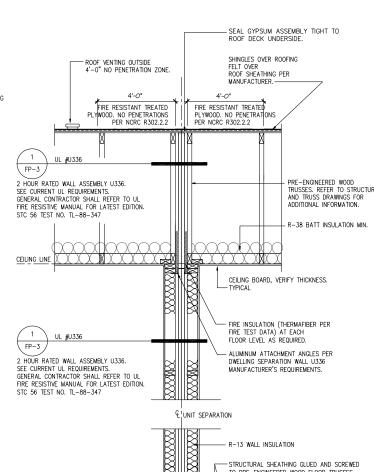

FINISH FLOOR

CEILING LINE

ON 3 OR MORE

1/4" THICK MINIMUM

CONTINUOUS CAULKING READS

group

GMD DESIGN GROUP CAROLINAS, INC. IO2 FOUNTAIN BROOK CIRCLE SUITE C CARY, NC. 27511 PHONE: (919) 320-3022

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NO: DATE: REVISION:

PROJECT TITLE:

STRUCTURAL SHEATHING GLUED AND SCREWED TO PRE-ENGINEERED WOOD FLOOR TRUSSES. REFER TO STRUCTURAL AND TRUSS DRAWINGS FOR ADDITIONAL INFORMATION NOT SHOWN HERE.

-1/2" CEILING BOARD-TYPICAL

- FIRE INSULATION (THERMAFIBER PER FIRE TEST DATA) AT EACH UL #U336 FLOOR LEVEL AS REQUIRED FP-3 2 HOUR RATED WALL ASSEMBLY U336. PROVIDE BATT INSULATION PER U336 R-13 WALL INSULATION SEE CURRENT UL REQUIREMENTS. GENERAL CONTRACTOR SHALL REFER TO UL FIRE RESISTIVE MANUAL FOR LATEST EDITION. STC 56 TEST NO. TL-88-347

2-HOUR DWELLING SEPARATION WALL

AT NON-RATED FLOOR (U336)

_MID-WALL BLOCKING AT FRAME WALLS OVER 8'-0" HIGH.


- AS REQUIRED: LEAVE GYP BD SHORT OF FLOOR AND FILL WITH 1/2" BEAD OF ACOUSTICAL SEALANT AT FINISH FLOOR, TYP ALL LEVELS. ACOUSTICAL CALLKING TO BE FOLIAL OR GREATER FIRE RESISTIVE THAN THE ASSEMBLY

SHEET TITLE: **DETAILS** CONCRETE SLAB AND FOOTING

PRINT DATE:

CLIENTS NAME

PROJECT NO:

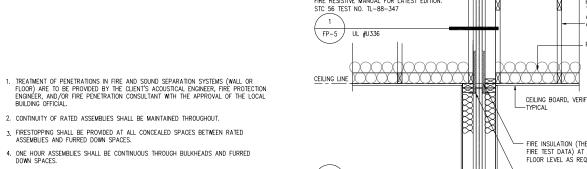

3, FIRESTOPPING SHALL BE PROVIDED AT ALL CONCEALED SPACES BETWEEN RATED ASSEMBLIES AND FURRED DOWN SPACES.

ALL ASSEMBLIES TO BE CONSTRUCTED IN STRICT ACCORDANCE WITH THE SPECIFICATIONS SET FORTH BY EACH DESIGN NUMBER LISTED.

6. ALL PENETRATIONS THROUGH RATED WALL ASEMBLIES INCLUDING BUT NOT LIMITED TO PIPING, ELECTRICAL AND OR AIR DISTRIBUTION SHALL CONFORM TO ALL LOCAL CODES.


NOTIFY ARCHITECT/BUILDER OF ANY DEVIATION FROM RATED ASSEMBLIES WHICH MAY AFFECT CONTINUITY.

8. TESTED "FIRE RATED" ASSEMBLIES MAY BE SUBSTITUTED BY THE BUILDER WITH OTHER EQUIVALENT TESTED "FIRE RATED ASSEMBLIES." SUBSTITUTIONS MUST BE APPROVED BY THE BULDING OFFICIAL PRIOR TO CONSTRUCTION.


GENERAL NOTES TH's

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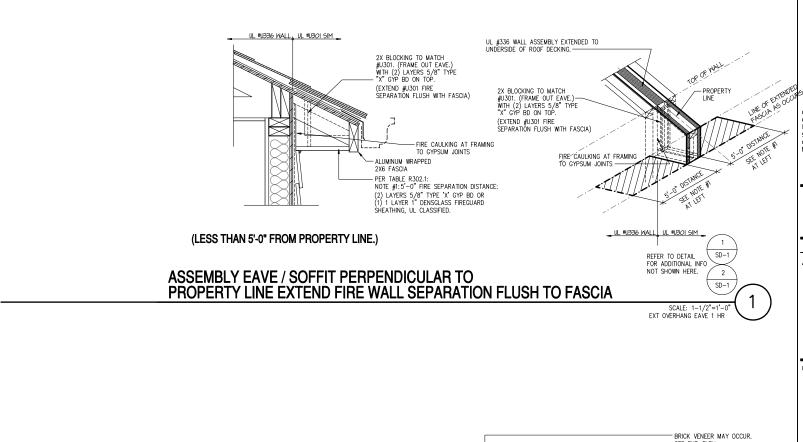
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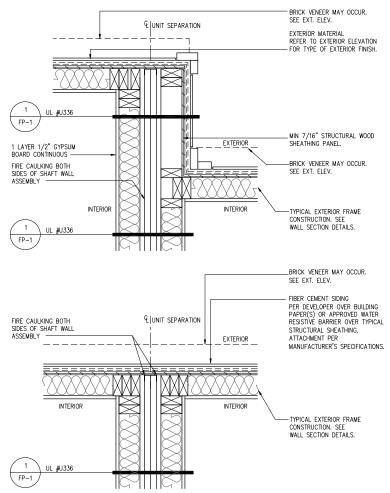




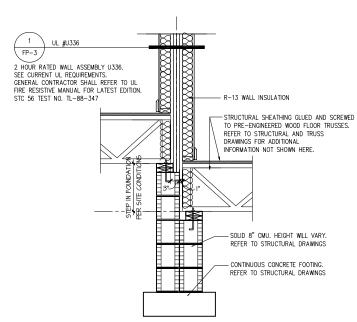

2-HOUR DWELLING SEPARATION WALL AT SLAB OFF-SET (U336)

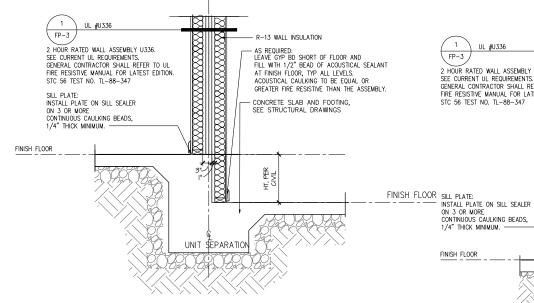



EXT. WALL INTERSECTION (U336)

SCALE: 1-1/2"=1'-0" EXT WALL 2 HR U336



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PROFESSIONAL SEA

PROJECT TITLE:

FOR CONSTRUCTION

CLIENTS NAME:

SHEET TITLE:
DETAILS

PROJECT NO:


PRINT DATE:

April 1, 2016


FP-2




GMD DESIGN GROUP CAROLINAS, INC. IO2 FOUNTAIN BROOK CIRCLE SUITE C CARY, NC. 275II PHONE: (919) 320-3022

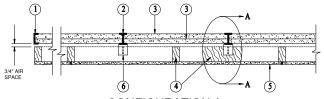


CONFIGURATION A EXPOSED TO FIRE FROM AREA SEPARATION WALL SIDE

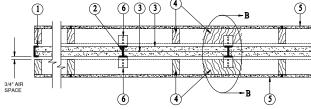


CONFIGURATION B

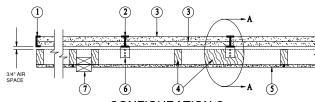


CONFIGURATION C

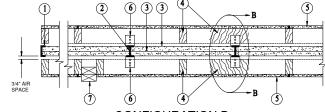

CONFIGURATION D

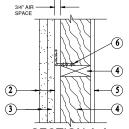

SECTION A-A

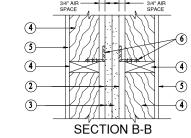

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Nonbearing Wall Rating — 2 Hour Finish Rating — 120 min

DESIGN NO. U336

Exposed to fire from separation Wall side only

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PROJECT TITLE:

1. Floor, Intermediate or Top Wall -2 in. wide channel shaped with 1 in. long legs formed from No. 25 MSG galv steel, secured with suitable fasteners spaced 24 in. OC.

2. Metal Studs — Steel members formed from No. 25 MSG galv steel having "H" -shaped flanged spaced 24 in. OC; overall depth 2 in. and flange width 1-3/8 in.

Refer to current UL report dated 06.17.14 for approved drywall vendors and type

PROTECTED WALL: (Bearing or Nonbearing Wall)

6A. Clip placement (Item 6) for separation walls up to 23 ft high. Space clips a max of 10 ft OC vertically between wood framing and

6C. Clip placement (Item 6) for separation walls up to 66 ft high: Space clips as described in Item 6A for upper 24 ft. Space clips as described in Item 6B for the next 20 ft. below the upper 24 ft. Remaining wall area below requires clips spaced a max of 40 in. OC vertically between wood framing and "H" studs.

7. Non-Bearing Wall Partition Intersection — (optional) Two nominal 2 by 4 in. stud or nominal 2 by 6 in. stud nailed together with two 3in. long 10d nails spaced a max. 16in OC. vertically and fastened to one side of the minimum 2 by 4 in. stud with 3 in. long 10d nails spaced a max in 6 in OC. vertically intersection between partitions wood studs to be flush with the 2 by 4 in. studs. The wall partition wood studs are to be framed with a second 2 by 4 in woo stud fastened with 3 in. long 10d nails spaced a max. 16 in. OC. vertically, Maximum one non-bearing wall partition intersection per stud cavity. Non-bearing wall partition stud depth shall be at a minimum equal to the depth of the wall.

REFER TO CURRENT UL APPROVED **REPORT DATED 06.17.14 FOR ALL U336 DESIGN GENERAL INFORMATION** SHOWN OR NOT SHOWN HERE.

2 HOUR RATED - NONBEARING WALL/

PROJECT NO: SHEET TITLE: **DETAILS**

April 1, 2016

FP-3

FOR CONSTRUCTION