ABBREVIATIONS	INDEX	
ABV ABOVE AC ARCONDITIONING A.D. AREA DRAM A.D. AREA DRAM A.D. AREA DRAM A.D. ALCHING B.D. ALCHING A.D. ALCHING B.D. ALCHING B.D. BELOW B.D. B.D. BELOW B.D. B.D. BELOW B.D. B.D. BELOW B.D. B.D. B.D. B.D. B.D. B.D. B.D. B.D.	A0.1.1 SL&B PLANS A0.3.1 CRAWL SPACE PLANS A1.0 UNFINSHED BASEMENT PLAN 'A' A1.0.1 FINSHED BASEMENT PLAN 'A' A1.1 FLOOR PLAN '2' A1.3 FLOOR PLAN '2' A1.4 FLOOR PLAN '3' A1.4 FLOOR PLAN '3' A1.5 FLOOR PLAN '3' A1.4 FLOOR PLAN '3' A1.5 FLOOR PLAN '3' A1.6 FLOOR PLAN '3' A1.1 SECTIONS A3.1 ELEV ATIONS '1' A5.1 ELEV OPTIONS A5.1.1 ELEV OPTIONS A5.1.2 ELEV OPTIONS A5.1.3 ELEV ATIONS '2' A5.2 ELEVATIONS '2' A5.3.1 ROOF PLAN '2' A5.2.1 ROOF PLAN '2' A5.3.1 ROOF PLAN '2' A5.3.1 ROOF PLAN '2' A5.3.1 ROOF PLAN '2' A5.4.1 ROOF PLAN '2' A5.4.1 ROOF PLAN '2' A5.4.1 ROOF PLAN '2' A5.4.1 ROOF PLAN '2' A6.5.1 BASEMENT UTILITY PLAN	CAMDEN - R PLAN 173 ELEV. 'A' AREA INSTE LOOP ILOON NUMBER FROM ILOON ELEV. 'A' AREA INSTE LOOP ILOON NUMBER FROM ILOON ELEV. 'A' AREA INSTE LOOP ILOON NUMBER FROM ILOON PLAN 175
BUILDING CODE COMPLIANCE / PROJECT INFORMATION		HEATED 1732 SF HEATED 1745 SF HEATED GARAGE 389 SF GARAGE 388 SF GARAGE GARAGE F PATIO 120 SF PATIO 120 SF PATIO 120 SF PATIO PORCH 26 SF PORCH
ALL CONSTRUCTION TO COMPLY WITH LOCAL CODES AND ORDINANCES CURRENTLY IN USE WITH THE LOCAL JURISDICTION. APPLICABLE CODES: FOLLOW ALL APPLICABLE STATE AND LOCAL CODES. 2012 NORTH CAROLINA STATE SUPPLEMENTS AND AMENDMENTS CONTRACTOR AND BUILDER SHALL REVIEW ENTIRE PLAN TO VERIFY COMFORMANCE WITH ALL CURRENT APPLICABLE CODES IN EFFECT AT TIME OF CONSTRUCTION BY USING THESE DRAWINGS FOR CONSTRUCTION IT IS UNDERSTOOD THAT CONFORMANCE WITH ALL APPLICABLE CODES IN STHE RESPONSIBILITY OF THE BUILDER AND CONTRACTOR.	ALL CONSULTANT DRAWINGS ACCOMPANYING THESE GMD DESIGN GROUP CAROLINAS, INC. DRAWINGS HAVE NOT BEEN PREPARED BY OR UNDER THE DIRECTION OF GMD DESIGN GROUPCAROLINAS, INC. GMD DESIGN GROUP CAROLINAS, INC. THEREFORE ASSUMES NO LIABILITY FOR THE COMPLETENESS OR CORRECTNESS OF THESE DRAWINGS.	UNHEATED 520 SF UNHEATED 534 SF UNHEATED OPTIONAL SF Name FINISHED BASEMENT 4551 SI STORAGE W/ FIN. BASMENT 16151 SI BASEMENT PATIO 120 SI UNFINISHED BASEMENT 636 SF
PRODUCT: SINGLE FAMILY RESIDENCE / 3 STORY TOWNHOMES		
OCCUPANCY CLASSIFICATION RESIDENTIAL R-3		
CONSTRUCTION TYPE: TYPE VB (2 HOUR DWELLING SEPARATION BETWEEN UNITS.)		
GENERAL NOTES:		BUILDER SET:
THESE DOCUMENTS ARE THE PROPERTY OF THE DESIGNER AND SHALL NOT BE COPIED, DUPLICATED, ALTERED, MODIFIED OR REVISED IN ANY WAY WITHOUT THE EXPRESSED WRITTEN APPROVAL OF THE DESIGNER.	PROVIDE BLOCKING AND/OR BACKING AT ALL TOWEL BAR, TOWEL RING AND/OR THE OWNER SHALL FURNISH ANY AND ALL REPORT TOILET PAPER HOLDER LOCATIONS, AS SHOWN PER PLAN, TYPICAL AT ALL GEOTECHNICAL ENGINEER (SOLIS REPORT), ON THI BATHROOMS AND POWDER ROOMS. VERIFY LOCATIONS AT FRAMING WALK. TO THE DESIGNER, TRUCTURAL ENGINEER, AND G	E STUDY OF THE PROPOSED SITE, THE SCOPE OF THIS SET OF PLANS IS TO PROVIDE A TRUELOERTS SET

WRITTEN APPROVAL OF THE DESIGNER. CONTRACTOR SHALL VERIFY ALL CONDITIONS AND DIMENSIONS AT THE SITE AND

ALL INCONSISTENCES SHALL BE BROUGHT TO THE ATTENTION OF THE DEVELOPER AND THE DESIGNER BEFORE PROCEEDING WITH WORK. ANY ERRORS OR OMISSIONS FOUND IN THESE DRAWINGS SHALL BE BROUGHT TO DEVELOPERS AND DESIGNERS ATTENTION IMMEDIATELY.

DO NOT SCALE DRAWINGS. WRITTEN DIMENSIONS TAKE PRECEDENCE OVER SCALED

DIMENSIONS. ALL DIMENSIONS ARE TO FACE OF STUD OR TO FACE OF FRAMING UNLESS

OTHERWISE NOTED. ALL TRUSS DRAWINGS TO BE REVIEWED AND APPROVED BY THE STRUCTURAL ENGINEER PRIOR TO ISSUANCE OF BUILDING PERMIT.

ALL OR EQUAL SUBSTITUTIONS MUST BE SUBMITTED TO AND APPROVED BY CITY BUILDING OFFICIAL PRIOR TO INSTALLATION.

ALL ANGLED PARTITIONS ARE 45 DEGREES UNLESS OTHERWISE NOTED. PROVIDE FIREBLOCKING. (PER LOCAL CODES.)

ALL ELECTRICAL AND MECHANICAL FOUIPMENT AND METERS ARE SUBJECT TO RELOCATION DUE TO FIELD CONDITIONS, CONTRACTOR TO VERIFY

BATHROOMS AND POWDER ROOMS. VERIFY LOCATIONS AT FRAMING WALK. ELASTOMERIC SHEET WATERPROOFING: FURNISH AND INSTALL ALL WATERPROOFING ECASIONERIC SHEET WATER FROUTING, FORMING AND INSTALL ALL WATE COMPLETE, 4 0 MIL, SELF-ADHERING MEMBRANE OF RUBBERIZED ASPHALT INTEGRALLY BONDED TO POLYETHYLENE SHEETING, OR EQUAL. INSTALL PER MANUFACTURE'S AND TRADE ASSOCIATION'S PRINTED

INSTALLATION INSTRUCTIONS, 6" MINIMUM LAP AT ALL ADJACENT WALL SURFACES. TO THE BEST OF THE DESIGNER'S KNOWLEDGE THESE DOCUMENTS ARE IN CONFORMANCE WITH THE REQUIREMENTS OF THE BUILDING AUTHORITIES HAVING

JUBISDICTION OVER THIS TYPE OF CONSTRUCTION AND OCCUPANCY.

SHOP DRAWING REVIEW AND DISTRIBUSTION, ALONG WITH PRODUCT SUBMITTALS, REQUESTED IN THE CONSTRUCTION DOCUMENTS, SHALL BE THE SOLE RESPONSIBILITY OF THE GENERAL CONTRACTOR, UNLESS DIRECTED OTHERWISE UNDER A SEPARATE AGREEMENT.

DEVIATIONS FROM THESE DOCUMENTS IN THE CONSTRUCTION PHASE SHALL BE REVIEWED BY THE DESIGNER AND THE OWNER PRIOR TO THE START OF WORK IN QUESTION. ANY DEVIATIONS FROM THESE DOCUMENTS WITHOUT PRIOR REVIEW, SHALL BE THE SOLE RESPONSIBILITY OF THE GENERAL CONTRACTOR.

THE GENERAL CONTRACTOR SHALL BE RESPONSIBLE FOR ALL WORK AND MATERIALS REPRESENTED ON THESE DOCUMENTS INCLUDING THE WORK AND MATERIALS FURNISHED BY SUBCONTRACTORS AND VENDORS.

GEOTECHNICAL ENGINEER (SOUS HE/POHT), ON THE STUDY OF THE PHOPOSED STIT TO THE DESIGNER, STRUCTURAL ENGINEER, AND GENERAL CONTRACTOR. IN THE EVENT THE GEOTECHNICAL REPORTS DO NOT EXIST, THE SOILS CONDITION SHALL BE ASSUMED TO BE A MINIMUM DESIGN SOLIP RESSUMES TATED BY THE STRUCTURAL REININEER OF RECORD FOR THE PURPOSE OF STRUCTURAL DESIGN. GENERAL CONTRACTOR SHALL ASSURE THE SOIL CONDITIONS MEET OR EXCEED THE CONTENT. THE CRITERIA.

ALL WORK PERFORMED BY THE GENERAL CONTRACTOR SHALL COMPLY AND CONFORM WITH LOCAL AND STATE BUILDING CODES, ORDINANCES AND REGULATIONS, ALONG WITH ALL OTHER AUTHORITIES HAVING JURISDICTION. THE GENERAL CONTRCATOR IS RESPONSIBLE TO BE AWARE OF THESE REQUIREMENTS AND GOVERNING REGULATIONS.

PROVIDE AN APPROVED WASHER DRAIN PAN AT SECOND FLOOR ONLY THAT DRAINS TO EXTERIOR.

WINDOW SUPPLIER TO VERIFY AT LEAST ONE WINDOW IN ALL BEDROOMS TO HAVE A CLEAR OPENABLE AREA OF 4.0 SO FT. THE MINIMUM HET CLEAR OPENING HEIGHT SHALL BE 22' AND THE MINIMUM INT CLEAR OPENING WIDTH SHALL BE 20' GLAUTA TOTAL AREA OF NOT LESS THAN 5.0 SQ FT IN THE CASE OF A GROUND WINDOW AND NOT LESS THAN 5.7 SQ FT IN THE

CASE OF AN UPPER STORY WINDOW. (PER NCRC SECTION R310.1.1) ALL HANDRAIL BALLUSTERS TO BE SPACED SUCH THAT A 4" SPHERE CANNOT PASS BETWEEN BALLUSTERS. (PER LOCAL CODES.) PROVIDE STAIR HANDRAILS AND GUARDRAILS PER LOCAL CODES.

THIS SET OF PLANS IS SUFFICIENT TO OBTAIN A BUILDING PERMIT; HOWEVER, ALL MATERIALS THIS SET OF PLANS IS SOFTICIENT TO US TAIL A BOLEDING PERMIT, POTIVEYER, ALE WRITEINNUS AND METHODS OF CONSTRUCTION NECESSARY TO COMPLETE THE PROJECT ARE NOT NECESSARILY DESCRIBED. THE PLANS DELINEATE AND DESCRIBE ONLY LOCATIONS, DIMENSIONS, TYPES OF MATERIALS, AND GENERAL METHODS OF ASSEMELING OR FASTENING, THEY ARE NOT INTENDED TO SPECIFY PARTICULAR PRODUCTS OR OTHER METHODS OF ANY THE FARE NOT INVESTIGATION OF THE NUMBER OF A DUDING TO DUDING THE WE HOUSD OF ANY TA SPECIFIC MATERIALS, PRODUCT OF METHOD. THE INPLEMENTATION OF THE PURS REQUIRES A CLIENT / CONTRACTOR THOROUGHLY MNOWLEDGEABLE WITH THE APPLICABLE BUILDING CODES AND METHODS OF CONSTRUCTION SPECIFIC TO THIS PRODUCT TYPE AND TYPE OF ONSTRUCTION.

AND MILETINDED OF UNDERTIGENT AND QUALITY: PROVIDE WORK OF THE SPECIFIC QUALITY: WHERE QUALITY LEVEL IS NOT INDICATED, PROVIDE WORK OF QUALITY CUSTOMARY IN SIMILAR TYPES OF WORK. WHERE THE PLANS AND SPECIFICATIONS, CODES, LWS, REGULATIONS, MANUFACTURES'S RECOMMENDATIONS OF INDUSTRY STANDARDS REQUIRE WORK OF HIGHER QUALITY OR PERFORMANCE, PROVIDE WORK COMPLYING WITH THOSE REQUIREMENTS AND QUALITY. WHERE TWO OR MORE QUALITY PROVISIONS OF THOSE REQUIREMENTS AND QUALITY. WHERE TWO OR MORE QUALITY PROVISIONS OF THOSE REQUIREMENTS AND QUALITY. WHERE TWO OR MORE QUALITY PROVISIONS OF THOSE REQUIREMENTS AND QUALITY. WHERE TWO WHERE THE DECURRENTY, WHERE REQUIREMENTS AND DUALITY. CLARIFICATION FROM THE ARCHITECT BEFORE PROCEEDING.

REVERSE

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NO:	DATE:	REVISION:
	FOOIDNAL	0541

ELEV. 'C	C' AREA
Name	Area
FLOOR	707 SF
ND FLOOR	1024 SF
Ð	1731 SF
GE	388 SF
	120 SF
н	26 SF
ATED	534 SF

ELEV. 'D	' AREA
Name	Area
FIRST FLOOR	707 SF
SECOND FLOOR	1024 SF
HEATED	1731 SF
GARAGE	388 SF
PATIO	120 SF
PORCH	26 SF
UNHEATED	534 SF

IAL SF

	Area
	455 SF
IENT	181 SF
	120 SF
Т	636 SF

PBOJECT TITLE





QUACKENBUSH

HOMES

PROJECT NO:

SHEET TITLE:

COVER SHEET

PRINT DATE:

02.12.18

SHEET NO

T-1


NOTES FOR NORTH CAROLINA:


RRIGATION SYSTEM SHALL BE DESIGNED TO PREVENT THE SATURATION OF SOIL ADJACENT TO BUILDING THIS PERIMETER DIMENSION PLAN IS FOR DIMENSIONAL INFORMATION ONLY. SLOPE ALL STOOPS AND HARDSCAPE MATERIAL AWAY FROM BUILDING - TYPICAL. SLOPE GARAGE FLOOR 1/8" PER FOOT TO GARAGE DOOR OPENING. VERIFY CURB CUT BLOCKOUT WITH GARAGE DOOR MANUFACTURER REFER TO CIVIL DRAWINGS FOR FINISH SURFACE ELEVATIONS. FINISH GRADE SHALL PROVIDE POSITIVE DRAINAGE AWAY FROM BUILDING. REFER TO SOILS REPORT FOR ANY SPECIFIC REQUIREMENTS. REFER TO STRUCTURAL DRAWINGS FOR HOLDDOWNS, FOOTING DETAILS, CURB THICKNESS, AND INFORMATION NOT SHOWN ON THIS PLAN. PLUMBING FIXTURES, VENT LOCATIONS, ETC, ARE APPROXIMATE, CONTRACTOR TO VERIFY COUNT AND LOCATION VERIFY THE SUPPLY FOR SEPARATE CONDUITS TO ANY ISLAND FOR GAS, WATER OR ELECTRIC. VERIFY ALL DOOR THRESHOLD HEIGHTS TO HARD SURFACES. 8 1/4" MAX AT INSWING DOORS. (PER NCRC SECTION R311.3.1.) TYP STOOP AT INSWING/SLIDER DOORS: 36" DEEP BY THE WIDTH OF THE DOOR SERVED, MINIMUM. (PER NCRC SECTION R311.3.) PROVIDE A SLIP-RESISTANT FINISH. FOR THE USE OF EXPOSED GAS WATER HEATERS IN THE GARAGE, PROTECT THE WATER HEATER WITH 3" DIA CONCRETE FILLED STEEL PIPE EMBEDDED INTO CONCRETE FOOTING. SOILS TREATMENT: BORACARE TERMITE TO BE APPLIED TO FRAMING PER PRODUCT SPECIFICATIONS. (PROVIDE CHEMICAL TREATMENT FOR PROTECTION FROM TERMITE INFESTATION ACCORDING TO THE STANDARDS OF THE NC DEPT OF AGRICULTURE.)

WOOD CONTACTING CONCRETE OR MASONRY OR LESS THAN CODE REQUIRED SEPARATION TO GRADE SHALL BE PRESSURE TREATED OR FOUNDATION GRADE REDWOOD. SET ALL EXTERIOR WALL SILLS IN MASTIC.

REFER TO STRUCTURAL DRAWINGS FOR ALL FOUNDATION DIMENSIONS


	FOU	NDATION KEYNOTE LEGEND
F1		LINE OF SLAB ABOVE
F2		LINE OF FRAMED WALL ABOVE

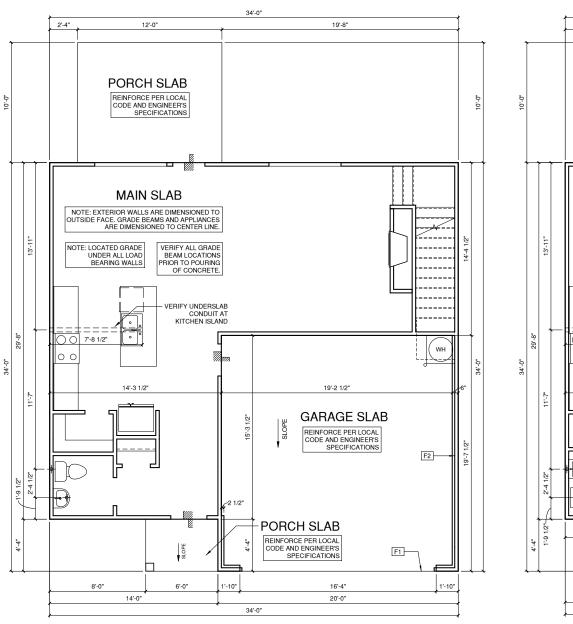

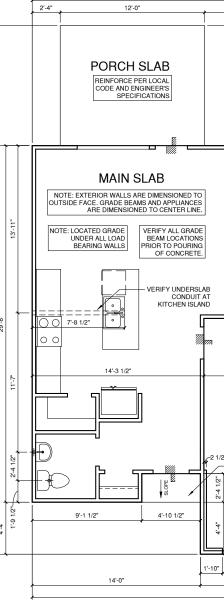

② SLAB PLAN '2', '3' & '4'

SLAB PLAN '1'

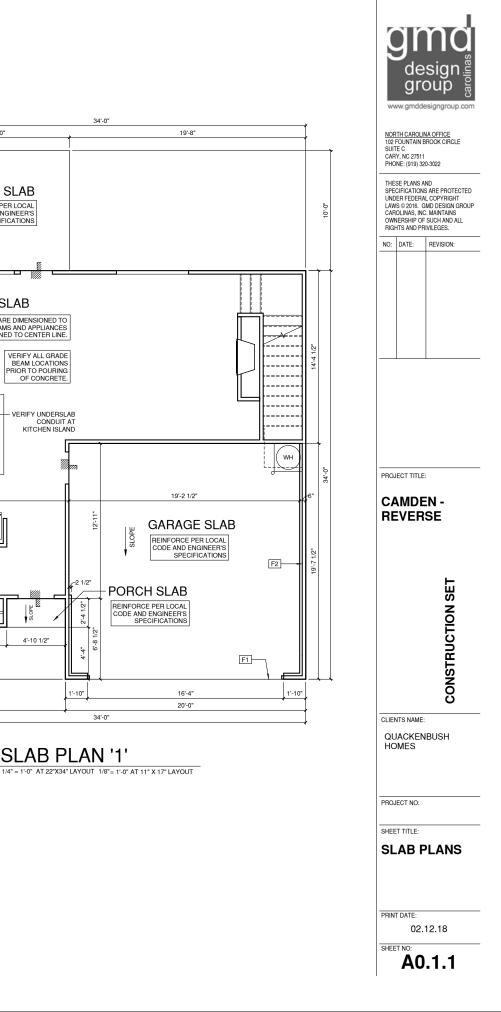

NOTES FOR NORTH CAROLINA:

IRRIGATION SYSTEM SHALL BE DESIGNED TO PREVENT THE SATURATION OF SOIL ADJACENT TO BUILDING.

THIS PERIMETER DIMENSION PLAN IS FOR DIMENSIONAL INFORMATION ONLY

SLOPE ALL STOOPS AND HARDSCAPE MATERIAL AWAY FROM BUILDING - TYPICAL.

SLOPE GARAGE FLOOR 1/8" PER FOOT TO GARAGE DOOR OPENING

VERIFY CURB CUT BLOCKOUT WITH GARAGE DOOR MANUFACTURER

REFER TO CIVIL DRAWINGS FOR FINISH SURFACE ELEVATIONS.

FINISH GRADE SHALL PROVIDE POSITIVE DRAINAGE AWAY FROM BUILDING. REFER TO SOILS REPORT FOR ANY SPECIFIC REQUIREMENTS.

REFER TO STRUCTURAL DRAWINGS FOR HOLDDOWNS, FOOTING DETAILS, CURB THICKNESS, AND INFORMATION NOT SHOWN ON THIS PLAN.

PLUMBING FIXTURES, VENT LOCATIONS, ETC. ARE APPROXIMATE. CONTRACTOR TO VERIFY COUNT AND LOCATION.

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TYP STOOP AT INSWING/SLIDER DOORS: 36" DEEP BY THE WIDTH OF THE DOOR SERVED, MINIMUM. (PER NCRC SECTION R311.3.) PROVIDE A SLIP-RESISTANT FINISH.


FOR THE USE OF EXPOSED GAS WATER HEATERS IN THE GARAGE, PROTECT THE WATER HEATER WITH 3" DIA CONCRETE FILLED STEEL PIPE EMBEDDED INTO CONCRETE FOOTING.

SOILS TREATMENT SOILS THEATMENT: BORACARE TERMITE TO BE APPLIED TO FRAMING PER PRODUCT SPECIFICATIONS. (PROVIDE CHEMICAL TREATMENT FOR PROTECTION FROM TERMITE INFESTATION ACCORDING TO THE STANDARDS OF THE NC DEPT OF AGRICULTURE.)


WOOD CONTACTING CONCRETE OR MASONRY OR LESS THAN CODE REQUIRED SEPARATION TO GRADE SHALL BE PRESSURE TREATED OR FOUNDATION GRADE REDWOOD. SET ALL EXTERIOR WALL SILLS IN MASTIC.

REFER TO STRUCTURAL DRAWINGS FOR ALL FOUNDATION DIMENSIONS

FOUNDATION KEYNOTE LEGEND			
1		LINE OF SLAB ABOVE	
2		LINE OF FRAMED WALL ABOVE	

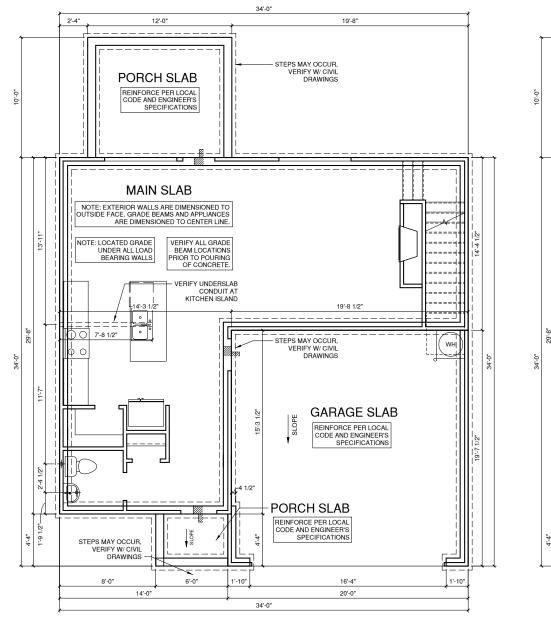

² STEMWALL PLAN '2', '3' & '4' 1/4" = 1'-0" AT 22"X34" LAYOUT 1/8" = 1'-0" AT 11" X 17" LAYOUT

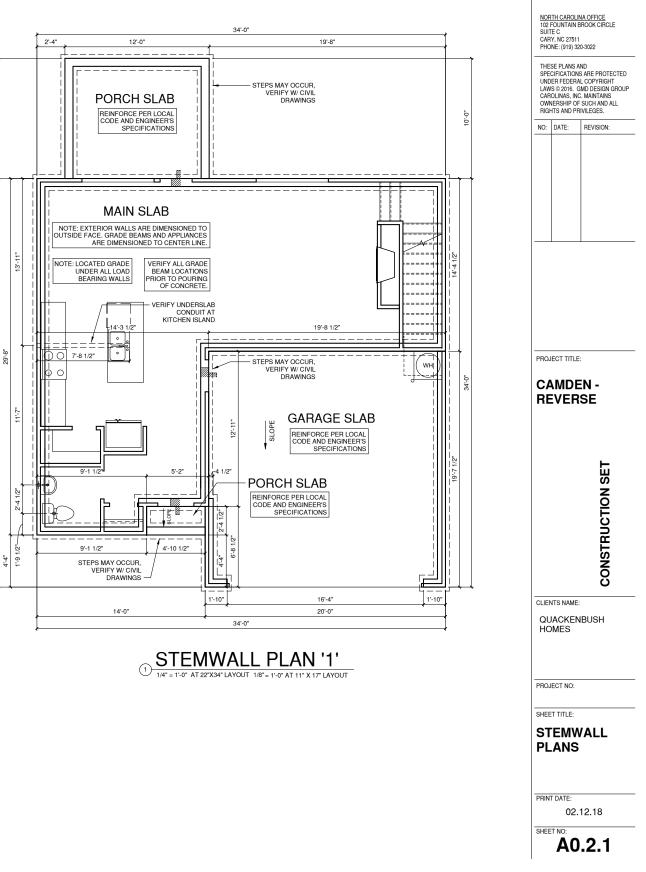

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CRAWL SPACE NOTES FOR NORTH CAROLINA:

BEEER TO STRUCTURAL DRAWINGS FOR INFORMATION NOT SHOWN ON THIS PLAN.

FOR ADDITIONAL NOTES SEE GENERAL NOTES ON TITLE SHEET AND DETAILS.

PROVIDE FIREBLOCKING. (PER NCRC SECTION R602.8)

-ALL ELECTRICAL AND MECHANICAL EQUIPMENT AND METERS ARE SUBJECT TO RELOCATION DUE TO FIELD CONDITIONS, CONTRACTOR TO VERIFY.

-VERIFY ALL DOOR THRESHOLD HEIGHTS TO HARD S URFACES 8 1/4" MAX AT INSWING DOORS. (PER NCRC SECTION R311.3.1)

SLOPE ALL STOOPS AND HARDSCAPE MATERIAL AWAY FROM BUILDING - TYPICAL.

SLOPE GARAGE FLOOR 1/8" PER FOOT TO GARAGE DOOR OPENING.

VERIFY CURB CUT BLOCKOUT WITH GARAGE DOOR MANUFACTURER

REFER TO CIVIL DRAWINGS FOR FINISH SURFACE ELEVATIONS.

-TYP. STOOP AT INSWING/SLIDER DOORS: 36" DEEP BY THE WIDTH OF THE DOOR SERVED, NIMUM (PER NCRC SECTIONS R311.3) PROVIDE A SLIP-RESISTANT FINISH

-SOILS TREATMENT: BORACARE TERMITE TO BE APPLIED TO FRAMING PER PRODUCT SPECIFICATIONS. (PROVIDE CHEMICAL TREATMENT FOR PROTECTION FROM TERMITE INVESTATION ACCORDING TO THE STANDARDS OF THE NC DEPT. OF AGRICULTURE.)

-AT VENTED CRAWL SPACE: APPLY AN APPROVED VAPOR RETARDER OR EQUIVALENT, 6 MIL POLY-VINYL, GROUND COVER OVER FINISH GRADE OR CRAWL SPACE PER NCRC SECTION 408.2

PROVIDE VENTS SPACED ABOUND PERIMETER TO PROMOTE CROSS VENTILATION AT A BATE OF 1 SE VENT FOR EVERY 1500 SE OF CRAWL FLOOR AREA. ONE VENT MUST BE LOCATED WITHIN 3-0" OF EACH CORNER OF THE BUILDING AND LOCATED TO ALLOW FOR CROSS VENTILATION. (PER NCRC SECTION R408.1.1 EXCEPTION.)


PROVIDE AN ACCESS OPENING, MINIMUM SIZE OF 18"X24" FOR CRAWL ACCESS. COORDINATE WITH MECHANICAL CONTRACTOR FOR ARGER SIZE REQUIREMENTS IF MECHANICAL EQUIPMENT IS LOCATED IN CRAWL. (PER NCRC SECTION 408.8)

-WOOD CONTACTING CONCRETE OR MASONRY OR LESS THAN CODE REQUIRED SEPARATION TO GRADE SHALL BE PRESSURE TREATED OR FOUNDATION GRADE REDWOOD. SET ALL EXTERIOR WALL SILLS IN MASTIC.

REFER TO STRUCTURAL DRAWINGS FOR ALL FOUNDATION DIMENSIONS

FOUNDATION KEYNOTE LEGEND

LINE OF SLAB ABOVE	
LINE OF FRAMED WALL	

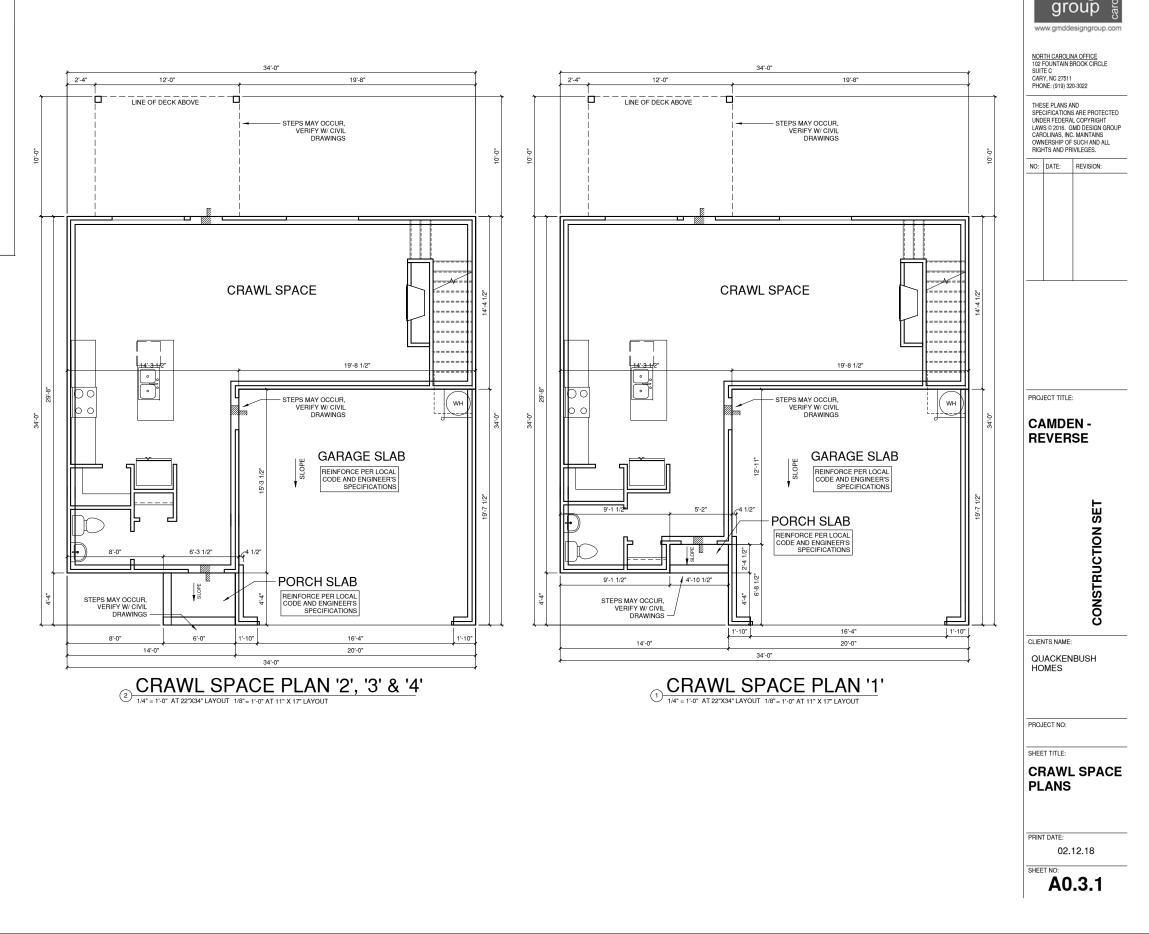

qr

design

BASEMENT NOTES FOR NORTH CAROLINA:

ALL ANGLED PARTITIONS ARE 45 DEGREES UNLESS OTHERWISE NOTED.

FOR ADDITIONAL NOTES SEE GENERAL NOTES ON TITLE SHEET AND DETAILS.

-WINDOW HEAD HTS: BASEMENT = 6'-8" U.N.O. ON ELEVATIONS

PROVIDE FIREBLOCKING. (PER NCRC SECTION R602.8)

-WINDOW SUPPLIER TO VERIFY AT LEAST ONE WINDOW IN ALL BEDROOMS TO HAVE A CLEAR OPENABLE AREA OF 4.0 SQ FT. THE MINIMUM NET CLEAR OPENING HEIGHT SHALL BE 22" AND THE MINIMUM NET CLEAR OPENING WIDTH SHALL BE 20". GLAZING TOTAL AREA OF NOT LESS THAN 5.0 SQ FT IN THE CASE OF A GROUND WINDOW AND NOT LESS THAN 5.7 SQ FTIN THE CASE OF AN UPPER STORY WINDOW (PER NCRO SECTION R301.1.1)

ALL ELECTRICAL AND MECHANICAL EQUIPMENT AND METERS ARE SUBJECT TO RELOCATION DUE TO FIELD CONDITIONS, CONTRACTOR TO VERIFY

-REFER TO STRUCTURAL DRAWINGS FOR INFORMATION NOT SHOWN ON THIS PLAN.

-VERIFY ALL DOOR THRESHOLD HEIGHTS TO HARD SURFACES. 8 1/4" MAX AT INSWING DOORS. (PER NCRC SECTIONR311.3.1)

SLOPE ALL STOOPS AND HARDSCAPE MATERIAL AWAY FROM BUILDING - TYPICAL.

-SLOPE GARAGE FLOOR 1/8" PER FOOT TO GARAGE DOOR OPENING.

-VERIFY CURB CUT BLOCKOUT WITH GARAGE DOOR MANUFACTURER.

REFER TO CIVIL DRAWINGS FOR FINISH SURFACE ELEVATIONS.

-TYP. STOOP AT INSWING/SLIDER DOORS: 36" DEEP BY THE WIDTH OF THE DOOR SERVED, MINIMUM (PER NCRC SECTIONS R311.3) PROVIDE A SLIP-RESISTANT FINISH.

SOILS TREATMENT: BORACARE TERMITE TO BE APPLIED TO FRAMING PER PRODUCT SPECIFICATIONS. (PROVIDE CHEMICAL TREATMENT FOR PROTECTION FROM TERMITE INVESTATION ACCORDING TO THE STANDARDS OF THE NC DEPT. OF AGRICULTURE.)

-WOOD CONTACTING CONCRETE OR MASONRY OR LESS THAN CODE REQUIRED SEPERATION TO GRADE SHALL BE PRESSURE TREATED OR FOUNDATION GRADE REDWOOD. SET ALL EXTERIOR WALL SILLS IN MASTIC.

WALL LEGEND

FULL HEIGHT 2X4 WOOD STUD PARTITION	FULL HEIGHT 2X6 WOOD STUD PARTITION
STONE VENEER	EEEEE DRYWALL OPENING HEIGHT AS NOTED ON PLAN
BRICK VENEER	
STUD WALL BELOW HEIGHT AND STUD SIZE AS N	OTED

FOUNDATION KEYNOTE LEGEND

LINE OF SLAB ABOVE
LINE OF FRAMED WALL ABOVE

HOUSE TO GARAGE FIRE SEPARATION, GARAGE/HOUSE SEPARATION AT VERTICAL SURFACES SHALL BI PROTECTED WITH ONE (1) LAYER 1/2" GYPSUM BOARD. GARAGE/HOUSE SEPARATION AT HORIZONTAL SURFACES SHALL BE PROTECTED WITH ONE (1) LAYER 5/8" TYPE "X" GYPSUM BOARD HOUSE TO GARAGE DOOR SEPARATION. PROVIDE 1 3/8" SOLID CORE DOOR OR APPROVED 20 MINUTE RATED DOOR GAS WATER HEATER ON 18" HIGH PLATFORM


PRE-FABRICATED METAL FIREPLACE, INSTALL PER MANUFACTURER WRITTEN INSTRUCTIONS TEMPERED SAFETY GLASS


HALF WALL, HEIGHT AS NOTED

INTERIOR SOFTIS: FLE 8-11 U.N.O. SFL = 7-6' U.N.O., OPT. CASED OPENING U.N.O. SHOWER, TEMPERED GLASS ENCLOSURE

TUB-SHOWER COMBO SLIDE-IN ELECTRICAL RANGE W/ HOOD AND MICRO ABV. VENT PER MANUFACTURER'S WRITTEN

ACCESS HATCH/DOOR. FULLY WEATHER STRIPPED AND INSULATED. (PER NCRC SECTION N1102.2.3)

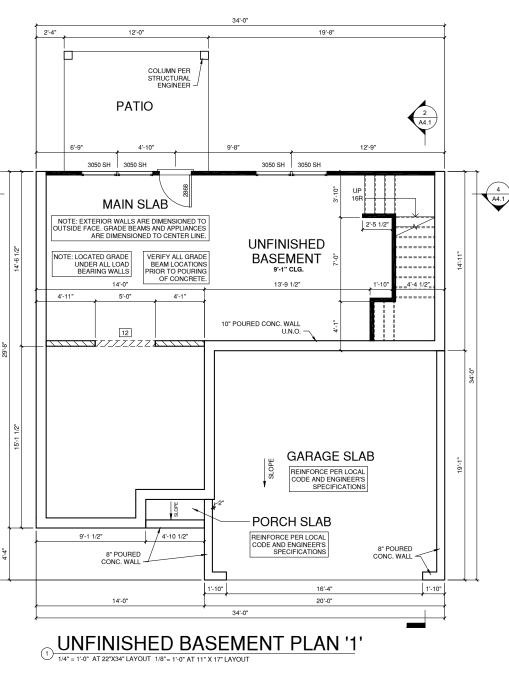

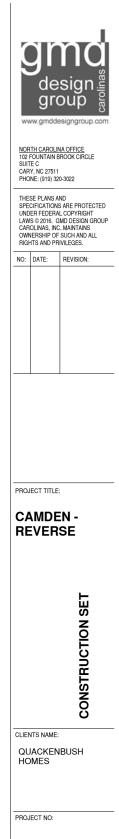

SHEET TITLE:

UNFINISHED BASEMENT PLAN 'A'

PRINT DATE:

SHEET NO

02.12.18

A1.0

BASEMENT NOTES FOR NORTH CAROLINA:

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PROVIDE FIREBLOCKING. (PER NCRC SECTION R602.8)

STORY WINDOW (PER NCRC SECTION R301.1.1)

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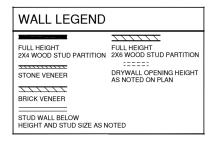
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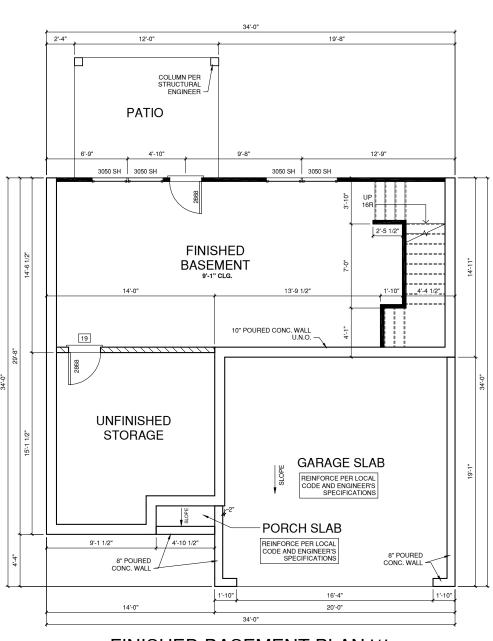
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REFER TO STRUCTURAL DRAWINGS FOR ALL FOUNDATION DIMENSIONS




FOUNDATION KEYNOTE LEGEND LINE OF SLAB ABOVE LINE OF FRAMED WALL ABOVE

	FLOOR PLAN KEYNOTE LEGEND
1	HOUSE TO GARAGE FIRE SEPARATION, GARAGE/HOUSE SEPARATION AT VERTICAL SURFACES SHALL B PROTECTED WITH ONE (1) LAYER 1/2" GYPSUM BOARD, GARAGE/HOUSE SEPARATION AT HORIZONTAL SURFACES SHALL BE PROTECTED WITH ONE (1) LAYER 5/8" TYPE "X" GYPSUM BOARD
2	HOUSE TO GARAGE DOOR SEPARATION. PROVIDE 1 3/8" SOLID CORE DOOR OR APPROVED 20 MINUTE RATED DOOR
4	GAS WATER HEATER ON 18" HIGH PLATFORM
7	PRE-FABRICATED METAL FIREPLACE, INSTALL PER MANUFACTURER WRITTEN INSTRUCTIONS
9	TEMPERED SAFETY GLASS
11	HALF WALL, HEIGHT AS NOTED
12	INTERIOR SOFFITS: FFL = 8'-1" U.N.O. SFL = 7'-6" U.N.O., OPT. CASED OPENING U.N.O.
13	SHOWER, TEMPERED GLASS ENCLOSURE
14	TUB-SHOWER COMBO
16	SLIDE-IN ELECTRICAL RANGE W/ HOOD AND MICRO ABV. VENT PER MANUFACTURER'S WRITTEN INSTRUCTIONS
19	ACCESS HATCH/DOOR. FULLY WEATHER STRIPPED AND INSULATED. (PER NCRC SECTION N1102.2.3)



FINISHED BASEMENT PLAN '1 1/4" = 1'-0" AT 22"X34" LAYOUT 1/8" = 1'-0" AT 11" X 17" LAYOUT



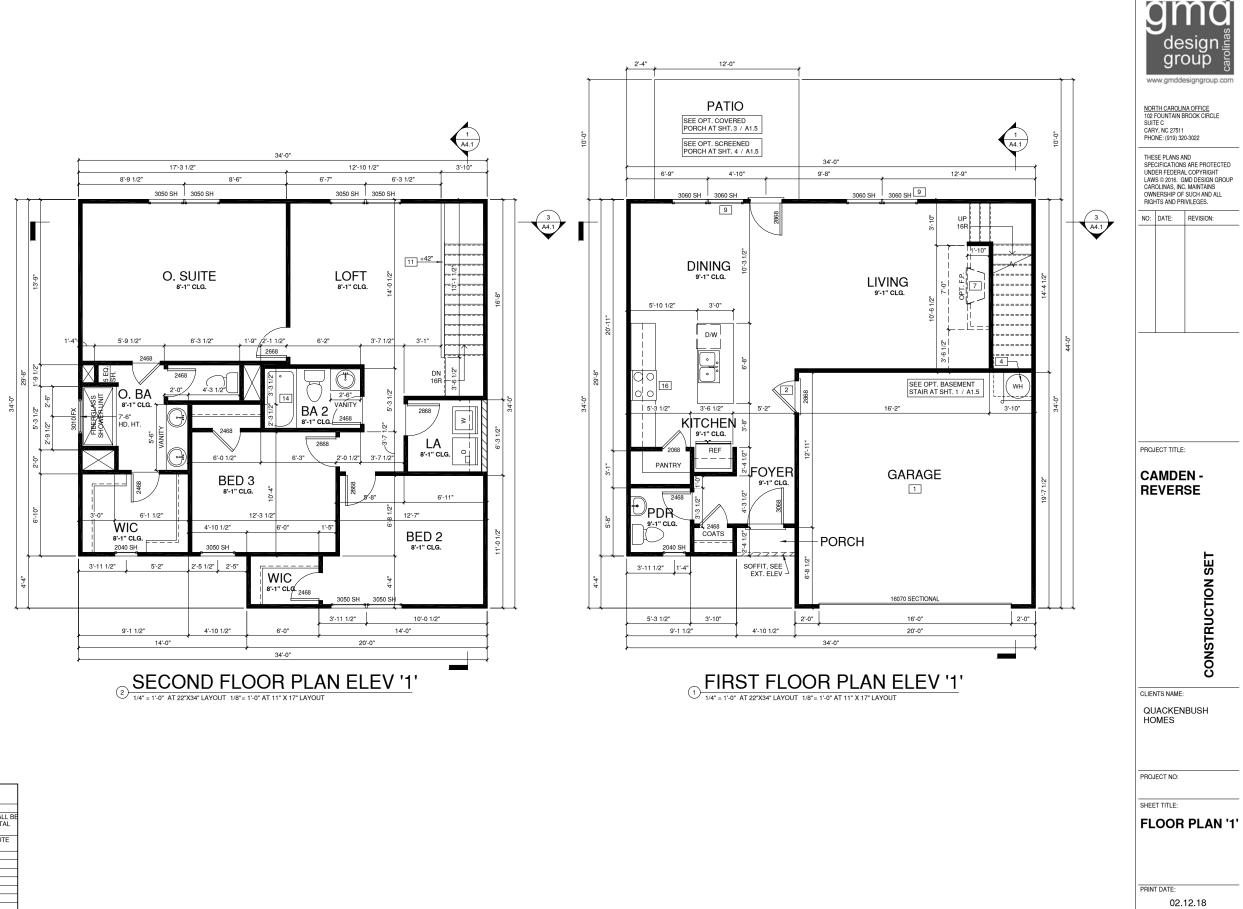


WALL LEGEND

FULL HEIGHT 2X4 WOOD STUD PARTITION	FULL HEIGHT 2X6 WOOD STUD PARTITION
STONE VENEER	DRYWALL OPENING HEIGHT AS NOTED ON PLAN
BRICK VENEER	
STUD WALL BELOW HEIGHT AND STUD SIZE AS N	OTED


FLOOR PLAN KEYNOTE LEGEND

1	HOUSE TO GARAGE FIRE SEPARATION, GARAGE/HOUSE SEPARATION AT VERTICAL SUPRACES SHALL BE PROTECTED WITH ONE (1) LAYER 1/2" GYPSUM BOARD. GARAGE/HOUSE SEPARATION AT HORIZONTAL SURFACES SHALL BE PROTECTED WITH ONE (1) LAYER 3/8" TYPE "X" GYPSUM BOARD
2	HOUSE TO GARAGE DOOR SEPARATION. PROVIDE 1 3/8" SOLID CORE DOOR OR APPROVED 20 MINUTE RATED DOOR
4	GAS WATER HEATER ON 18" HIGH PLATFORM
7	PRE-FABRICATED METAL FIREPLACE, INSTALL PER MANUFACTURER WRITTEN INSTRUCTIONS
9	TEMPERED SAFETY GLASS
11	HALF WALL, HEIGHT AS NOTED
12	INTERIOR SOFFITS: FFL = 8'-1" U.N.O. SFL = 7'-6" U.N.O., OPT. CASED OPENING U.N.O.
13	SHOWER, TEMPERED GLASS ENCLOSURE
14	TUB-SHOWER COMBO
16	SLIDE-IN ELECTRICAL RANGE W/ HOOD AND MICRO ABV. VENT PER MANUFACTURER'S WRITTEN INSTRUCTIONS
19	ACCESS HATCH/DOOR. FULLY WEATHER STRIPPED AND INSULATED. (PER NCRC SECTION N1102.2.3)

SHEET NO:

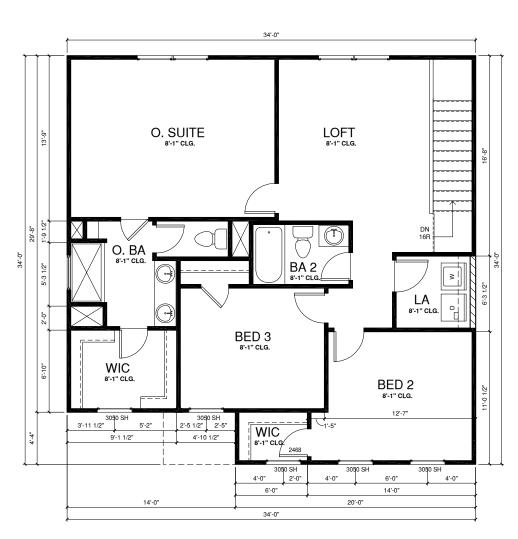



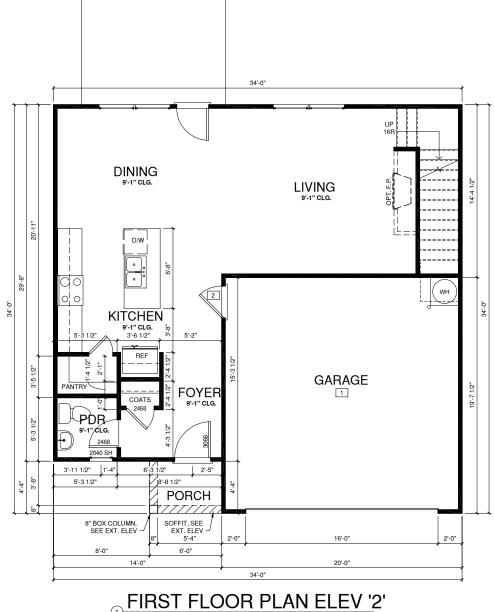

WALL LEGEND FULL HEIGHT FULL HEIGHT 2X4 WOOD STUD PARTITION 2X6 WOOD STUD PARTITION

STONE VENEER	DRYWALL OPENING HEIGHT AS NOTED ON PLAN
BRICK VENEER	
STUD WALL BELOW HEIGHT AND STUD SIZE	AS NOTED

FLOOR PLAN KEYNOTE LEGEND

- HOUSE TO GARAGE FIRE SEPARATION, GARAGE/HOUSE SEPARATION AT VERTICAL SURFACES SHALL BE PROTECTED WITH ONE (1) LAYER 1/2' GYPSUM BOARD, GARAGE/HOUSE SEPARATION AT HORIZONTAL SURFACES SHALL BE PROTECTED WITH ONE (1) LAYER 5/8' TYPE 'X' GYPSUM BOARD

 HOUSE TO GARAGE DOOR SEPARATION, PROVIDE 1 3/8' SOLID CORE DOOR OR APPROVED 20 MINUTE RATED DOOR

 GAS WATER HEATER ON 18' HIGH PLATFORM

 PRE-FABRICATED METAL FIREPLACE, INSTALL PER MANUFACTURER WRITTEN INSTRUCTIONS

 TEMPERED SAFETY GLASS

 HALF WALL, HEIGHT AS NOTED

 2

 2

 3

 SHOWER, TEMPERED GLASS ENCLOSURE

 1

 3

 SLIDE/IN ELECTRICAL RANGE W/ HOOD AND MICRO ABV, VENT PER MANUFACTURER'S WRITTEN

- SLIDE-IN ELECTRICAL RANGE W/ HOOD AND MICRO ABV. VENT PER MANUFACTURER'S WRITTEN INSTRUCTIONS
- ACCESS HATCH/DOOR. FULLY WEATHER STRIPPED AND INSULATED. (PER NCRC SECTION N1102.2.3)



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CLIENTS NAME: QUACKENBUSH HOMES

PROJECT NO:

SHEET TITLE:

PRINT DATE:

SHEET NO:


FLOOR PLAN '2'


02.12.18

A1.2



1/4" = 1'-0" AT 22"X34" LAYOUT 1/8"= 1'-0" AT 11" X 17" LAYOUT

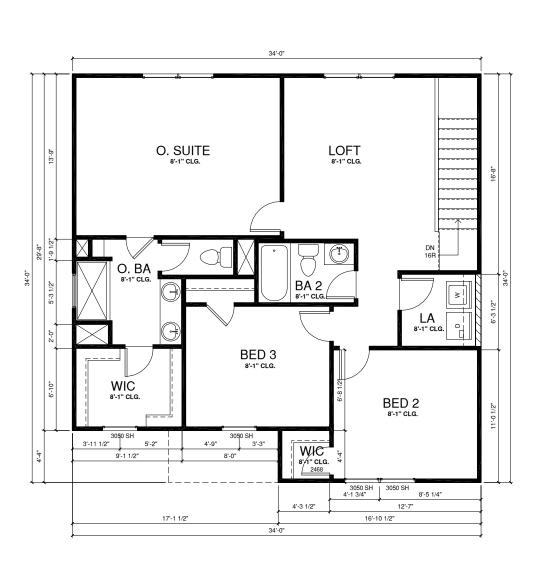

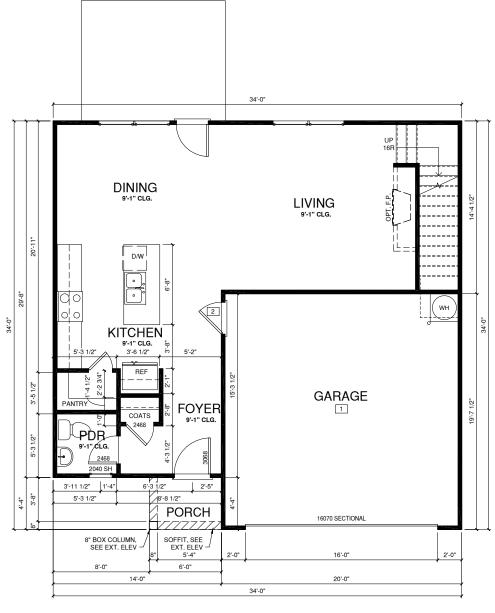

WALL LEGEND

FULL HEIGHT 2X4 WOOD STUD PARTITION	FULL HEIGHT 2X6 WOOD STUD PARTITION
STONE VENEER	ETTEE DRYWALL OPENING HEIGHT AS NOTED ON PLAN
BRICK VENEER	
STUD WALL BELOW HEIGHT AND STUD SIZE AS N	OTED

(2) SECOND FLOOR PLAN ELEV '3'


FLOOR PLAN KEYNOTE LEGEND

1	HOUSE TO GARAGE FIRE SEPARATION, GARAGE/HOUSE SEPARATION AT VERTICAL SUPRACES SHALL BE PROTECTED WITH ONE (1) LAYER 1/2' GYPSUM BOARD. GARAGE/HOUSE SEPARATION AT HORIZONTAL SURFACES SHALL BE PROTECTED WITH ONE (1) LAYER 5/8' TVPE "X' GYPSUM BOARD
2	HOUSE TO GARAGE DOOR SEPARATION. PROVIDE 1 3/8" SOLID CORE DOOR OR APPROVED 20 MINUTE RATED DOOR
4	GAS WATER HEATER ON 18" HIGH PLATFORM
7	PRE-FABRICATED METAL FIREPLACE, INSTALL PER MANUFACTURER WRITTEN INSTRUCTIONS
9	TEMPERED SAFETY GLASS
11	HALF WALL, HEIGHT AS NOTED
12	INTERIOR SOFFITS: FFL = 8'-1" U.N.O. SFL = 7'-6" U.N.O., OPT. CASED OPENING U.N.O.
13	SHOWER, TEMPERED GLASS ENCLOSURE
14	TUB-SHOWER COMBO
16	SLIDE-IN ELECTRICAL RANGE W/ HOOD AND MICRO ABV. VENT PER MANUFACTURER'S WRITTEN INSTRUCTIONS
19	ACCESS HATCH/DOOR. FULLY WEATHER STRIPPED AND INSULATED. (PER NCRC SECTION N1102.2.3)



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PRINT DATE:

SHEET NO:

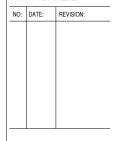FLOOR PLAN '3'

02.12.18


A1.3





QUACKENBUSH HOMES

(1) FIRST FLOOR PLAN ELEV '3'

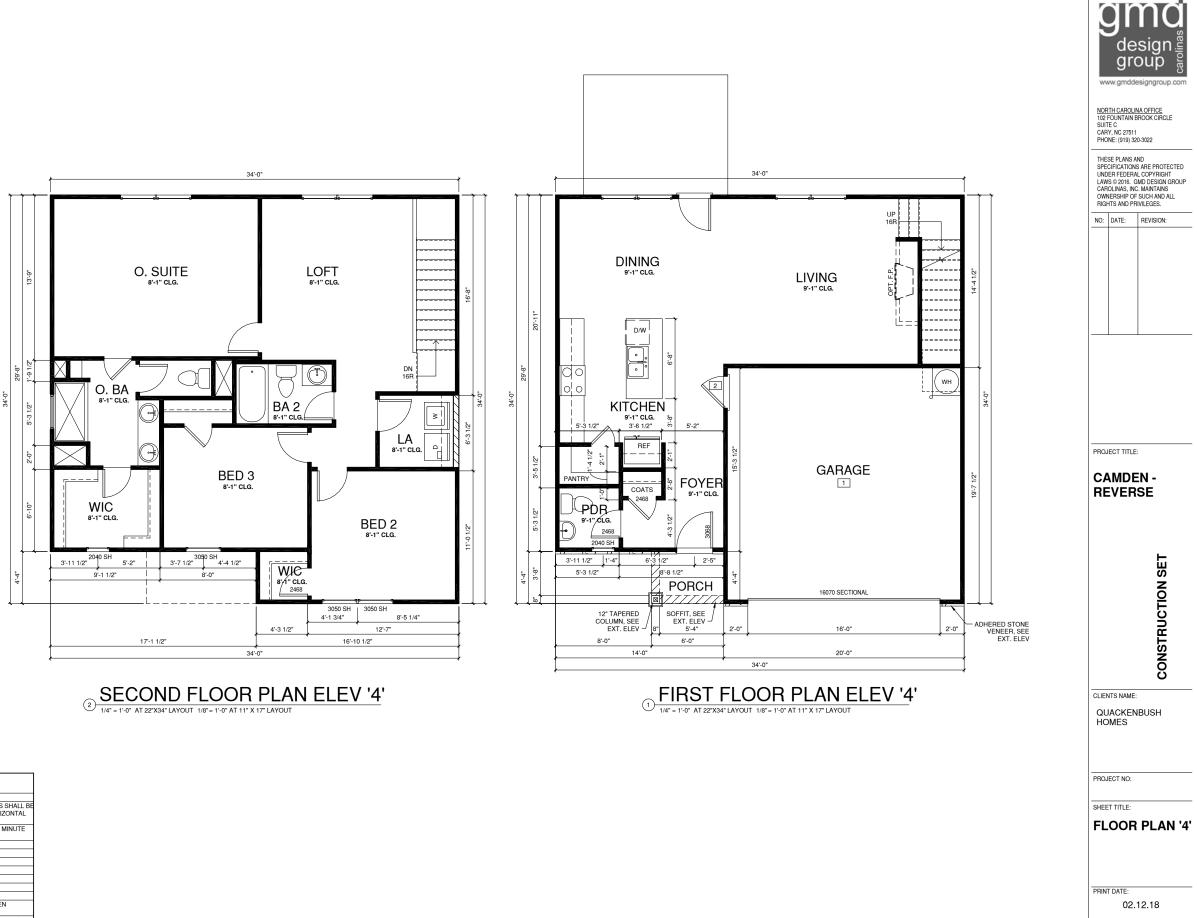

WALL LEGEND

FULL HEIGHT FULL HEIGHT 2X4 WOOD STUD PARTITION 2X6 WOOD STUD PARTITION DRYWALL OPENING HEIGHT AS NOTED ON PLAN _____ STONE VENEER BRICK VENEER STUD WALL BELOW HEIGHT AND STUD SIZE AS NOTED

FLOOR PLAN KEYNOTE LEGEND

1	HOUSE TO GARAGE FIRE SEPARATION, GARAGE/HOUSE SEPARATION AT VERTICAL SURFACES SHALL BE
	PROTECTED WITH ONE (1) LAYER 1/2" GYPSUM BOARD. GARAGE/HOUSE SEPARATION AT HORIZONTAL SURFACES SHALL BE PROTECTED WITH ONE (1) LAYER 5/8" TYPE "X" GYPSUM BOARD
2	HOUSE TO GARAGE DOOR SEPARATION. PROVIDE 1 3/8" SOLID CORE DOOR OR APPROVED 20 MINUTE RATED DOOR
4	GAS WATER HEATER ON 18" HIGH PLATFORM
7	PRE-FABRICATED METAL FIREPLACE, INSTALL PER MANUFACTURER WRITTEN INSTRUCTIONS
9	TEMPERED SAFETY GLASS
11	HALF WALL, HEIGHT AS NOTED
12	INTERIOR SOFFITS: FFL = 8'-1" U.N.O. SFL = 7'-6" U.N.O., OPT. CASED OPENING U.N.O.
13	SHOWER, TEMPERED GLASS ENCLOSURE
14	TUB-SHOWER COMBO
16	SLIDE-IN ELECTRICAL RANGE W/ HOOD AND MICRO ABV. VENT PER MANUFACTURER'S WRITTEN
	INSTRUCTIONS
19	ACCESS HATCH/DOOR. FULLY WEATHER STRIPPED AND INSULATED. (PER NCRC SECTION N1102.2.3)

A1.4

SHEET NO:


WALL LEGEND	
FULL HEIGHT 2X4 WOOD STUD PARTITION CONTRACTOR STONE VENEER BRICK VENEER	FULL HEIGHT 226 WOOD STUD PARTITION DRYWALL OPENING HEIGHT AS NOTED ON PLAN
STUD WALL BELOW HEIGHT AND STUD SIZE AS N	IOTED


FLOOR PLAN KEYNOTE LEGEND


HOUSE TO GARAGE FIRE SEPARATION, GARAGE/HOUSE SEPARATION AT VERTICAL SURFACES SHALL BE PROTECTED WITH ONE (1) LAYER 1/2° GYPSUM BOARD. GARAGE/HOUSE SEPARATION AT HORIZONTAL SURFACES SHALL BE PROTECTED WITH ONE (1) LAYER 5/8° TYPE 'X° GYPSUM BOARD HOUSE TO GARAGE DOOR SEPARATION. PROVIDE 13/8° SOLID CORE DOOR OR APPROVED 20 MINUTE RATED DOOR GAS WATER HEATER ON 18° HIGH PLATFORM PRE-FABRICATED METAL FIREPLACE, INSTALL PER MANUFACTURER WRITTEN INSTRUCTIONS TEMPERED SAFETY GLASS

TEMPERED SAFETT GLASS HALF WALL, HEIGHT AS NOTED INTERIOR SOFFITS: FFL = 8'-1' U.N.O. SFL = 7'-6' U.N.O., OPT. CASED OPENING U.N.O. SHOWER, TEMPERED GLASS ENCLOSURE TUB-SHOWER COMEO


SUBE-IN LECTRICAL RANGE W/ HOOD AND MICRO ABV. VENT PER MANUFACTURER'S WRITTEN INSTRUCTIONS ACCESS HATCH/DOOR, FULLY WEATHER STRIPPED AND INSULATED. (PER NCRC SECTION N1102.2.3)

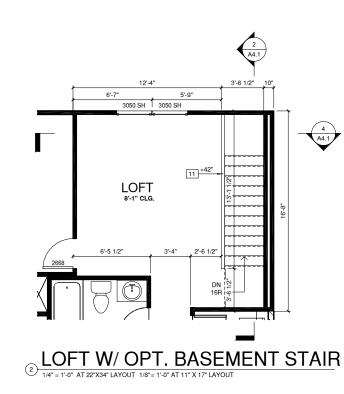

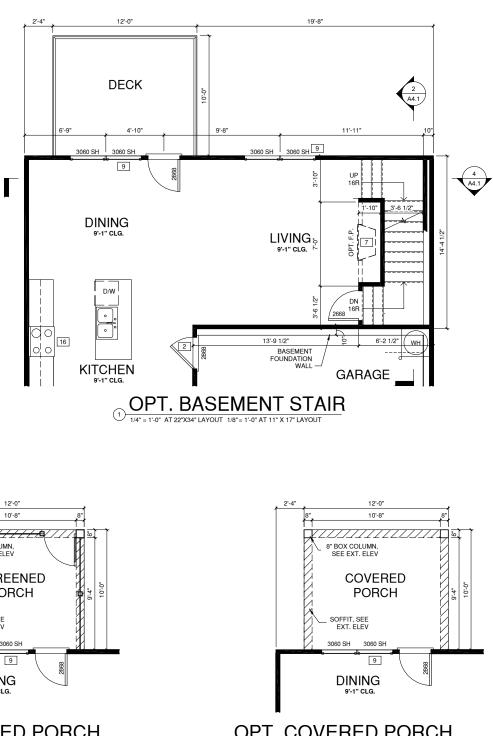


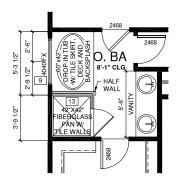



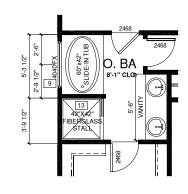




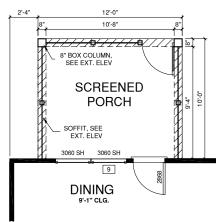

OPT. SCREENED PORCH 1/4" = 1'-0" AT 22"X34" LAYOUT 1/8" = 1'-0" AT 11" X 17" LAYOUT

(4)

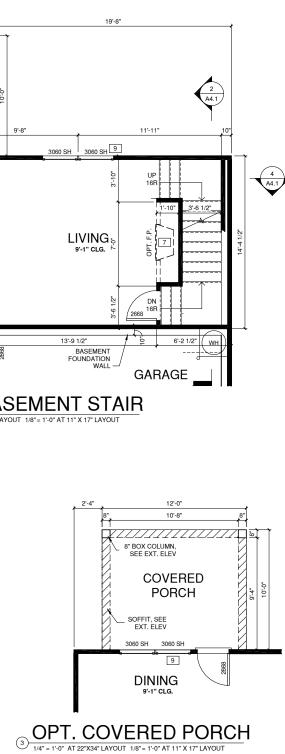



02.12.18

SHEET NO:

A1.5





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SHEET TITLE:

PRINT DATE:

SHEET NO:

02.12.18

A4.1

SECTIONS



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NO: DATE: REVISION:
PROJECT TITLE: CAMDEN - REVERSE
CONSTRUCTION SET
TRUCTION S
CLIENTS NAME: QUACKENBUSH

	ELEVATION KEYNOTE LEGEND
E1	ADHERED STONE VENEER AS SELECTED BY DEVELOPER, HEIGHT AS NOTED
E7	FYPON OR EQUIVALENT LOUVERED VENT, SIZE AS NOTED
E9	CORROSION RESISTANT ROOF TO WALL FLASHING, CODE COMPLIANT FLASHING MUST
	BE INSTALLED AT ALL ROOF/WALL INTERSECTIONS
E12	FIBER CEMENT SHAKE SIDING PER DEVELOPER W/ 5/4x4 CORNER TRIM BOARDS
E13	FIBER CEMENT LAP SIDING PER DEVELOPER W/ 5/4x4 CORNER TRIM BOARDS
E15	FIBER CEMENT PANEL SIDING W/ 1X3 BATTS AT 12" O.C. (VINYL BOARD AND BATTEN
	SIDING)
E16	1X FIBER CEMENT TRIM OR EQUAL, U.N.O. SIZE AS NOTED
E17	FALSE WOOD/VINYL SHUTTERS, TYPE AS SHOWN, SIZE AS NOTED
E18	PROVIDE GUARDRAIL PER NCRC SECTION R312

-ALL EXTERIOR MATERIALS TO BE INSTALLED PER MANUFACTURER'S WRITTEN INSTRUCTIONS.

-CHIMNEY AS OCCURS: TOP OF CHIMNEYS TO BE A MINIMUM OF 24" ABOVE ANY ROOF WITHIN 10'-0" OF CHIMNEY.

-ENTRY DOOR: AS SELECTED BY BUILDER

-WINDOWS: MANUFACTURER PER BUILDER. DIVIDED LITES AS SHOWN ON THE EXTERIOR ELEVATIONS


ROOFING: PITCHED SHINGLES PER BUILDER.

-WINDOW HEAD HEIGHTS: 1ST FLOOR = 8'-0" U.N.O. ON ELEVATIONS 2ND FLOOR = 7'-0" U.N.O. ON ELEVATIONS 3RD FLOOR = 7'-0" U.N.O. ON ELEVATIONS.


-GRADE CONDITIONS MAY VARY FOR INDIVIDUAL SITE FROM THAT SHOWN. BUILDER SHALL VERIFY AND COORDINATE PER ACTUAL SITE CONDITIONS

NOTES:

ALL WINDOWS WHOSE OPENING IS LESS THAN 24" ABOVE THE FINISH FLOOR AND WHOSE OPENING IS GREATER THAN 72" ABOVE THE OUTSIDE WALKING SURFACE MUST HAVE WINDOW OPENING LIMITING DEVICES COMPLYING WITH THE 2012 IRC SECTION R312.2.

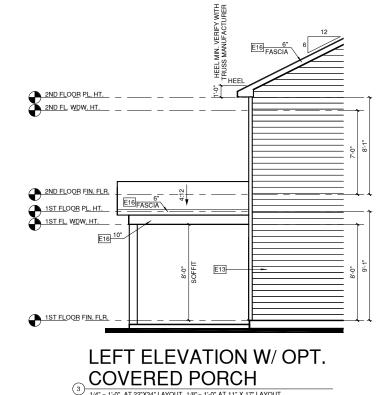

1/4" = 1'-0" AT 22"X34" LAYOUT 1/8"= 1'-0" AT 11" X 17" LAYOUT

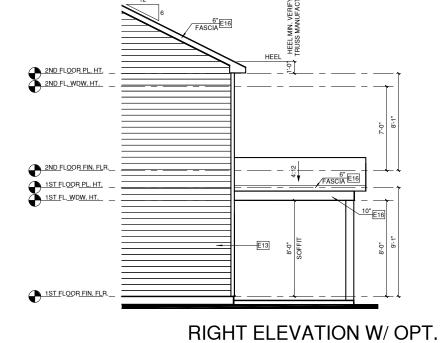





(2) COVERED PORCH (2) 1/4" = 1'-0" AT 22"X34" LAYOUT 1/8" = 1'-0" AT 11" X 17" LAYOUT

02.12.18 SHEET NO:

A5.1.1

PRINT DATE:

ELEV OPTIONS

SHEET TITLE:

PROJECT NO:

QUACKENBUSH HOMES

CLIENTS NAME:



CAMDEN -REVERSE

PROJECT TITLE:

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	ELEVATION KEYNOTE LEGEND
E1	ADHERED STONE VENEER AS SELECTED BY DEVELOPER, HEIGHT AS NOTED
E7	FYPON OR EQUIVALENT LOUVERED VENT, SIZE AS NOTED
E9	CORROSION RESISTANT ROOF TO WALL FLASHING, CODE COMPLIANT FLASHING MUST
	BE INSTALLED AT ALL ROOF/WALL INTERSECTIONS
E12	FIBER CEMENT SHAKE SIDING PER DEVELOPER W/ 5/4x4 CORNER TRIM BOARDS
E13	FIBER CEMENT LAP SIDING PER DEVELOPER W/ 5/4x4 CORNER TRIM BOARDS
E15	FIBER CEMENT PANEL SIDING W/ 1X3 BATTS AT 12" O.C. (VINYL BOARD AND BATTEN SIDING)
E16	1X FIBER CEMENT TRIM OR EQUAL, U.N.O. SIZE AS NOTED
E17	FALSE WOOD/VINYL SHUTTERS, TYPE AS SHOWN, SIZE AS NOTED
E18	PROVIDE GUARDRAIL PER NCRC SECTION R312

-ALL EXTERIOR MATERIALS TO BE INSTALLED PER MANUFACTURER'S WRITTEN INSTRUCTIONS.

-CHIMNEY AS OCCURS: TOP OF CHIMNEYS TO BE A MINIMUM OF 24" ABOVE ANY ROOF WITHIN 10'-0" OF CHIMNEY.

-ENTRY DOOR: AS SELECTED BY BUILDER

-WINDOWS: MANUFACTURER PER BUILDER. DIVIDED LITES AS SHOWN ON THE EXTERIOR ELEVATIONS


ROOFING: PITCHED SHINGLES PER BUILDER.

-WINDOW HEAD HEIGHTS: 1ST FLOOR = 8'-0" U.N.O. ON ELEVATIONS 2ND FLOOR = 7'-0" U.N.O. ON ELEVATIONS 3RD FLOOR = 7'-0" U.N.O. ON ELEVATIONS.


-GRADE CONDITIONS MAY VARY FOR INDIVIDUAL SITE FROM THAT SHOWN. BUILDER SHALL VERIFY AND COORDINATE PER ACTUAL SITE CONDITIONS

NOTES:


ALL WINDOWS WHOSE OPENING IS LESS THAN 24" ABOVE THE FINISH FLOOR AND WHOSE OPENING IS GREATER THAN 72" ABOVE THE OUTSIDE WALKING SURFACE MUST HAVE WINDOW OPENING LIMITING DEVICES COMPLYING WITH THE 2012 IRC SECTION R312.2.

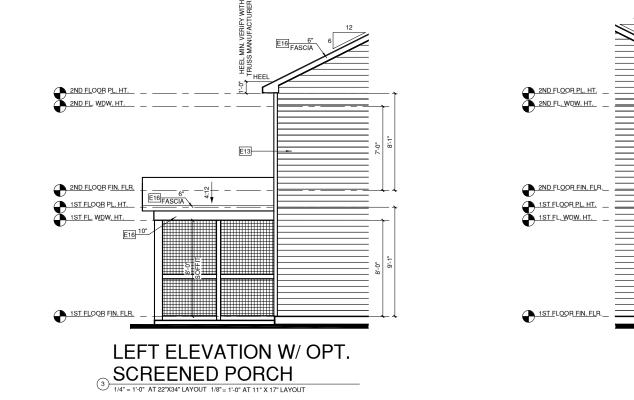


E16 FASCI/

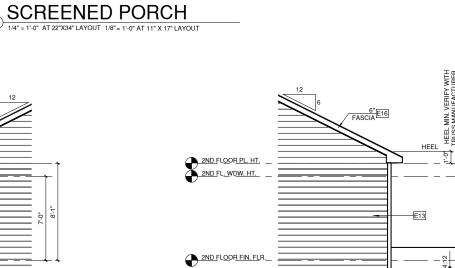



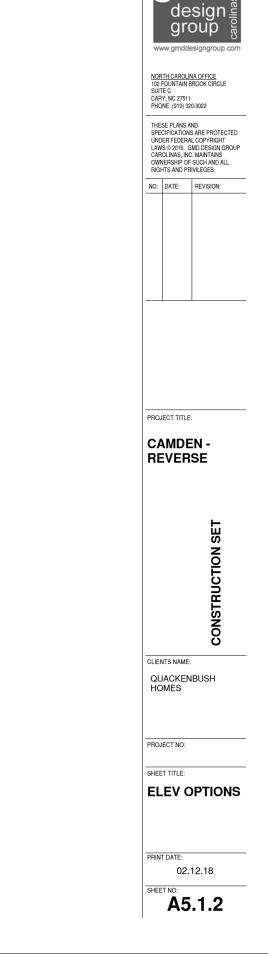

gr

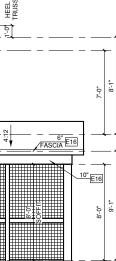

RIGHT ELEVATION W/ OPT.

² SCREENED PORCH

1/4" = 1'-0" AT 22"X34" LAYOUT 1/8" = 1'-0" AT 11" X 17" LAYOUT

E1	ADHERED STONE VENEER AS SELECTED BY DEVELOPER, HEIGHT AS NOTED
	FYPON OR EQUIVALENT LOUVERED VENT, SIZE AS NOTED
E9	CORROSION RESISTANT ROOF TO WALL FLASHING, CODE COMPLIANT FLASHING MUS
	BE INSTALLED AT ALL ROOF/WALL INTERSECTIONS
E12	FIBER CEMENT SHAKE SIDING PER DEVELOPER W/ 5/4x4 CORNER TRIM BOARDS
E13	FIBER CEMENT LAP SIDING PER DEVELOPER W/ 5/4x4 CORNER TRIM BOARDS
E15	FIBER CEMENT PANEL SIDING W/ 1X3 BATTS AT 12" O.C. (VINYL BOARD AND BATTEN SIDING)
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E17	FALSE WOOD/VINYL SHUTTERS, TYPE AS SHOWN, SIZE AS NOTED
E18	PROVIDE GUARDRAIL PER NCRC SECTION R312

ELEVATION KEYNOTE LEGEND

-ALL EXTERIOR MATERIALS TO BE INSTALLED PER MANUFACTURER'S WRITTEN INSTRUCTIONS.

-CHIMNEY AS OCCURS: TOP OF CHIMNEYS TO BE A MINIMUM OF 24" ABOVE ANY ROOF WITHIN 10-0" OF CHIMNEY.

ENTRY DOOR: AS SELECTED BY BUILDER

-WINDOWS: MANUFACTURER PER BUILDER. DIVIDED LITES AS SHOWN ON THE EXTERIOR ELEVATIONS

ROOFING: PITCHED SHINGLES PER BUILDER.


-WINDOW HEAD HEIGHTS: 1ST FLOOR = 8'-0" U.N.O. ON ELEVATIONS 2ND FLOOR = 7'-0" U.N.O. ON ELEVATIONS 3RD FLOOR = 7'-0" U.N.O. ON ELEVATIONS.

-GRADE CONDITIONS MAY VARY FOR INDIVIDUAL SITE FROM THAT SHOWN. BUILDER SHALL VERIFY AND COORDINATE PER ACTUAL SITE CONDITIONS.

NOTES:

ALL WINDOWS WHOSE OPENING IS LESS THAN 24" ABOVE THE FINISH FLOOR AND WHOSE OPENING IS GREATER THAN 72" ABOVE THE OUTSIDE WALKING SURFACE MUST HAVE WINDOW OPENING LIMITING DEVICES COMPLYING WITH THE 2012 IRC SECTION R312.2.

REAR ELEVATION W/ OPT. (1)-BASEMENT 1/4" = 1'-0" AT 22'X34" LAYOUT 1/8" = 1'-0" AT 11" X 17" LAYOUT

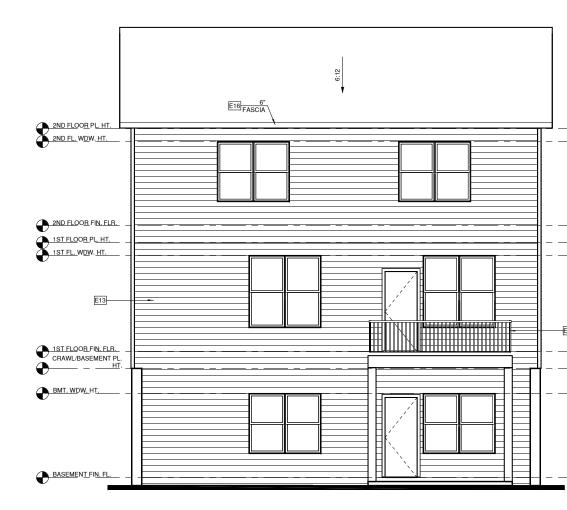

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NO:	DATE:	REVISION:	





CLIENTS NAME:

QUACKENBUSH HOMES

PROJECT NO:

SHEET TITLE:

PRINT DATE:

SHEET NO:


ELEV OPTIONS

02.12.18

A5.1.3

PROJECT TITLE: CAMDEN -

E18

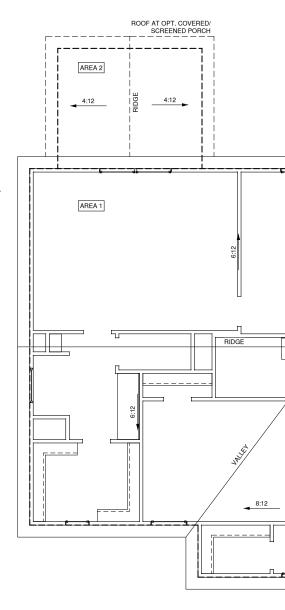



GENERAL CONTRACTOR SHALL VERIFY THE NET FREE VENTILATION OF THE VENT PRODUCT SELECTED BY OWNER. VERIFY WITH MANUFACTURER OF HIGH AND LOW VENTS TO BE USED FOR MINIMUM CALCULATED VENTS AS AN ALTERNATE TO THE 1/150 RATIO LISTED, THE NET FREE CROSS-VENTILATION AREA MAY BE REDUCED TO 1/300 WHEN A VAPOR BARRIER IS HAVING A TRANSMISSION RATE NOT EXCEEDING I-PERM INSTALLED ON THE WARM-IN-WINTER SIDE OF THE CEILING. REQUIRED. THE REQUIRED VENTILATION SHALL BE MAINTAINED. PROVIDE INSULATION STOP SUCH THAT INSULATION DOES NOT OBSTRUCT GENERAL CONTRACTOR SHALL VERIFY THE NET FREE GENERAL CONTRACTOR SHALL VERIFY THE NET FREE VENTILATION OF THE VENT PRODUCT SELECTED BY OWNER. VERIFY WITH MANUFACTURER OF HIGH AND LOW VENTS TO BE USED FOR MINIMUM CALCULATED VENTS REQUIRED. THE REQUIRED VENTILATION SHALL BE MAINTAINED. PROVIDE INSULATION STOP SUCH THAT INSULATION DOES NOT OBSTRUCT FREE AIR MOVEMENT AS REQUIRED BY THE BUILDING OFFICIAL. FREE AIR MOVEMENT AS REQUIRED BY THE BUILDING OFFICIAL. ALL OVERLAP FRAMED ROOF AREAS SHALL HAVE OPENINGS BETWEEN THE ADJACENT ATTICS IN THE ROOF SHEATHING (AS ALLOWED BY THE STRUCTURAL ENGINEER) TO ALLOW PASSAGE AND ATTIC VENTILATION BETWEEN THE TWO OR ISOLATED ATTIC SPACES SHALL ALL OVERLAP FRAMED ROOF AREAS SHALL HAVE OPENINGS BETWEEN THE ADJACENT ATTICS IN THE ROOF SHEATHING (AS ALLOWED BY THE STRUCTURAL ENGINEER) TO ALLOW PASSAGE AND ATTIC VENTILATION BETWEEN THE TWO OR ISOLATED ATTIC SPACES SHALL BE VENTED INDEPENDENTLY TO CBC REQUIREMENTS. BE VENTED INDEPENDENTLY TO CBC REQUIREMENTS. PER DEVELOPER, AT ALL CANTILEVERED FLOORS. CANTILEVERED DECORATIVE PROJECTIONS, AND ANY DOUBLE FRAMING PROJECTIONS THAT ARE SEPARATED FROM THE VENTING CALCULATIONS SHOWN ABOVE,

PER DEVELOPER, AT ALL CANTILEVERED FLOORS, CANTILEVERED DECORATIVE PROJECTIONS, AND ANY DOUBLE FRAMING PROJECTIONS, THAT ARE SEPARATED FROM THE VENTING CALCULATIONS SHOWN ABOVE, PROVIDE A CONTINUOUS 2" CORROSION DECOTATIVE OPERIT VENTURE OF DECORE RESISTANT SOFFIT VENT AT UNDERSIDE OF FRAMED ELEMENT.

NOTES:

1/150 RATIO:

ALL ROOF DRAINAGE SHALL BE PIPED TO STREET OR APPROVED DRAINAGE FACILITY. DASHED LINES INDICATE WALL BELOW. LOCATE GUTTER AND DOWNSPOUTS PER BUILDER. PITCHED ROOFS AS NOTED.


TRUSS MANUFACTURER SHALL SUBMIT STRUCTURAL CALCS AND SHOP DRAWING TO THE BUILDER'S GENERAL CONTRACTOR AND BUILDING DEPARTMENT FOR REVIEW PRIOR TO FABRICATIONS.

ALL PLUMBING VENTS SHALL BE COMBINED INTO A MINIMUM AMOUNT OF ROOF PENETRATIONS. ALL ROOF PENETRATIONS SHALL OCCUR TO THE REAR OF THE MAIN RIDGE.

PROVIDE A CONTINUOUS 2" CORROSION RESISTANT SOFFIT VENT AT UNDERSIDE OF FRAMED ELEMENT.

1/300 RATIO:

ROOF VENT CALC. ELEV. 'A'				
Name	Area	1/300 RATIO AT HIGH & LOW	1/150 RATIO AT HIGH & LOW	
AREA 1	1095 SF	262.88 in ²	525.76 in ²	
AREA 2	120 SF	28.80 in ²	57.60 in ²	

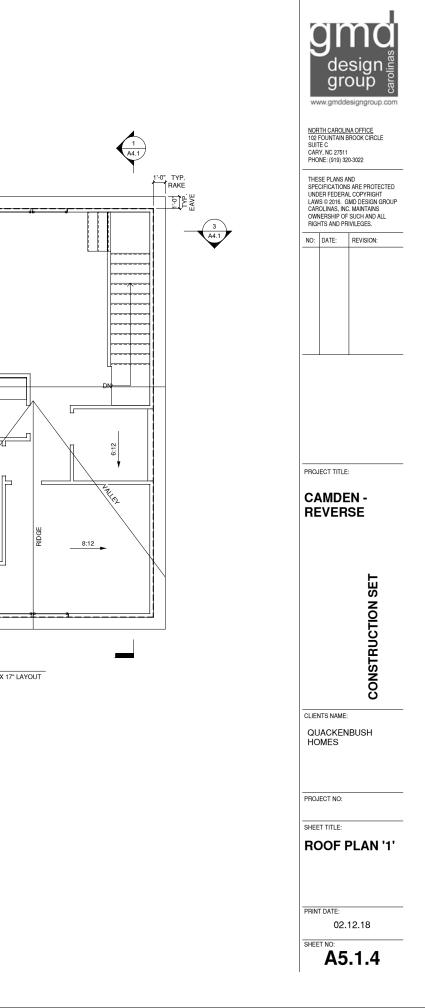





A5.2

1/150 RATIO:	1/300 RATIO:
GENERAL CONTRACTOR SHALL VERIFY THE NET FREE VENTILATION OF THE VENT PRODUCT SELECTED BY OWNER. VERIFY WITH MANUFACTURER OF HIGH AND LOW VENTS TO BE USED FOR MINIMUM CALCULATED VENTS REQUIRED. THE REQUIRED VENTILATION SHALL BE MAINTAINED. PROVIDE INSUL ATION STOP	AS AN ALTERNATE TO THE 1/150 RATIO LISTED, THE NET FREE CROSS-VENTILATION AREA MAY BE REDUCED TO 1/300 WHEN A VAPOR BARRIER IS HAVING A TRANSMISSION RATE NOT EXCEEDING I-PERM INSTALLED ON THE WARM-IN- WINTER SIDE OF THE CEILING. GENERAL CONTRACTOR SHALL VERIEY THE NET ERFE
SUCH THAT INSULATION DOES NOT OBSTRUCT FREE AIR MOVEMENT AS REQUIRED BY THE BUILDING OFFICIAL.	VENTILATION OF THE VENT PRODUCT SELECTED BY OWNER. VERIFY WITH MANUFACTURER OF HIGH AND LOW VENTS TO BE USED FOR MINIMUM CALCULATED VENTS REQUIRED. THE REQUIRED VENTILATION SHALL BE
ALL OVERLAP FRAMED ROOF AREAS SHALL HAVE OPENINGS BETWEEN THE ADJACENT ATTICS IN THE ROOF SHEATHING (AS ALLOWED BY THE STRUCTURAL ENGINEER) TO ALLOWED DESCEDED AND ATTIC UNTIT AND DETUNEFAL	MAINTAINED, PROVIDE INSULATION STOP SUCH THAT INSULATION DOES NOT OBSTRUCT FREE AIR MOVEMENT AS REQUIRED BY THE BUILDING OFFICIAL.
PASSAGE AND ATTIC VENTILATION BETWEEN THE TWO OR ISOLATED ATTIC SPACES SHALL BE VENTED INDEPENDENTLY TO CBC REQUIREMENTS.	ALL OVERLAP FRAMED ROOF AREAS SHALL HAVE OPENINGS BETWEEN THE ADJACENT ATTICS IN THE ROOF SHEATHING (AS ALLOWED BY THE STRUCTURAL ENGINEER) TO ALLOW PASSAGE AND ATTIC VENTILATION BETWEEN THE TWO OR ISOI ATED ATTIC SPACES SHALL BE VENTED
PER DEVELOPER, AT ALL CANTILEVERED FLOORS, CANTILEVERED DECORATIVE PROJECTIONS, AND ANY DOUBLE FRAMING	INDEPENDENTLY TO CBC REQUIREMENTS. PER DEVELOPER, AT ALL CANTILEVERED FLOORS.
PROJECTIONS THAT ARE SEPARATED FROM THE VENTING CALCULATIONS SHOWN ABOVE, PROVIDE A CONTINUOUS 2" CORROSION RESISTANT SOFFIT VENT AT UNDERSIDE OF	FER DEVELOPER, AT ALE AVAILLEVENDE FLOORS, AND ANY CANTILEVERED DECORATIVE PROJECTIONS, AND ANY DOUBLE FRAMING PROJECTIONS THAT ARE SEPARATED FROM THE VENTING CALCULATIONS SHOWN ABOVE, PROVIDE A CONTINUOUS 2" CORROSION RESISTANT SOFFIT
FRAMED ELEMENT.	VENT AT UNDERSIDE OF FRAMED ELEMENT.
NOTES:	
 ALL ROOF DRAINAGE SHALL BE PIPED TO STREET OR APPROVED DRAINAGE FACILITY. DASHED LINES INDICATE WALL BELOW. LOCATE GUTTER AND DOWNSPOUTS PER BUILDER. PITCHED ROOFS AS NOTED. 	TRUSS MANUFACTURER SHALL SUBMIT STRUCTURAL CALCS AND SHOP DRAWING TO THE BUILDERS GENERAL CONTRACTOR AND BUILDING DEPARTMENT FOR REVIEW PRIOR TO FABRICATIONS. ALL PLUMBING VENTS SHALL BE COMBINED INTO A MINIMUM AMOUNT OF ROOF PENETRATIONS. ALL ROOF PENETRATIONS SHALL OCCUR TO THE REAR OF THE MAIN RIDGE.

PITCHED ROOFS AS NOTED.


ROOF VENT CALC. ELEV. 'B'			
Name	Area	1/300 RATIO AT HIGH & LOW	1/150 RATIO AT HIGH & LOW
AREA 1	1095 SF	262.88 in ²	525.76 in ²
AREA 2	26 SF	6.24 in ²	12.48 in ²
AREA 3	120 SF	28.80 in ²	57.60 in ²

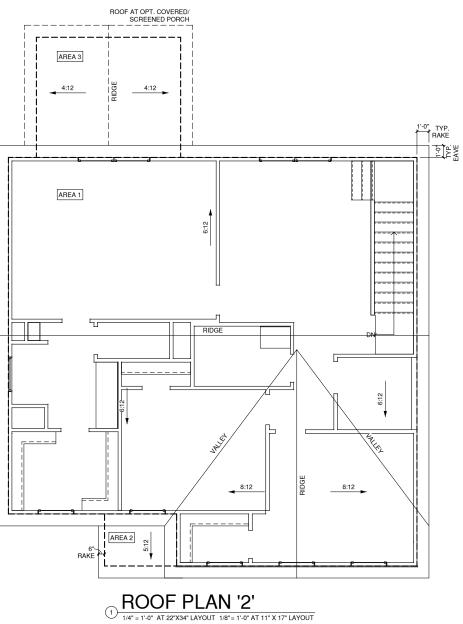

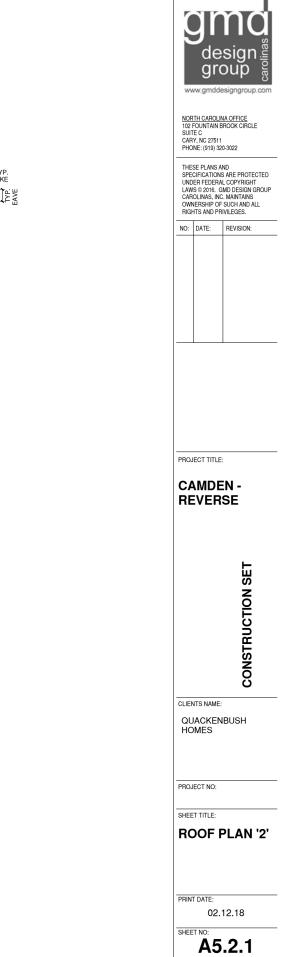



Ē			RED/ DRCH	
	AREA 3			
	L	db	<u> </u>	
	AREA 1		6:12	
	'	1	RIDGE	
			3	
L	6"- RAKE			

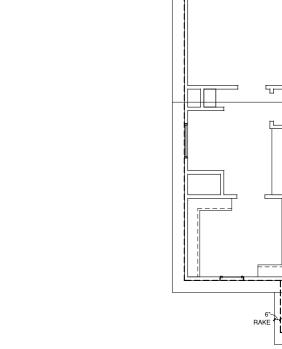

	1/150 RATIO:	1/300 RATIO:
	GENERAL CONTRACTOR SHALL VERIFY THE NET FREE VENTILATION OF THE VENT PRODUCT SELECTED BY OWNER. VERIFY WITH MANUFACTURER OF HIGH AND LOW VENTS TO BE USED FOR MINIMUM CALCULATED VENTS REQUIRED. THE REQUIRED VENTILATION SHALL BE MAINTAINED. PROVIDE INSULATION STOP SUCH THAT INSULATION DOES NOT OBSTRUCT FREE AIR MOVEMENT AS REQUIRED BY THE BUILDING OFFICIAL. ALL OVERLAP FRAMED ROOF AREAS SHALL HAVE OPENINGS BETWEEN THE ADJACENT ATTIOS IN THE ROOF SHEATHING (AS ALLOWED BY THE STRUCTURAL ENGINEER) TO ALLOW PASSAGE AND ATTIC VENTILATION BETWEEN THE TWO OR ISOLATED ATTIC SPACES SHALL BE VENTED INDEPENDENTLY TO CBC REQUIREMENTS. PER DEVELOPER, AT ALL CANTILEVERED FLOORS, CANTILEVERED DECORATIVE PROJECTIONS THAT ARE SEPARATED FROM THE WENTING CALCULATIONS SHOWN ABOVE, PROVIDE A CONTINUOUS 2" CORROSION RESISTANT SOFFIT VENT AT UNDERSIDE OF FRAMED ELEMENT.	AS AN ALTERNATE TO THE 1/150 RATIO LISTED, THE NET FREE CROSS-VENTILATION AREA MAY BE REDUCED TO 1/300 WHEN A VAPOR BARRIER IS HAVING A TRANSMISSION RATE NOT EXCEEDING I-PERM INSTALLED ON THE WARM-IN- WINTER SIDE OF THE CEILING. GENERAL CONTRACTOR SHALL VERIFY THE NET FREE VENTILATION OF THE VENT PRODUCT SELECTED BY OWNER. VERIFY WITH MANUFACTURER OF HIGH AND LOW VENTS TO BE USED FOR MINIWUM CALCULATED VENTS REQUIRED, THE REQUIRED VENTILATION SHALL BE MAINTAINED, PROVIDE INSULATION STOP SUCH THAT INSULATION DOES NOT OBSTRUCT FREE AIR MOVEMENT AS REQUIRED BY THE BUILDING OFFICIAL. ALL OVERLAP FRAMED ROOF AREAS SHALL HAVE OPENINGS BETWEEN THE ADJACENT ATTICS IN THE ROOF SHEATHING (AS ALLOWED BY THE STRUCTURAL ENGINEER) TO ALLOW PASSAGE AND ATTIC SPACES SHALL BE VENTED INDEPENDENTLY TO CBC REQUIREMENTS. PER DEVELOPER, AT ALL CANTILEVERED FLOORS, CANTILEVERED AT ALL CANTILEVERED FLOORS, CANTILEVERED DECORATIVE PROJECTIONS, AND ANY DOUBLE FRAMING PROJECTIONS STHAT ARE SEPARATED FROM THE VENTING CALCULATIONS SHOWN ABOVE, PROVIDE A CONTINUOUS 2° CORROSION RESISTANT SOFFIT VENT AT UNDERSIDE OF FRAMED ELEMENT.
ļ	NOTES:	
	ALL ROOF DRAINAGE SHALL BE PIPED TO STREET OR ARRPOVED DRAINAGE	TRUSS MANUFACTURER SHALL SUBMIT STRUCTURAL CALCS AND SHOP DRAWING TO THE PLUE DEDIS OF DEPART.

1/300 RATIO:

0	ALL ROOF DRAINAGE SHALL BE PIPED TO	0	TRUSS MANUFACTURER SHALL SUBMIT STRUCTURA
	STREET OR APPROVED DRAINAGE		AND SHOP DRAWING TO THE BUILDER'S GENERAL
	FACILITY.		CONTRACTOR AND BUILDING DEPARTMENT FOR REV
۵	DASHED LINES INDICATE WALL BELOW.		PRIOR TO FABRICATIONS.
۵	LOCATE GUTTER AND DOWNSPOUTS PER		ALL PLUMBING VENTS SHALL BE COMBINED INTO A M
	BUILDER.		AMOUNT OF ROOF PENETRATIONS. ALL ROOF PENE
۵	PITCHED ROOFS AS NOTED.		SHALL OCCUR TO THE REAR OF THE MAIN RIDGE.

[]	TRUSS MANUFACTURER SHALL SUBMIT STRUCTURAL CALCS
		AND SHOP DRAWING TO THE BUILDER'S GENERAL
		CONTRACTOR AND BUILDING DEPARTMENT FOR REVIEW
		PRIOR TO FABRICATIONS.


- A MINIMUM


ROOF VENT CALC. ELEV. 'C'			
Name	Area	1/300 RATIO AT HIGH & LOW	1/150 RATIO AT HIGH & LOW
AREA 1	1082 SF	259.63 in ²	519.26 in ²
AREA 2	40 SF	9.49 in ²	18.98 in ²
AREA 3	120 SF	28.80 in ²	57.60 in ²

1/150 RATIO:


() ROOF PLAN '3' () 1/4" = 1'-0" AT 22"X34" LAYOUT 1/8" = 1'-0" AT 11" X 17" LAYOUT

Adesign up group up www.gmddesigngroup.com		
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NO:	DATE:	REVISION:
PROJECT TITLE: CAMDEN - REVERSE		
		CONSTRUCTION SET
QL	NTS NAME: JACKEN DMES	BUSH
SHEE	TTITLE:	PLAN '3'
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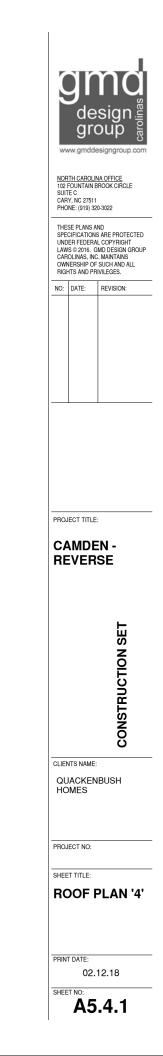
	_		ROOF AT OPT. COVER	ED/ ICH	
		AREA 3			
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		AREA 1		6:12	
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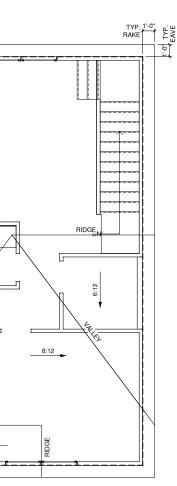


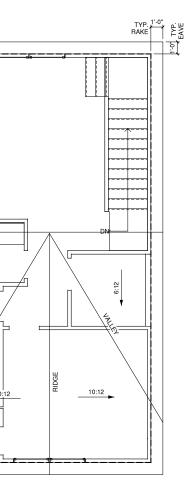
ROOF VENT CALC. ELEV. 'D'

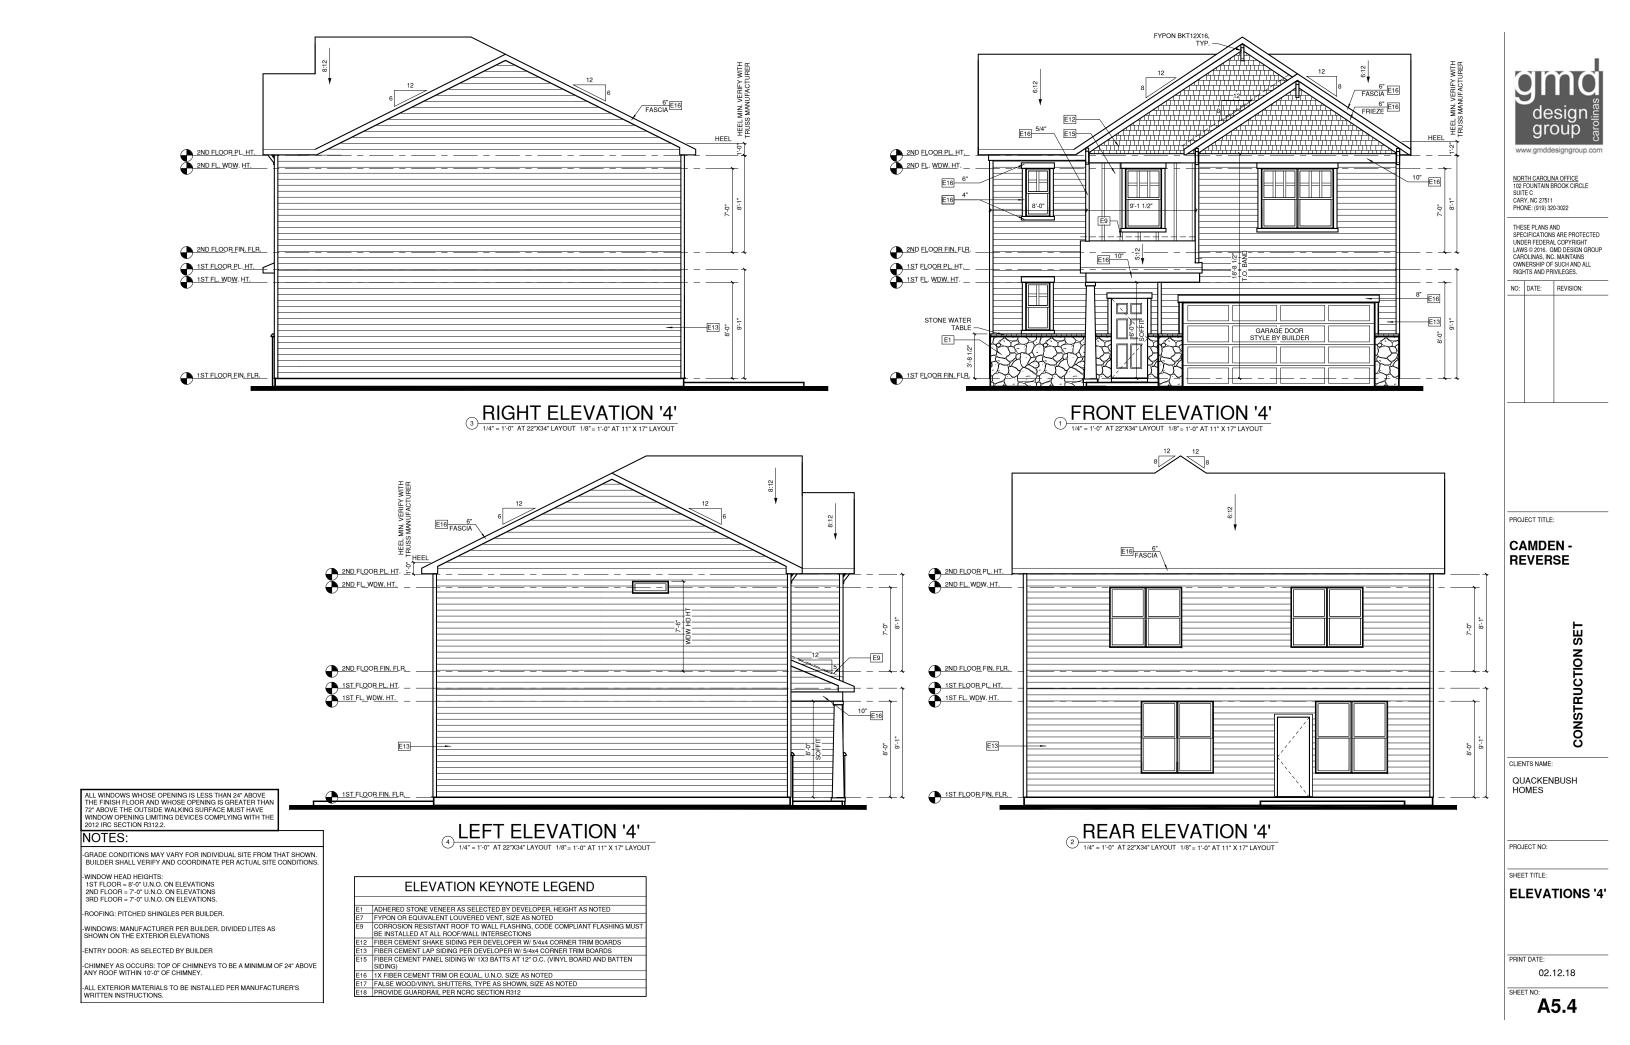Name	Area	1/300 RATIO AT HIGH & LOW	1/150 RATIO AT HIGH & LOW
AREA 1	1082 SF	259.63 in ²	519.26 in ²
AREA 2	40 SF	9.49 in ²	18.98 in ²
AREA 3	120 SF	28.80 in ²	57.60 in ²


1 ROOF PLAN '4' 1/4" = 1'-0" AT 22"X34" LAYOUT 1/8" = 1'-0" AT 11" X 17" LAYOUT

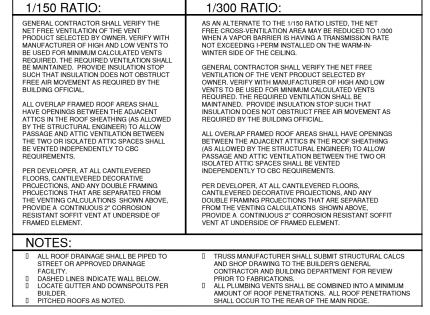



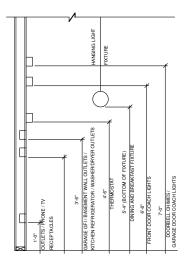

STANDARD ELECTRICAL BOX HEIGHTS

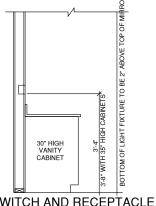

SWITCH AND RECEPTACLE BOXES OVER BATH CABINETS BOXES OVER KITCHEN CABINETS

NOTES:

PROVIDE GROUNDING ELECTRICAL ROD PER LOCAL CODES.

PROVIDE AND INSTALL ARC FAULT CIRCUIT-INTERRUPTERS (AFCI) AS REQUIRED BY NATIONAL ELECTRICAL CODE (NEC) AND MEETING THE REQURIEMENTS OF ALL GOVERNING CODES.

ALL EXHAUST FANS SHALL HAVE BACKDRAFT DAMPERS

FAN/LIGHTS IN WET/DAMP LOCATIONS SHALL BE LABLED "SUITABLE FOR WET OR DAMP LOCATIONS." -ELECTRICAL SYSTEMS ARE SHOWN FOR INTENT ONLY. THESE SYSTEMS SHALL BE ENGINEERED BY

OTHERS. THE CONTRACTOR SHALL BE RESPONSIBLE FOR PROPER INSTALLATION AND PLACEMENT.

-PROVIDE AND INSTALL LOCALLY CERTIFIED SMOKE DETECTORS AND CO2 DETECTORS AS REQUIRED BY NATIONAL FIRE PROTECTION ASSOCIATION (NFPA) AND MEETING THE REQUIREMENTS OF ALL GOVERNING CODES.

WALL ARINE

BASE CABINET

÷

SWITCH AND RECEPTACLE

-PROVIDE AND INSTALL GROUND FAULT CIRCUIT-INTERRUPTERS (GFI) AS REQUIRED BY NATIONAL ELECTRICAL CODE (NEC) AND MEETING THE REQUIREMENTS OF ALL GOVERNING CODES.

-ELECTRICAL CONTRACTOR TO PROVIDE REQURIED DIRECT HOOK-UPS/CUTOFFS.


HVAC CONTRACTOR TO VERIFY THERMOSTAT LOCATIONS.


ALL ELECTRICAL AND MECHANICAL EQUIPMENT (FURNACES, A/C UNITS, ELECTRICAL PANELS, SANITARY SUMP PITS, DRAING TILE SUMP, AND WATER HEATERS) ARE SUBJECT TO RELOCATOIN DUE TO FIELD CONDITIONS.

-PROVIDE POWER, LIGHT AND SWITCH AS REQUIRED FOR ATTIC FURNACE PER CODE AND MANUFACTURER'S WRITTEN INSTRUCTIONS.


I EGEND.

LEGEND.					
P	DUPLEX OUTLET		CEILING MOUNTED INCANDESCENT LIGHT FIXTURE		
₽wp/gfi	WEATHERPROOF GFI DUPLEX OUTLET	-	WALL MOUNTED INCANDESCENT LIGHT FIXUTRE		
₽ _{GFI}	GROUND-FAULT CIRCUIT- INTERRUPTER DUPLEX OUTLET	H H	RECESSED INCANDESCENT LIGHT FIXTURE		
0	HALF-SWITCHED DUPLEX OUTLET	ι Π	(VP) = VAPOR PROOF		
₽ _{220V}	220 VOLT OUTLET		EXHAUST FAN (VENT TO EXTERIOR)		
J	REINFORCED JUNCTION BOX	-0-	EXHAUST FAN/LIGHT COMBINATION (VENT TO EXTERIOR)		
\$	WALL SWITCH	· ·			
\$3	THREE-WAY SWITCH	\geq	FLUORESCENT LIGHT FIXTURE		
\$4	FOUR-WAY SWITCH		TECH HUB SYSTEM		
CH	CHIMES	$\mathbf{\mathbf{\mathbf{\mathbf{\mathbf{\mathbf{\mathbf{\mathbf{\mathbf{\mathbf{\mathbf{\mathbf{\mathbf{\mathbf{\mathbf{\mathbf{\mathbf{\mathbf{$	CEILING FAN (PROVIDE ADEQUATE SUPPORT)		
9	PUSHBUTTON SWITCH	\nearrow			
SD	110V SMOKE DETECTOR W/ BATTERY BACKUP	S	CEILING FAN WITH INCANDESCENT LIGHT FIXTURE		
Co	CO2 DETECTOR		(PROVIDE ADEQUATE SUPPORT)		
T	THERMOSTAT	⊢⊗ G	GAS SUPPLY WITH VALVE		
PH	TELEPHONE				
TV	TELEVISION		HOSE BIBB		
Ê	ELECTRIC METER	l—tow	1/4" WATER STUB OUT		
	ELECTRIC PANEL				
	DISCONNECT SWITCH	R − A	WALL SCONCE		

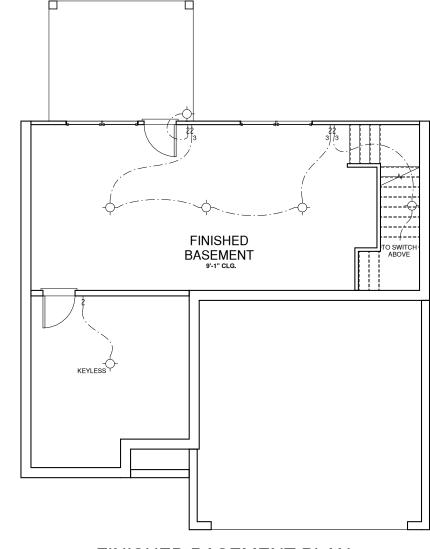


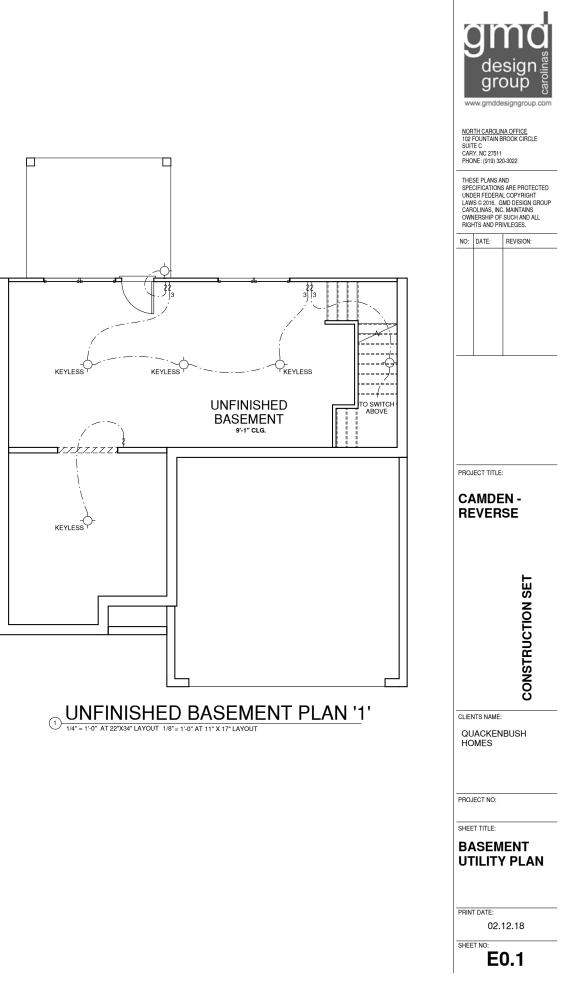

(2) FINISHED BASEMENT PLAN '1'

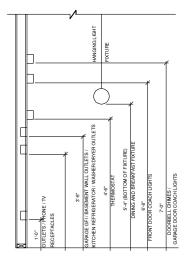

STANDARD ELECTRICAL BOX HEIGHTS

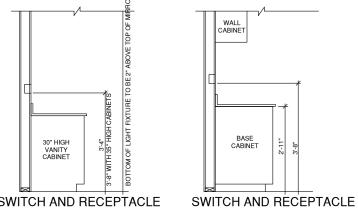

SWITCH AND RECEPTACLE

BOXES OVER BATH CABINETS

NOTES:



-PROVIDE AND INSTALL ARC FAULT CIRCUIT-INTERRUPTERS (AFCI) AS REQUIRED BY NATIONAL ELECTRICAL CODE (NEC) AND MEETING THE REQURIEMENTS OF ALL GOVERNING CODES.

ALL EXHAUST FANS SHALL HAVE BACKDRAFT DAMPERS

FAN/LIGHTS IN WET/DAMP LOCATIONS SHALL BE LABLED "SUITABLE FOR WET OR DAMP LOCATIONS."

-ELECTRICAL SYSTEMS ARE SHOWN FOR INTENT ONLY. THESE SYSTEMS SHALL BE ENGINEERED BY THERS. THE CONTRACTOR SHALL BE RESPONSIBLE FOR PROPER INSTALLATION AND PLACEMENT

PROVIDE AND INSTALL LOCALLY CERTIFIED SMOKE DETECTORS AND CO2 DETECTORS AS REQUIRED BY NATIONAL FIRE PROTECTION ASSOCIATION (NFPA) AND MEETING THE REQUIREMENTS OF ALL GOVERNING CODES.

BASE

CABINET

BOXES OVER KITCHEN CABINETS

PROVIDE AND INSTALL GROUND FAULT CIRCUIT-INTERRUPTERS (GFI) AS REQUIRED BY NATIONAL ELECTRICAL CODE (NEC) AND MEETING THE REQUIREMENTS OF ALL GOVERNING CODES.

ELECTRICAL CONTRACTOR TO PROVIDE REQURIED DIRECT HOOK-UPS/CUTOFFS.


HVAC CONTRACTOR TO VERIFY THERMOSTAT LOCATIONS.


ALL ELECTRICAL AND MECHANICAL EQUIPMENT (FURNACES, A/C UNITS, ELECTRICAL PANELS, SANITARY SUMP PITS, DRAING TILE SUMP, AND WATER HEATERS) ARE SUBJECT TO RELOCATOIN DUE TO FIELD CONDITIONS.

-PROVIDE POWER, LIGHT AND SWITCH AS REQUIRED FOR ATTIC FURNACE PER CODE AND MANUFACTURER'S WRITTEN INSTRUCTIONS.

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LEGEND:					
φ	DUPLEX OUTLET	-0-	CEILING MOUNTED INCANDESCENT LIGHT FIXTURE		
₩P/GFI	WEATHERPROOF GFI DUPLEX OUTLET	5	WALL MOUNTED INCANDESCENT LIGHT FIXUTRE		
₽gfi	GROUND-FAULT CIRCUIT- INTERRUPTER DUPLEX OUTLET	Å	RECESSED INCANDESCENT LIGHT FIXTURE		
Q	HALF-SWITCHED DUPLEX OUTLET	μ¥	(VP) = VAPOR PROOF		
₽ 220V	220 VOLT OUTLET		EXHAUST FAN (VENT TO EXTERIOR)		
J	REINFORCED JUNCTION BOX	-0-	EXHAUST FAN/LIGHT COMBINATION (VENT TO EXTERIOR)		
\$	WALL SWITCH	<u> </u>	<u> </u>		
\$3	THREE-WAY SWITCH	\boxtimes	FLUORESCENT LIGHT FIXTURE		
\$4	FOUR-WAY SWITCH		L TECH HUB SYSTEM		
СН	CHIMES	\mathbb{A}	CEILING FAN (PROVIDE ADEQUATE SUPPORT)		
Ŧ	PUSHBUTTON SWITCH				
SD	110V SMOKE DETECTOR W/ BATTERY BACKUP		CEILING FAN WITH INCANDESCENT LIGHT FIXTURE (PROVIDE ADEQUATE SUPPORT)		
Co	CO2 DETECTOR				
T	THERMOSTAT		GAS SUPPLY WITH VALVE		
PH	TELEPHONE	<u> </u>			
TV	TELEVISION		HOSE BIBB		
Ê	ELECTRIC METER	1—tv	1/4" WATER STUB OUT		
	ELECTRIC PANEL		WALL SCONCE		
	DISCONNECT SWITCH	1 8 1	TALL OUDIOL		



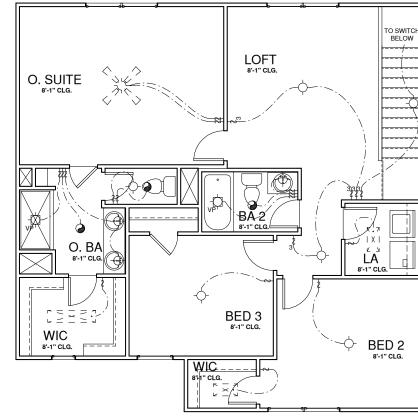

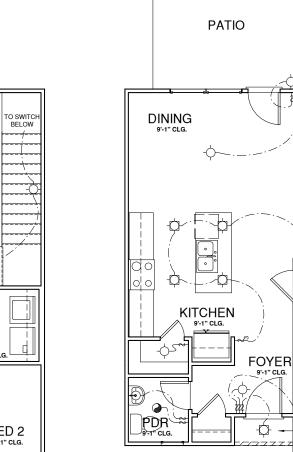

(1)

