SLAB PLANS STEMWALL PLANS CRAWL SPACE PLANS				
UNFINISHED BASEMENT PLAN 'A' FINISHED BASEMENT PLAN FLOOR PLAN 1' FLOOR PLAN 2' FLOOR PLAN 3' FLOOR PLAN 4' FLOOR PLAN 4' FLOOR PLAN 4' FLOOR PLAN 4' FLOOR PLAN 4' FLOOR PLAN 4' ELEVATIONS 1' ELEV OPTIONS ELEV OPTIONS ELEV OPTIONS ELEV OPTIONS COOF PLAN 1' ELEVATIONS 2' ROOF PLAN 2' ELEVATIONS 3' ROOF PLAN 3' BASEMENT UTILITY PLAN UTILITY PLANS - STD. PKG. UTILITY PLANS - OPT. PKG.			ELEV. 'A' AREA Name Area FIRST FLOOR 695 SF SECOND FLOOR 1037 SF HEATED 1732 SF GARAGE 369 SF PORCH 12 SF UNHEATED 401 SF	
			BUILDER	SET:
OLDER LOCATIONS, AS SHOWN PER PLAN. TYPICAL AT ALL	GEOTECHNICAL ENGINEER (SOILS REPORT), ON	N THE STUDY OF THE PROPOSED SITE,		S IS TO PROVIDE A "BUILDER'S SET" AND GENERAL NOTES HEREINAFTER REFERRED TO AS "PLANS".
		THE OWNER SHALL FURNISH ANY AND ALL REF OLDER LOCATIONS, AS SHOWN PER PLAN. TYPICAL AT ALL DEVOUER POORS, VERIFY LOCATIONS AT FRAMME WALK. TO THE DESIGNER, STRUCTURAL ENGINEER,	NDER THE DIRECTION OF GMD DESIGN GROUPCAROLINAS, INC. GMD DESIGN GROUP CAROLINAS, INC. IE'S NO LIABILITY FOR THE COMPLETENESS OR CORRECTNESS OF THE COMPLETENESS OR CORRECTNESS OF THE COMPLEX STATUS OF THE COMPLEX OF THE COMPLEX. THE COMPLEX OF THE COMPLEX OF	

EN APPROVAL OF THE DESIGNER CONTRACTOR SHALL VERIFY ALL CONDITIONS AND DIMENSIONS AT THE SITE AND ALL INCONSISTENCES SHALL BE BROUGHT TO THE ATTENTION OF THE DEVELOPER AND THE DESIGNER BEFORE PROCEEDING WITH WORK.

ANY ERRORS OR OMISSIONS FOUND IN THESE DRAWINGS SHALL BE BROUGHT TO DEVELOPERS AND DESIGNERS ATTENTION IMMEDIATELY.

DO NOT SCALE DRAWINGS. WRITTEN DIMENSIONS TAKE PRECEDENCE OVER SCALED DIMENSIONS.

ALL DIMENSIONS ARE TO FACE OF STUD OR TO FACE OF FRAMING UNLESS OTHERWISE NOTED.

ALL TRUSS DRAWINGS TO BE REVIEWED AND APPROVED BY THE STRUCTURAL ENGINEER PRIOR TO ISSUANCE OF BUILDING PERMIT.

ALL OR EQUAL SUBSTITUTIONS MUST BE SUBMITTED TO AND APPROVED BY CITY BUILDING OFFICIAL PRIOR TO INSTALLATION.

ALL ANGLED PARTITIONS ARE 45 DEGREES UNLESS OTHERWISE NOTED. PROVIDE FIREBLOCKING. (PER LOCAL CODES.)

ALL ELECTRICAL AND MECHANICAL EQUIPMENT AND METERS ARE SUBJECT TO RELOCATION DUE TO FIELD CONDITIONS, CONTRACTOR TO VERIFY.

ELASTOMERIC SHEET WATERPROOFING: FURNISH AND INSTALL ALL WATERPROOFING LEOSTOWENED SITUET TRAFET TO SUBJ OWNED AND INFORCE ALC INFORMATION OF COMPLETE. A 00 MIL SELF-ADHERING MEMBRANE OF RUBBERIZED ASPHALT INTEGRALLY BONDED TO POLYETHYLENE SHEETING, OR EQUAL INSTALL PER MANUFACTURES AND TRADE ASSOCIATIONS PRINTED INSTALLATION INSTRUCTIONS. 6° MINIMUM LAP AT ALL ADJACENT WALL SURFACES.

TO THE BEST OF THE DESIGNER'S KNOWLEDGE THESE DOCUMENTS ARE IN CONFORMANCE WITH THE REQUIREMENTS OF THE BUILDING AUTHORITIES HAVING JURISDICTION OVER THIS TYPE OF CONSTRUCTION AND OCCUPANCY.

SHOP DRAWING REVIEW AND DISTRIBUSTION, ALONG WITH PRODUCT SUBMITTALS, REQUESTED IN THE CONSTRUCTION DOCUMENTS, SHALL BE THE SOLE RESPONSIBILITY OF THE GENERAL CONTRACTOR, UNLESS DIRECTED OTHERWISE

UNDER A SEPARATE AGREEMENT. DEVIATIONS FROM THESE DOCUMENTS IN THE CONSTRUCTION PHASE SHALL BE REVIEWED BY THE DESIGNER AND THE OWNER PRIOR TO THE START OF WORK IN OUESTION, ANY DEVIATIONS FROM THESE DOCUMENTS WITHOUT PRIOR REVIEW, SHALL BE THE SOLE RESPONSIBILITY OF THE GENERAL CONTRACTOR.

THE GENERAL CONTRACTOR SHALL BE RESPONSIBLE FOR ALL WORK AND MATERIALS REPRESENTED ON THESE DOCUMENTS INCLUDING THE WORK AND MATERIALS FURNISHED BY SUBCONTRACTORS AND VENDORS.

EVENT THE GEOTECHNICAL REPORTS DO NOT EXIST, THE SOILS CONDITION SHALL EVENT THE GEOLECTIONAL REPORTS OUNO EXAMPLE SOLIS CONDITIONS TABLE BE ASSUMED TO BE A MINIMUM DISCINS OLI PRESSINGE STATE DE STITUE STRUCTURAL ENGINEER OF RECORD FOR THE PURPOSE OF STRUCTURAL DESIGN. GENERAL CONTACTOR SHALL ASSURE THE SOIL CONDITIONS MEET OR EXCEED THE CRITERIA.

THE CHILENAL ALL WORK PERFORMED BY THE GENERAL CONTRACTOR SHALL COMPLY AND CONFORM WITH LOCAL AND STATE BUILDING CODES, ORDINANCES AND REGULATIONS, ALONG WITH ALL OTHER AUTHORITIES HAVING JURISDICTION. THE GENERAL CONTRACTOR IS RESPONSIBLE TO BE AWARE OF THESE REQUIREMENTS AND GOVERNING REGULATIONS.

PROVIDE AN APPROVED WASHER DRAIN PAN AT SECOND FLOOR ONLY THAT DRAINS TO EXTERIOR.

INAL DURING TO CARLINGT, AT LEAST ONE WINDOW IN ALL BEDROOMS TO HAVE A CLEAR OPENABLE AREA OF 4 NO SO FT. THE MINIMUM NET CLEAR OPENNG HEIGHT SHALL BE 22' NAU THE MINIMUM PET CLEAR OPENNG HEIGHT SHALL BE 22' CLAURE TO TAL AREA OF ANT LEAST THAN 5.0 SQ FT IN THE CASE OF A GROUND WINDOW AND NOT LESS THAN 5.7 SQ FT IN THE CASE OF AN UPPER STORY WINDOW. (PER NCRC SECTION R310.1.1)

ALL HANDRAIL BALLUSTERS TO BE SPACED SUCH THAT A 4" SPHERE CANNOT PASS BETWEEN BALLUSTERS. (PER LOCAL CODES.) PROVIDE STAIR HANDRAILS AND GUARDRAILS PER LOCAL CODES.

THIS SET OF PLANS IS SUFFICIENT TO OBTAIN A BUILDING PERMIT: HOWEVER, ALL MATERIALS THIS SET OF PLANS IS SUFFICIENT TO OD I AIM A BUILDING PEHMIT; HOWEVEH, ALL MATEHIALS AND METHODS OF CONSTRUCTION NECESSARY TO COMPLETE THE PROJECT ARE NOT NECESSARILY DESCRIBED. THE PLANS DELINEATE AND DESCRIBE ONLY LOCATIONS. DIMENSIONS, TYPES OF MATERIALS, AND GENERAL METHODS OF ASSEMBLING OR FASTENING. THEY ARE NOT INTENDED TO SPECIFY PARTICULAR PRODUCTS OR OTHER METHODS OF ANY SPECIFIC MATERIALS, PRODUCT OR METHOD. THE IMPLEMENTATION OF THE PLANS REQUIRES A CULENT / CONTRACTOR THOROUGHLY KNOWLEDGEABLE: WITH THE APPLICABLE BUILDING CODES AND METHODS OF CONSTRUCTION SPECIFIC TO THIS PRODUCT TYPE AND TYPE OF CONSTRUCTION.

CONSTRUCTION REQUIREMENTS AND QUALITY: PROVIDE WORK OF THE SPECIFIC QUALITY: WHERE QUALITY LEVEL IS NOT INDICATED, PROVIDE WORK OF QUALITY CUSTOMARY IN SIMILAR TYPES OF WORK. WHERE THE PLANS AND SPECIFICITIONS, CODES, LINS, REQULATIONS, MANUFACTURERS RECOMMENDATIONS OF INDUSTRY STANDARDS REQUIRE WORK OF HIGHER QUALITY OR PERFORMANCE, PROVIDE WORK COMPLYING WITH THOSE REQUIREMENTS AND QUALITY. WHERE TWO OF MORE QUALITY PROVISIONS OF THOSE REQUIREMENTS AND QUALITY. WHERE TWO OF MORE QUALITY PROVISIONS OF THOSE REQUIREMENTS AND QUALITY. WHERE TWO OF MORE QUALITY PROVISIONS OF THOSE REQUIREMENTS AND PROTECT WITH THE MOST STRINGENT REQUIREMENT; WHERE REQUIREMENTS CONFLICT WITH THE MOST STRINGENT REQUIREMENT; WHERE REQUIREMENTS AND STRINGENT, OBTAIN CLARIFICATION FROM THE ARCHITECT BEFORE PROCEEDING.

DEN 1732

NORTH CAROLINA OFFICE
102 FOUNTAIN BROOK CIRCLE
SUITE C
CARY, NC 27511
PHONE: (919) 320-3022

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PROF	ESSIONAL	SEAL:

ELEV. 'C' AREA Name FIRST FLOOR Area 707 SF SECOND FLOOR HEATED 1024 SF 1731 SF ARAGE 388 SF 26 SF JNHEATED 414 SF

ELEV. 'D	' AREA
Name	Area
FIRST FLOOR	707 SF
SECOND FLOOR	1024 SF
HEATED	1731 SF
GARAGE	388 SF
PORCH	26 SF
JNHEATED	414 SF

IAL SF Area 455 SF 455 SF IENT 181 SF 120 SF

PROJECT TITLE:

CAMDEN



4-13-22

SHEET NO:

T-1

NOTES FOR NORTH CAROLINA:

RRIGATION SYSTEM SHALL BE DESIGNED TO PREVENT THE SATURATION OF SOIL ADJACENT TO BUILDING.

THIS PERIMETER DIMENSION PLAN IS FOR DIMENSIONAL INFORMATION ONLY. SLOPE ALL STOOPS AND HARDSCAPE MATERIAL AWAY FROM BUILDING - TYPICAL.

SLOPE GARAGE FLOOR 1/8" PER FOOT TO GARAGE DOOR OPENING.

VERIFY CURB CUT BLOCKOUT WITH GARAGE DOOR MANUFACTURER.

- REFER TO CIVIL DRAWINGS FOR FINISH SURFACE ELEVATIONS.

FINISH GRADE SHALL PROVIDE POSITIVE DRAINAGE AWAY FROM BUILDING. REFER TO SOILS REPORT FOR ANY SPECIFIC REQUIREMENTS.

REFER TO STRUCTURAL DRAWINGS FOR HOLDDOWNS, FOOTING DETAILS, CURB THICKNESS, AND INFORMATION NOT SHOWN ON THIS PLAN.

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FOR THE USE OF EXPOSED GAS WATER HEATERS IN THE GARAGE, PROTECT THE WATER HEATER WITH 3" DIA CONCRETE FILLED STEEL PIPE EMBEDDED INTO CONCRETE FOOTING.

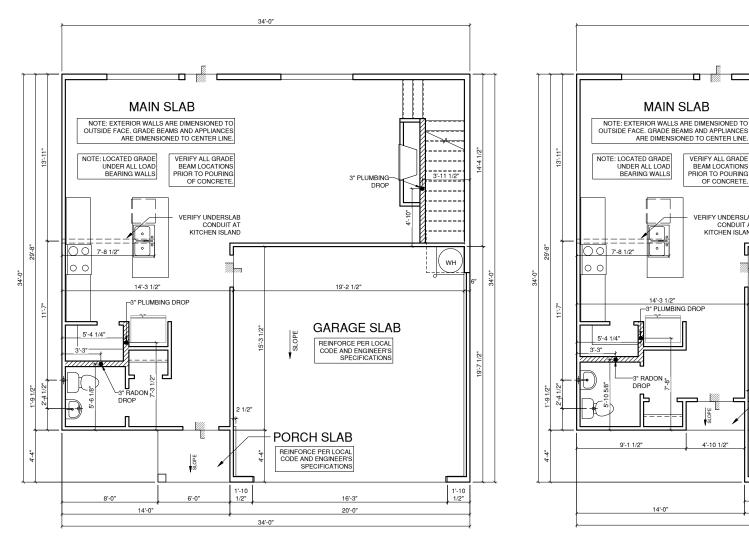
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REFER TO STRUCTURAL DRAWINGS FOR ALL FOUNDATION DIMENSIONS

FO	UNDATION KEYNOTE LEGEND
	-

LINE OF FRAMED WALL ABOV



(2) SLAB PLAN '2', '3' & '4' 1/4" = 1'-0" AT 22'X34" LAYOUT 1/8" = 1'-0" AT 11" X 17" LAYOUT

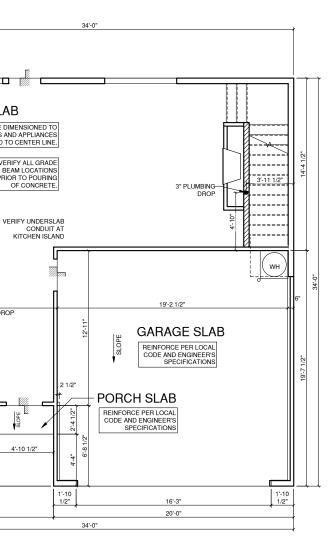
(1) **SLAB PLAN '1'** (1) 1/4" = 1'-0" AT 22"X34" LAYOUT 1/8" = 1'-0" AT 11" X 17" LAYOUT

VERIFY ALL GRADE

BEAM LOCATIONS PRIOR TO POURING OF CONCRETE.

SLOPE

4'-10 1/2"





NORTH CAROLINA OFFICE TUZ FOUNTAIN BROOK CIRCLE SUITE C CARY, NG 27511 PHONE: (919) 320-3022 THESE PLANS AND SPECIFICATIONS ARE PROTECTED UNDER FEDERAL COPYRIGHT LAWS 92016, GMD DESIGN GROUF CAROLINAS, NON PRIVILEGES. NO: DATE: REVISION: PROJECT TITLE: CAMDEN PROJECT TITLE: CAMDEN CLIENTS NAME: QUACKENBUSH HOMES SHEET TITLE: SLAB PLANS PRIVIT DATE: PRIVIT DATE: PRIVIT DATE: ACTION: SHEET NO: CLIENTS NOT PRIVILED PRIVIT DATE: CAMOLASSING PRIVIT PRIVILESSING PRIVIT DATE: CAMOLASSING PRIVIT DATE: CAMOLASSING PRIVIT DATE: CAMOLASSING PRIVIT DATE: CAMOLASSING PRIVIT DATE: CAMOLASSING PRIVIT DATE: CAMOLASSING PRIVIT DATE: CAMOLASSING PRIVIT PRIVITES PRIVIT PRIV			
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NOTES FOR NORTH CAROLINA:

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SLOPE GARAGE FLOOR 1/8" PER FOOT TO GARAGE DOOR OPENING.

VERIFY CURB CUT BLOCKOUT WITH GARAGE DOOR MANUFACTURER.

REFER TO CIVIL DRAWINGS FOR FINISH SURFACE ELEVATIONS FINISH GRADE SHALL PROVIDE POSITIVE DRAINAGE AWAY FROM BUILDING, REFER TO SOILS

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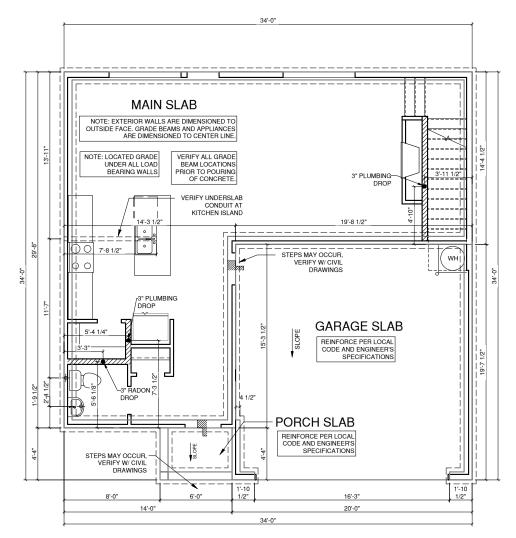
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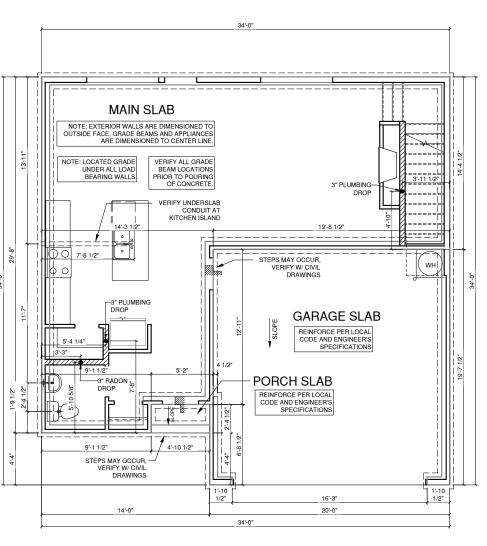
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REFER TO STRUCTURAL DRAWINGS FOR ALL FOUNDATION DIMENSIONS

FOUNDATION KEYNOTE LEGEND

LINE OF SLAB ABOVE	
LINE OF FRAMED WALL	ABOV





² STEMWALL PLAN '2', '3' & '4' 1/4" = 1'-0" AT 22"X34" LAYOUT 1/8" = 1'-0" AT 11" X 17" LAYOUT



¹ STEMWALL PLAN '1'

1/4" = 1'-0" AT 22"X34" LAYOUT 1/8" = 1'-0" AT 11" X 17" LAYOUT

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CRAWL SPACE NOTES FOR NORTH CAROLINA:

REFER TO STRUCTURAL DRAWINGS FOR INFORMATION NOT SHOWN ON THIS PLAN.

-FOR ADDITIONAL NOTES SEE GENERAL NOTES ON TITLE SHEET AND DETAILS.

PROVIDE FIREBLOCKING. (PER NCRC SECTION R602.8)

-ALL ELECTRICAL AND MECHANICAL EQUIPMENT AND METERS ARE SUBJECT TO RELOCATION DUE TO FIELD CONDITIONS, CONTRACTOR TO VERIFY

-VERIEVALL DOOR THRESHOLD HEIGHTS TO HARD S URFACES. 8 1/4" MAX AT INSWING DOORS. (PER NCRC SECTION R311.3.1)

SLOPE ALL STOOPS AND HARDSCAPE MATERIAL AWAY FROM BUILDING - TYPICAL

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-TYP. STOOP AT INSWING/SLIDER DOORS: 36" DEEP BY THE WIDTH OF THE DOOR SERVED. MINIMUM (PER NCRC SECTIONS R311.3) PROVIDE A SLIP-RESISTANT FINISH

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APPLY AN APPROVED VAPOR RETARDER OR EQUIVALENT, 6 MIL POLY-VINYL, GROUND COVER OVER FINISH GRADE OR CRAWL SPACE PER NCRC SECTION 408.2

-PROVIDE VENTS SPACED ABOUND PERIMETER TO PROMOTE CROSS VENTILATION AT A BATE OF 1 SE VENT FOR EVERY 1500 SE OF CRAWL FLOOR AREA. ONE VENT MUST BE LOCATED WITHIN 3-0" OF EACH CORNER OF THE BUILDING AND LOCATED TO ALLOW FOR CROSS VENTILATION. (PER NCRC SECTION R408.1.1 EXCEPTION.)

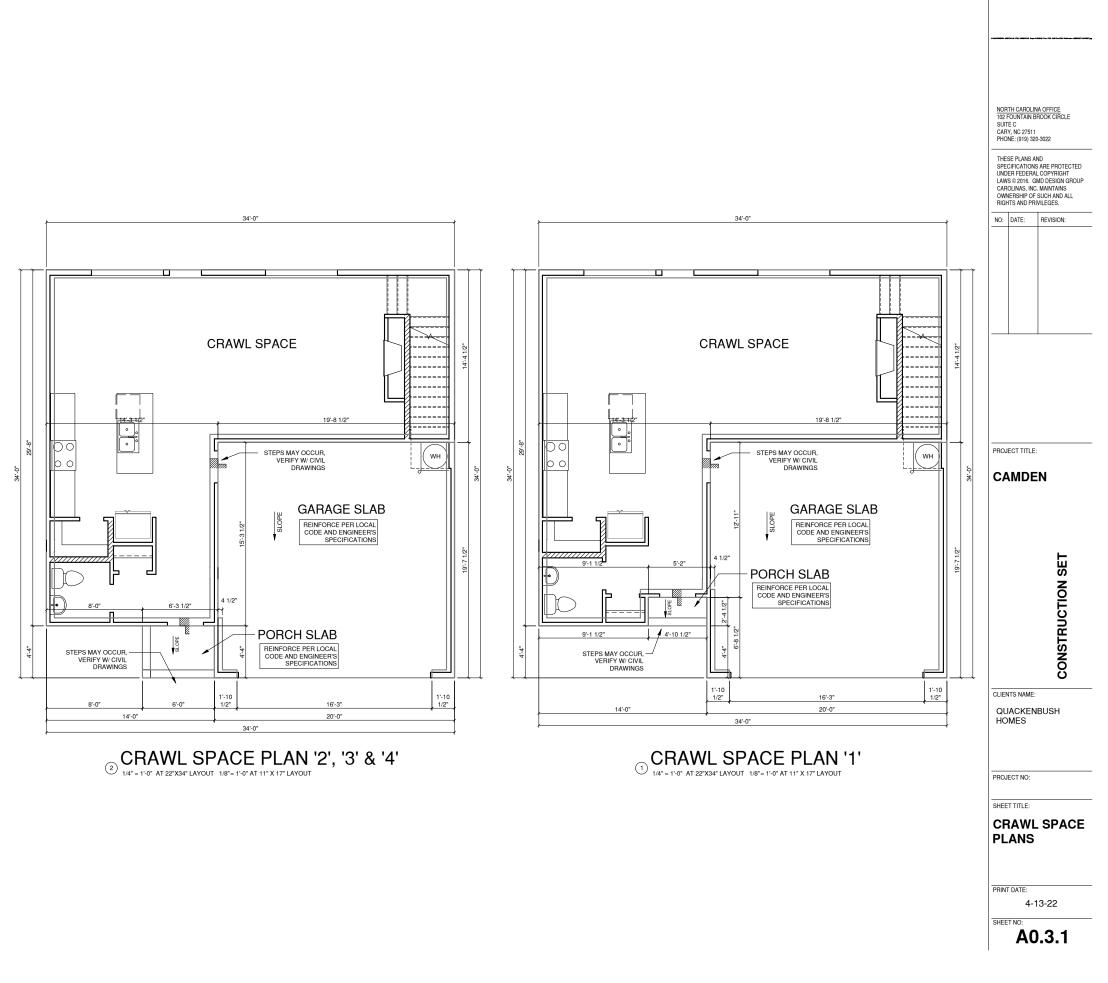
-PROVIDE AN ACCESS OPENING, MINIMUM SIZE OF 18"X24" FOR CRAWL ACCESS. COORDINATE WITH MECHANICAL CONTRACTOR FOR LARGER SIZE REQUIREMENTS IF MECHANICAL EQUIPMENT IS LOCATED IN CRAWL. (PER NCRC SECTION 408.8)

-WOOD CONTACTING CONCRETE OR MASONRY OR LESS THAN CODE REQUIRED SEPARATION TO GRADE SHALL BE PRESSURE TREATED OR FOUNDATION GRADE REDWOOD. SET ALL EXTERIOR WALL SILLS IN MASTIC.

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FOUNDATION KEYNOTE LEGEND

LINE OF SLAB ABOVE LINE OF FRAMED WALL ABO



BASEMENT NOTES FOR NORTH CAROLINA:

-ALL ANGLED PARTITIONS ARE 45 DEGREES UNLESS OTHERWISE NOTED.

FOR ADDITIONAL NOTES SEE GENERAL NOTES ON TITLE SHEET AND DETAILS.

WINDOW HEAD HTS: BASEMENT = 6'-8" U.N.O. ON ELEVATIONS

PROVIDE FIREBLOCKING. (PER NCRC SECTION R602.8)

-WINDOW SUPPLIER TO VERIFY AT LEAST ONE WINDOW IN ALL BEDROOMS TO HAVE A CLEAR OPENABLE AREA OF 4.0 SQ FT. THE MINIMUM NET CLEAR OPENING HEIGHT SHALL BE 22" AND THE MINIMUM NET CLEAR OPENING WIDTH SHALL BE 20". GLAZING TOTAL AREA OF NOT LESS THAM 5.0 SQ FT IN THE CASE OF A GROUND WINDOW AND NOT LESS THAN 5.7 SQ FTIN THE CASE OF AN UPPER STORY WINDOW (PER NCRC SECTION R301.1.1)

ALL ELECTRICAL AND MECHANICAL EQUIPMENT AND METERS ARE SUBJECT TO RELOCATION DUE TO FIELD CONDITIONS, CONTRACTOR TO VEBIEY.

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-VERIFY ALL DOOR THRESHOLD HEIGHTS TO HARD SURFACES. 8 1/4" MAX AT INSWING DOORS. (PER NCRC SECTIONR311.3.1)

SLOPE ALL STOOPS AND HARDSCAPE MATERIAL AWAY FROM BUILDING - TYPICAL.

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-VERIEY CUBB CUT BLOCKOUT WITH GABAGE DOOR MANUFACTUBER.

-REFER TO CIVIL DRAWINGS FOR FINISH SURFACE ELEVATIONS.

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WALL LEGEND

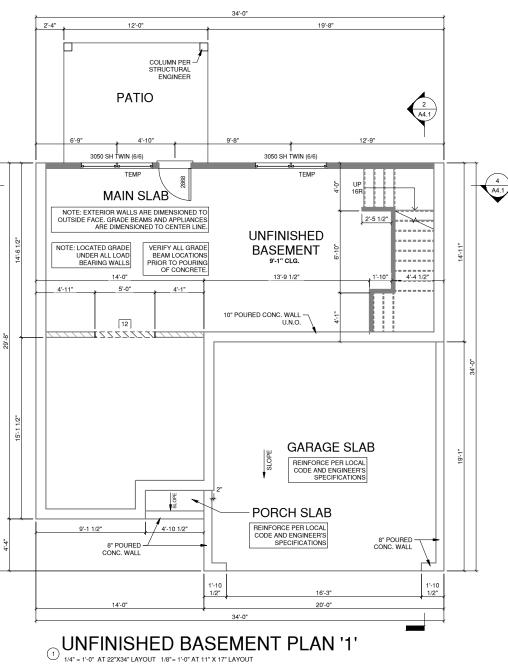
FULL HEIGHT	FULL HEIGHT
2X4 WOOD STUD PARTITION	2X6 WOOD STUD PARTITION
STONE VENEER	DRYWALL OPENING HEIGHT AS NOTED ON PLAN
777777	
BRICK VENEER	
STUD WALL BELOW HEIGHT AND STUD SIZE AS N	OTED

FOUNDATION KEYNOTE LEGEND

1	LINE OF SLAB ABOVE
2	LINE OF FRAMED WALL ABOVE

	FLOOR PLAN KEYNOTE LEGEND
1	HOUSE TO GARAGE FIRE SEPARATION, GARAGE/HOUSE SEPARATION AT VERTICAL SUFFACES SHALL BE PROTECTED WITH ONE (1) LAYER 1/2" GYPSUM BOARD, GARAGE/HOUSE SEPARATION AT HORIZONTAL SUFFACES SHALL BE PROTECTED WITH ONE (1) LAYER 30" TYPE "X" GYPSUM BOARD
2	HOUSE TO GARAGE DOOR SEPARATION. PROVIDE 1 3/8" SOLID CORE DOOR OR APPROVED 20 MINUTE RATED DOOR
4	GAS WATER HEATER ON 18" HIGH PLATFORM
7	PRE-FABRICATED METAL FIREPLACE, INSTALL PER MANUFACTURER WRITTEN INSTRUCTIONS
9	TEMPERED SAFETY GLASS
11	HALF WALL, HEIGHT AS NOTED
12	INTERIOR SOFFITS: FFL = 8'-1" U.N.O. SFL = 7'-6" U.N.O., OPT. CASED OPENING U.N.O.
13	SHOWER, TEMPERED GLASS ENCLOSURE
14	TUB-SHOWER COMBO
16	SLIDE-IN ELECTRICAL RANGE W/ HOOD AND MICRO ABV. VENT PER MANUFACTURER'S WRITTEN

INSTRUCTIONS
INSTRUCTIONS
ACCESS HATCH/DOOR. FULLY WEATHER STRIPPED AND INSULATED. (PER NCRC SECTION N1102.2.3)



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BASEMENT NOTES FOR NORTH CAROLINA:

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-VERIFY CURB CUT BLOCKOUT WITH GARAGE DOOR MANUFACTURER

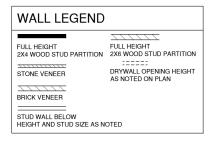
-REFER TO CIVIL DRAWINGS FOR FINISH SURFACE ELEVATIONS.

-TYP, STOOP AT INSWING/SLIDER DOORS: 36" DEEP BY THE WIDTH OF THE DOOR SERVED, MINIMUM (PER NCRC SECTIONS R311.3) PROVIDE A SLIP-RESISTANT FINISH.

SOILS TREATMENT: BORACARE TERMITE TO BE APPLIED TO FRAMING PER PRODUCT SPECIFICATIONS. (PROVIDE CHEMICAL TREATMENT FOR PROTECTION FROM TERMITE INVESTATION ACCORDING TO THE STANDARDS OF THE NC DEPT. OF AGRICULTURE.)

-WOOD CONTACTING CONCRETE OR MASONRY OR LESS THAN CODE REQUIRED SEPERATION TO GRADE SHALL BE PRESSURE TREATED OR FOUNDATION GRADE REDWOOD. SET ALL EXTERIOR WALL SILLS IN MASTIC.

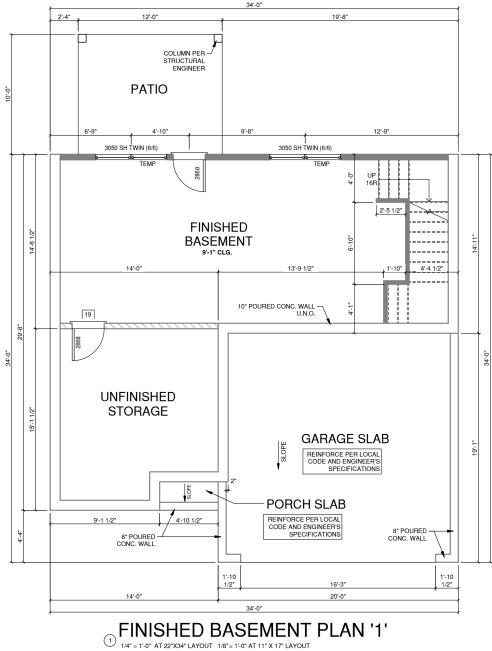
REFER TO STRUCTURAL DRAWINGS FOR ALL FOUNDATION DIMENSIONS



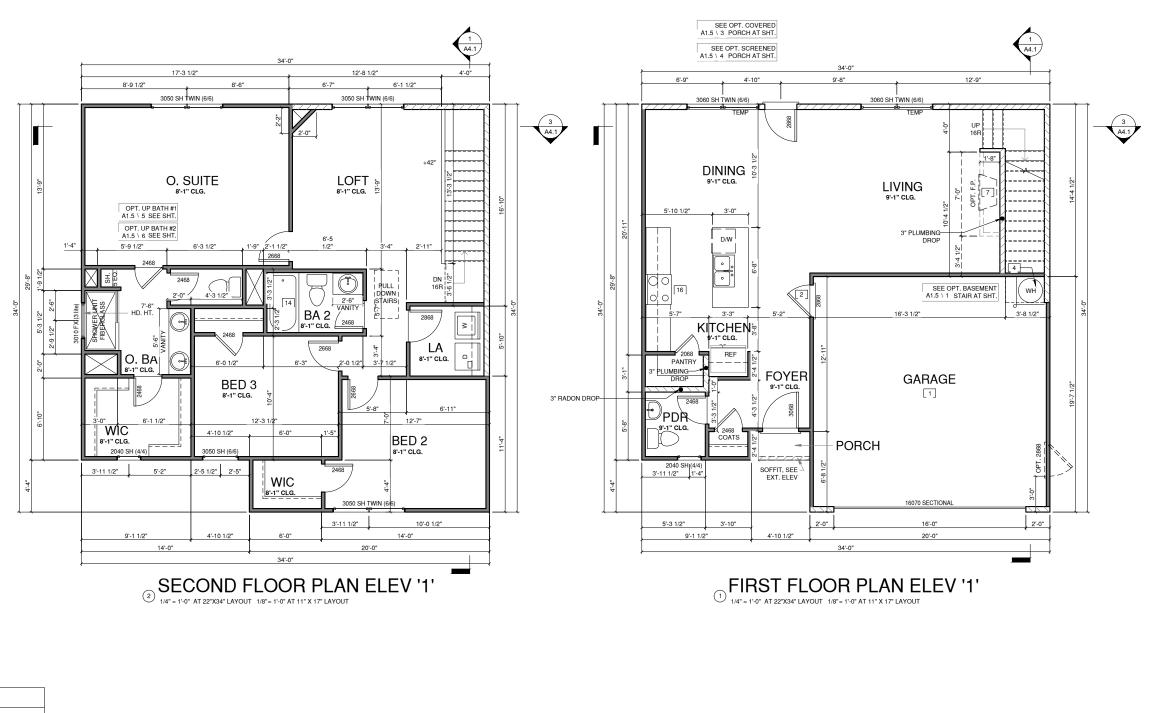
FOUNDATION KEYNOTE LEGEND LINE OF SLAB ABOVE LINE OF FRAMED WALL ABOVE

	FLOOR PLAN KEYNOTE LEGEND
1	HOUSE TO GARAGE FIRE SEPARATION, GARAGE/HOUSE SEPARATION AT VERTICAL SURFACES SHALL BE PROTECTED WITH ONE (1) LAYER 1/2" GYPSUM BOARD. GARAGE/HOUSE SEPARATION AT HORIZONTAL SURFACES SHALL BE PROTECTED WITH ONE (1) LAYER 5/8" TYPE "X" GYPSUM BOARD
2	HOUSE TO GARAGE DOOR SEPARATION. PROVIDE 1 3/8" SOLID CORE DOOR OR APPROVED 20 MINUTE RATED DOOR
4	GAS WATER HEATER ON 18" HIGH PLATFORM
7	PRE-FABRICATED METAL FIREPLACE, INSTALL PER MANUFACTURER WRITTEN INSTRUCTIONS
9	TEMPERED SAFETY GLASS
11	HALF WALL, HEIGHT AS NOTED
12	INTERIOR SOFFITS: FFL = 8'-1" U.N.O. SFL = 7'-6" U.N.O., OPT. CASED OPENING U.N.O.
13	SHOWER, TEMPERED GLASS ENCLOSURE
14	TUB-SHOWER COMBO
16	SLIDE-IN ELECTRICAL RANGE W/ HOOD AND MICRO ABV. VENT PER MANUFACTURER'S WRITTEN INSTRUCTIONS





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WALL LEGEND

FULL HEIGHT 2X4 WOOD STUD PARTITION	FULL HEIGHT 2X6 WOOD STUD PARTITION
STONE VENEER	DRYWALL OPENING HEIGHT AS NOTED ON PLAN
BRICK VENEER	
STUD WALL BELOW	OTED

FLOOR PLAN KEYNOTE LEGEND

1	HOUSE TO GARAGE FIRE SEPARATION, GARAGE/HOUSE SEPARATION AT VERTICAL SUFFACES SHALL BE PROTECTED WITH ONE (1) LAYER 1/2" GYPSUM BOARD, GARAGE/HOUSE SEPARATION AT HORIZONTAL SURFACES SHALL BE PROTECTED WITH ONE (1) LAYER 5/8" TYPE "X" GYPSUM BOARD
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14	TUB-SHOWER COMBO
16	SLIDE-IN ELECTRICAL RANGE W/ HOOD AND MICRO ABV. VENT PER MANUFACTURER'S WRITTEN INSTRUCTIONS
19	ACCESS HATCH/DOOB, FULLY WEATHER STRIPPED AND INSULATED. (PER NCBC SECTION N1102.2.3)

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FLOOR PLAN '1'

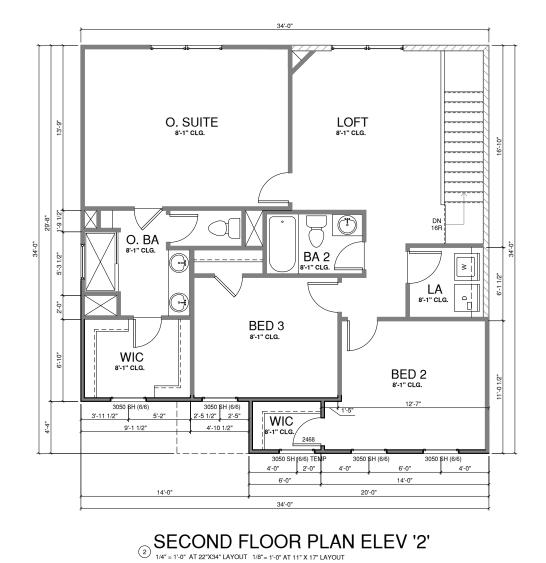
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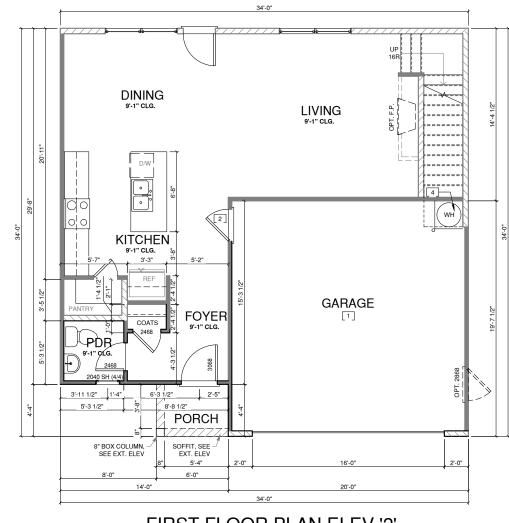
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PRINT DATE:

SHEET NO:





(1) **FIRST FLOOR PLAN ELEV '2'** (1) 1/4" = 1'-0" AT 22"X34" LAYOUT 1/8" = 1'-0" AT 11" X 17" LAYOUT

WALL LEGEND		
FULL HEIGHT 2X4 WOOD STUD PARTITION STONE VENEER	FULL HEIGHT 2X6 WOOD STUD PARTITIO :::::: DRYWALL OPENING HEIGH AS NOTED ON PLAN	
BRICK VENEER	DTED	

FLOOR PLAN KEYNOTE LEGEND

- HOUSE TO GARAGE FIRE SEPARATION, GARAGE/HOUSE SEPARATION AT VERTICAL SURFACES SHALL BE PROTECTED WITH ONE (1) LAYER 1/2' GYPSUM BOARD. GARAGE/HOUSE SEPARATION AT HORIZONTAL SURFACES SHALL BE PROTECTED WITH ONE (1) LAYER 3/8' TYPE 'X' GYPSUM BOARD HOUSE TO GARAGE DOOR SEPARATION. PROVIDE 1 3/8' SOLID CORE DOOR OR APPROVED 20 MINUTE RATED DOOR GAS WATER HEATER ON 18' HIGH PLATFORM PRE-FABRICATED METAL FIREPLACE, INSTALL PER MANUFACTURER WRITTEN INSTRUCTIONS TEMPERED SAFETY GLASS

- 9
 TEMPERED SAFETY GLASS

 11
 HALF WALL, HEIGHT AS NOTED

 12
 INTERIOR SOFFITS: FFL = 8'-1' U.N.O. SFL = 7'-6" U.N.O., OPT. CASED OPENING U.N.O.

 13
 SHOWER, TEMPERED GLASS ENCLOSURE

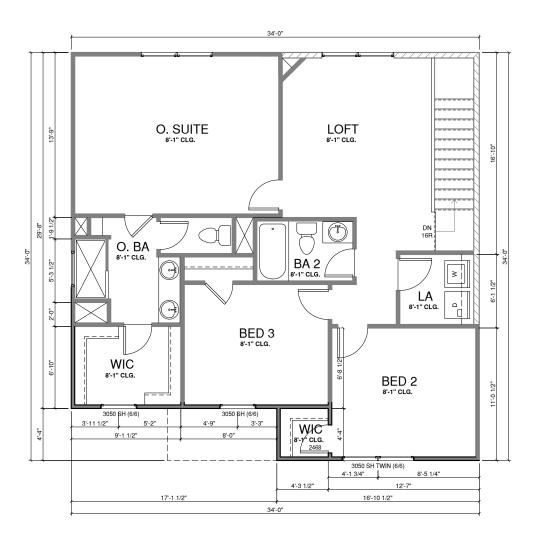
 14
 TUB-SHOWER COMBO

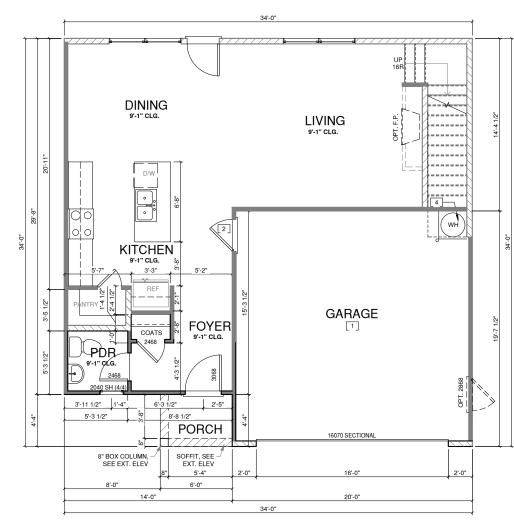
 16
 SLIDE-IN ELECTRICAL RANGE W/ HOOD AND MICRO ABV. VENT PER MANUFACTURER'S WRITTEN INSTRUCTIONS

 19
 ACCESS HATCH/DOOR. FULLY WEATHER STRIPPED AND INSULATED. (PER NCRC SECTION N1102.2.3)

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WALL LEGEND

FULL HEIGHT 2X4 WOOD STUD PARTITION	FULL HEIGHT 2X6 WOOD STUD PARTITION
STONE VENEER	CONTRACTOR
777777	
BRICK VENEER	
STUD WALL BELOW HEIGHT AND STUD SIZE AS N	OTED

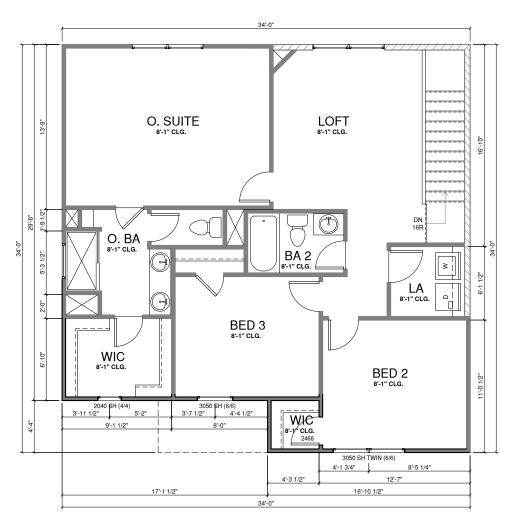
(2) SECOND FLOOR PLAN ELEV '3' (2) 1/4*= 1*-0* AT 22*X34* LAYOUT 1/8*= 1*-0* AT 11* X 17* LAYOUT

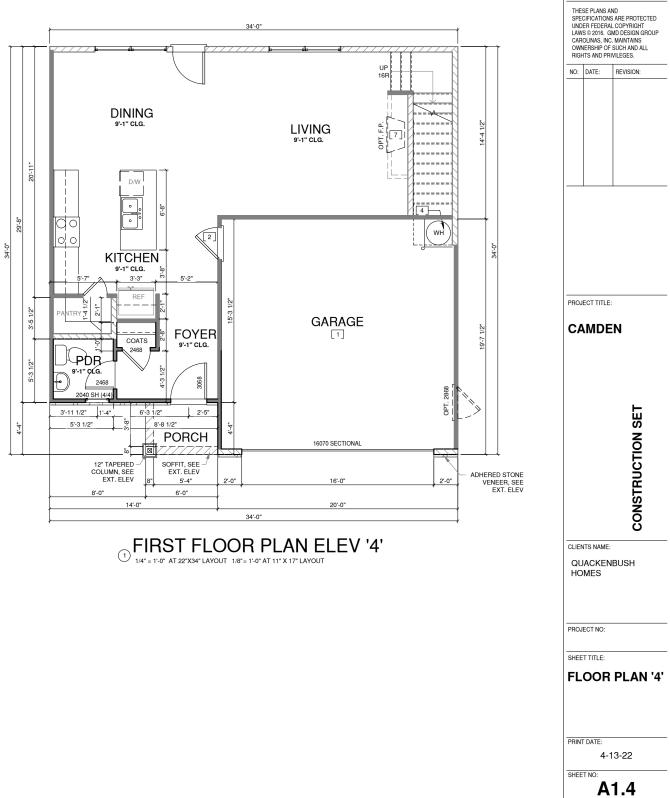
(1) **FIRST FLOOR PLAN ELEV '3'** 1/4" = 1'-0" AT 22"X34" LAYOUT 1/8" = 1'-0" AT 11" X 17" LAYOUT

FLOOR PLAN KEYNOTE LEGEND

1	HOUSE TO GARAGE FIRE SEPARATION, GARAGE/HOUSE SEPARATION AT VERTICAL SUPRACES SHALL BE PROTECTED WITH ONE (1) LAYER 1/2" GYPSUM BOARD. GARAGE/HOUSE SEPARATION AT HORIZONTAL SURFACES SHALL BE PROTECTED WITH ONE (1) LAYER 5/8" TYPE "X" GYPSUM BOARD
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9	TEMPERED SAFETY GLASS
11	HALF WALL, HEIGHT AS NOTED
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WALL LEGEND 777777 FULL HEIGHT FULL HEIGHT 2X4 WOOD STUD PARTITION 2X6 WOOD STUD PARTITION DRYWALL OPENING HEIGHT AS NOTED ON PLAN _____ STONE VENEER BRICK VENEER

STUD WALL BELOW HEIGHT AND STUD SIZE AS NOTED

FLOOR PLAN KEYNOTE LEGEND

1	HOUSE TO GARAGE FIRE SEPARATION, GARAGE/HOUSE SEPARATION AT VERTICAL SUPRACES SHALL BE PROTECTED WITH ONE (1) LAYER 1/2" GYPSUM BOARD. GARAGE/HOUSE SEPARATION AT HORIZONTAL SURFACES SHALL BE PROTECTED WITH ONE (1) LAYER 5/8" TYPE "X" GYPSUM BOARD
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19	ACCESS HATCH/DOOR, FULLY WEATHER STRIPPED AND INSULATED. (PER NCRC SECTION N1102.2.3)

(2) SECOND FLOOR PLAN ELEV '4'

NORTH CAROLINA OFFICE 102 FOUNTAIN BROOK CIRCLE

SUITE C CARY, NC 27511 PHONE: (919) 320-3022

WALL LEGEND

FULL HEIGHT 2X4 WOOD STUD PARTITION	FULL HEIGHT 2X6 WOOD STUD PARTITION
STONE VENEER	CONTRACTOR CRYWALL OPENING HEIGHT AS NOTED ON PLAN
777777	
BRICK VENEER	
STUD WALL BELOW HEIGHT AND STUD SIZE AS N	OTED

FLOOR PLAN KEYNOTE LEGEND

1	HOUSE TO GARAGE FIRE SEPARATION, GARAGE/HOUSE SEPARATION AT VERTICAL SURFACES SHALL BE PROTECTED WITH ONE (1) LAYER 1/2' GYPSUM BOARD. GARAGE/HOUSE SEPARATION AT HORIZONTAL SURFACES SHALL BE PROTECTED WITH ONE (1) LAYER 5/8' TYPE "X' GYPSUM BOARD
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4	GAS WATER HEATER ON 18" HIGH PLATFORM
7	PRE-FABRICATED METAL FIREPLACE, INSTALL PER MANUFACTURER WRITTEN INSTRUCTIONS
0	

- 7
 PHE-FABRICATED METAL FIREPLACE, INSTALL PEH MANUFACTURER WRITTEN INSTRUCTIONS

 9
 TEMPERED SAFETY GLASS

 11
 HALF WALL, HEIGHT AS NOTED

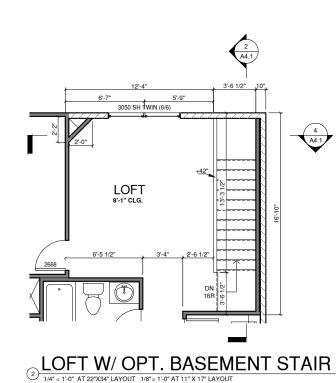
 12
 INTERIOR SOFFITS: FFL = 8'-1" U.N.O. SFL = 7'-6" U.N.O., OPT. CASED OPENING U.N.O.

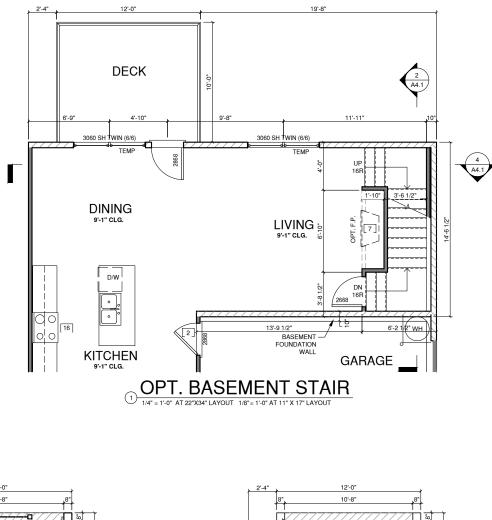
 13
 SHOWER, TEMPERED GLASS ENCLOSURE

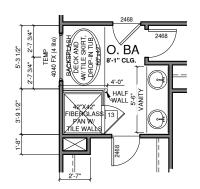
 14
 TUB-SHOWER COMBO

 16
 SLIDE-IN ELECTRICAL RANGE W/ HOOD AND MICRO ABV. VENT PER MANUFACTURER'S WRITTEN INSTRUCTIONS

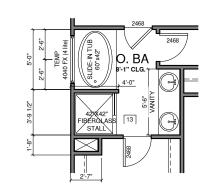
 19
 ACCESS HATCH/DOOR. FULLY WEATHER STRIPPED AND INSULATED. (PER NCRC SECTION N1102.2.3)



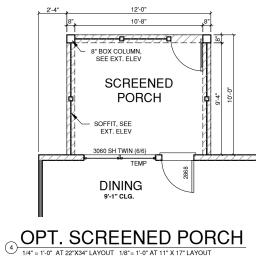


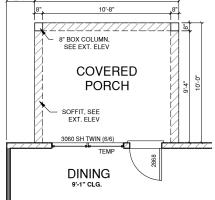


(6) OPT. UP BATH #2 (6) 1/4" = 1'-0" AT 22"X34" LAYOUT 1/8" = 1'-0" AT 11" X 17" LAYOUT



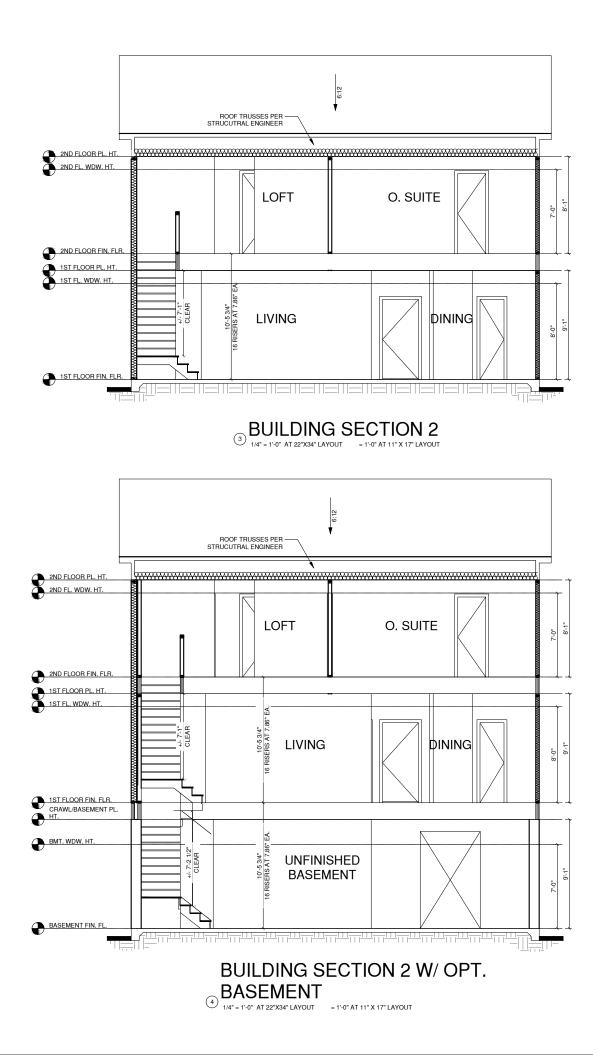
(5) OPT. UP BATH #1 (5) 1/4" = 1'-0" AT 22"X34" LAYOUT 1/8" = 1'-0" AT 11" X 17" LAYOUT

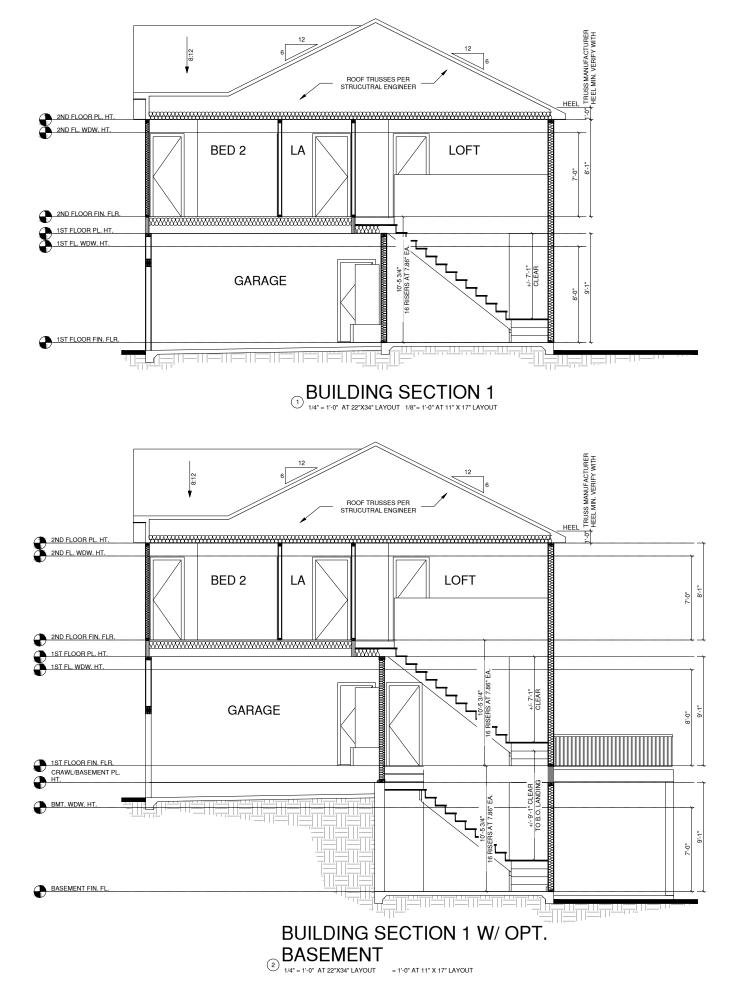






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	ELEVATION KEYNOTE LEGEND
E1	ADHERED STONE VENEER AS SELECTED BY DEVELOPER, HEIGHT AS NOTED
E7	FYPON OR EQUIVALENT LOUVERED VENT, SIZE AS NOTED
E9	CORROSION RESISTANT ROOF TO WALL FLASHING, CODE COMPLIANT FLASHING MUST BE INSTALLED AT ALL ROOF/WALL INTERSECTIONS
E12	FIBER CEMENT SHAKE SIDING PER DEVELOPER W/ 5/4x4 CORNER TRIM BOARDS
E13	FIBER CEMENT LAP SIDING PER DEVELOPER W/ 5/4x4 CORNER TRIM BOARDS
E15	FIBER CEMENT PANEL SIDING W/ 1X3 BATTS AT 16" O.C. (VINYL BOARD AND BATTEN SIDING)
E16	1X FIBER CEMENT TRIM OR EQUAL, U.N.O. SIZE AS NOTED
E17	FALSE WOOD/VINYL SHUTTERS, TYPE AS SHOWN, SIZE AS NOTED
E18	PROVIDE GUARDRAIL PER NCRC SECTION R312

-ALL EXTERIOR MATERIALS TO BE INSTALLED PER MANUFACTURER'S WRITTEN INSTRUCTIONS.

-CHIMNEY AS OCCURS: TOP OF CHIMNEYS TO BE A MINIMUM OF 24" ABOVE ANY ROOF WITHIN 10'-0" OF CHIMNEY.

ENTRY DOOR: AS SELECTED BY BUILDER

-WINDOWS: MANUFACTURER PER BUILDER. DIVIDED LITES AS SHOWN ON THE EXTERIOR ELEVATIONS

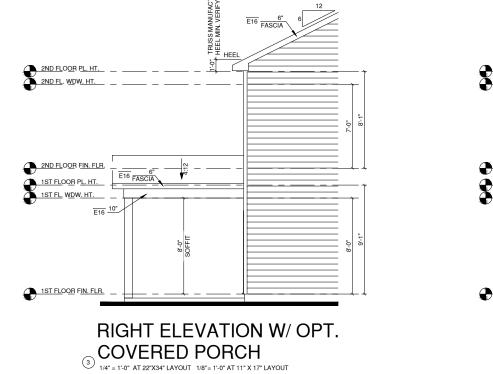
ROOFING: PITCHED SHINGLES PER BUILDER.

-WINDOW HEAD HEIGHTS: 1ST FLOOR = 8°-0" U.N.O. ON ELEVATIONS 2ND FLOOR = 7'-0" U.N.O. ON ELEVATIONS 3RD FLOOR = 7'-0" U.N.O. ON ELEVATIONS.

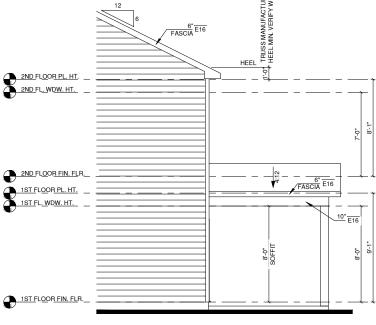
-GRADE CONDITIONS MAY VARY FOR INDIVIDUAL SITE FROM THAT SHOWN. BUILDER SHALL VERIFY AND COORDINATE PER ACTUAL SITE CONDITIONS.

NOTES:

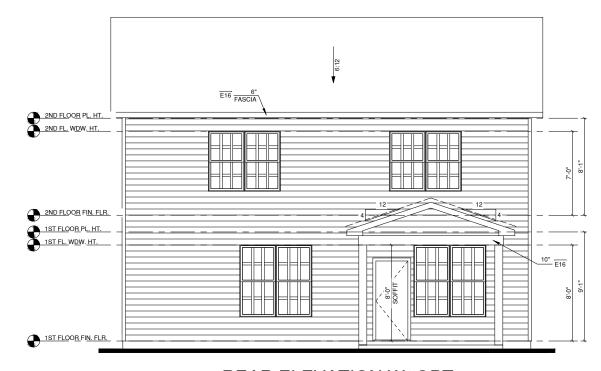
ALL WINDOWS WHOSE OPENING IS LESS THAN 24" ABOVE THE FINISH FLOOR AND WHOSE OPENING IS GREATER THAN 72" ABOVE THE OUTSIDE WALKING SURFACE MUST HAVE WINDOW OPENING LIMITING DEVICES COMPLYING WITH THE 2012 IRC SECTION R312.2.



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REAR ELEVATION W/ OPT. (1) **COVERED PORCH** (1) 1/4" = 1'-0" AT 22"X34" LAYOUT 1/8" = 1'-0" AT 11" X 17" LAYOUT





PRINT DATE:
4-13-22
SHEET NO:
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ELEV OPTIONS

SHEET TITLE:

PROJECT NO:

QUACKENBUSH HOMES

CLIENTS NAME:



CAMDEN

PROJECT TITLE:

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NORTH CAROLINA OFFICE 102 FOUNTAIN BROOK CIRCLE

	ELEVATION KEYNOTE LEGEND
E1	ADHERED STONE VENEER AS SELECTED BY DEVELOPER, HEIGHT AS NOTED
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ENTRY DOOR: AS SELECTED BY BUILDER

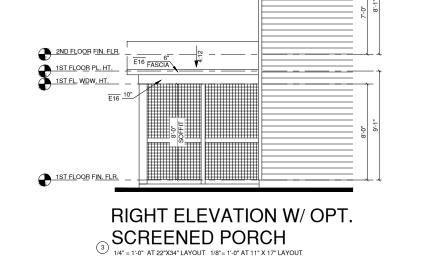
-WINDOWS: MANUFACTURER PER BUILDER. DIVIDED LITES AS SHOWN ON THE EXTERIOR ELEVATIONS

-WINDOW HEAD HEIGHTS: 1ST FLOOR = 8°-0" U.N.O. ON ELEVATIONS 2ND FLOOR = 7'-0" U.N.O. ON ELEVATIONS 3RD FLOOR = 7'-0" U.N.O. ON ELEVATIONS. ROOFING: PITCHED SHINGLES PER BUILDER.

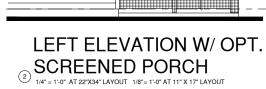
-GRADE CONDITIONS MAY VARY FOR INDIVIDUAL SITE FROM THAT SHOWN. BUILDER SHALL VERIFY AND COORDINATE PER ACTUAL SITE CONDITIONS.

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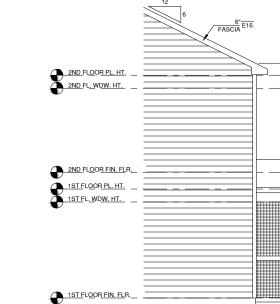


2ND FLOOR PL. HT. 2ND FL. WDW. HT. E16 FASCIA

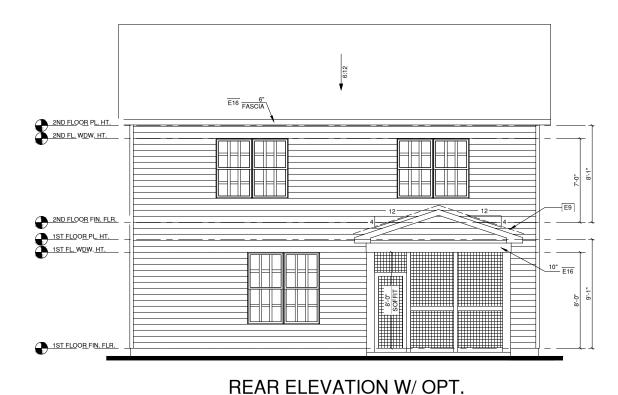


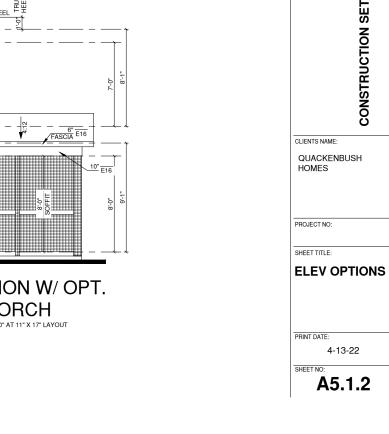
TRUSS MANUFACTURE HEEL MIN. VERIFY WITH

HEEL



(1) **SCREENED PORCH** 1/4" = 1'-0" AT 22"X34" LAYOUT 1/8" = 1'-0" AT 11" X 17" LAYOUT





PROJECT TITLE: CAMDEN

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NORTH CAROLINA OFFICE 102 FOUNTAIN BROOK CIRCLE

SUITE C CARY, NC 27511 PHONE: (919) 320-3022

	ELEVATION KEYNOTE LEGEND
E1	ADHERED STONE VENEER AS SELECTED BY DEVELOPER, HEIGHT AS NOTED
E7	FYPON OR EQUIVALENT LOUVERED VENT, SIZE AS NOTED
E9	CORROSION RESISTANT ROOF TO WALL FLASHING, CODE COMPLIANT FLASHING BE INSTALLED AT ALL ROOF/WALL INTERSECTIONS
E12	FIBER CEMENT SHAKE SIDING PER DEVELOPER W/ 5/4x4 CORNER TRIM BOARDS
E13	FIBER CEMENT LAP SIDING PER DEVELOPER W/ 5/4x4 CORNER TRIM BOARDS
E15	FIBER CEMENT PANEL SIDING W/ 1X3 BATTS AT 16" O.C. (VINYL BOARD AND BATTE SIDING)
E16	1X FIBER CEMENT TRIM OR EQUAL, U.N.O. SIZE AS NOTED
E17	FALSE WOOD/VINYL SHUTTERS, TYPE AS SHOWN, SIZE AS NOTED
E18	PROVIDE GUARDRAIL PER NCRC SECTION R312

-WINDOWS: MANUFACTURER PER BUILDER. DIVIDED LITES AS SHOWN ON THE EXTERIOR ELEVATIONS -ENTRY DOOR: AS SELECTED BY BUILDER

-ROOFING: PITCHED SHINGLES PER BUILDER.

-WINDOW HEAD HEIGHTS: 1ST FLOOR = 8'-0" U.N.O. ON ELEVATIONS 2ND FLOOR = 7'-0" U.N.O. ON ELEVATIONS 3RD FLOOR = 7'-0" U.N.O. ON ELEVATIONS.

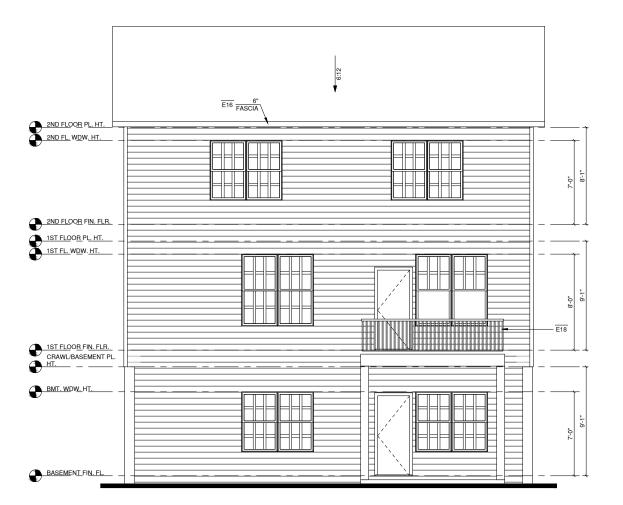
-GRADE CONDITIONS MAY VARY FOR INDIVIDUAL SITE FROM THAT SHOWN. BUILDER SHALL VERIFY AND COORDINATE PER ACTUAL SITE CONDITIONS.

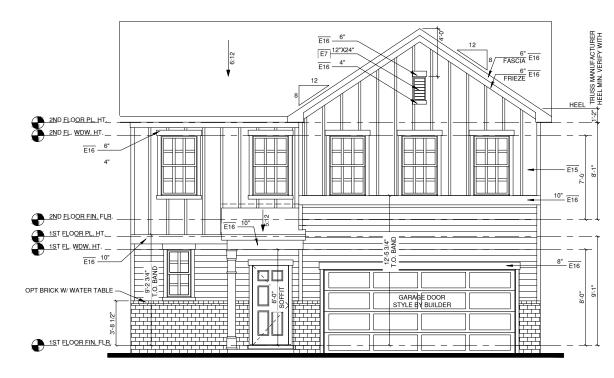
-CHIMNEY AS OCCURS: TOP OF CHIMNEYS TO BE A MINIMUM OF 24" ABOVE ANY ROOF WITHIN 10'-0" OF CHIMNEY.

NOTES:

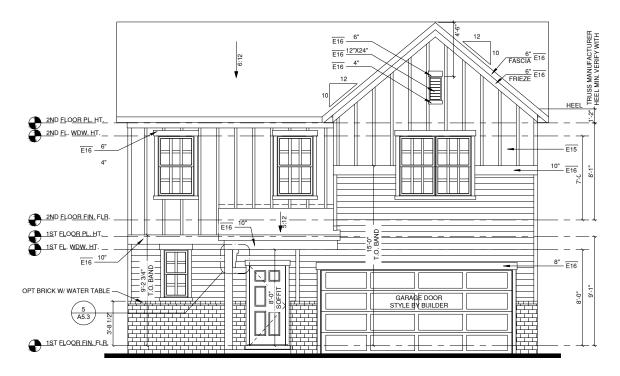
ALL WINDOWS WHOSE OPENING IS LESS THAN 24" ABOVE THE FINISH FLOOR AND WHOSE OPENING IS GREATER THAN 72" ABOVE THE OUTSIDE WALKING SURFACE MUST HAVE WINDOW OPENING LIMITAUE VICENS COMPLYING WITH THE 2012 IRC SECTION R312.2.

REAR ELEVATION W/ OPT. BASEMENT 1/4" = 1'-0" AT 22"X34" LAYOUT 1/8"= 1'-0" AT 11" X 17" LAYOUT





(2) ELEV 2 W/ OPT. PARTIAL BRICK 1/4" = 1'-0" AT 22'X34" LAYOUT 1/8" = 1'-0" AT 11" X 17" LAYOUT

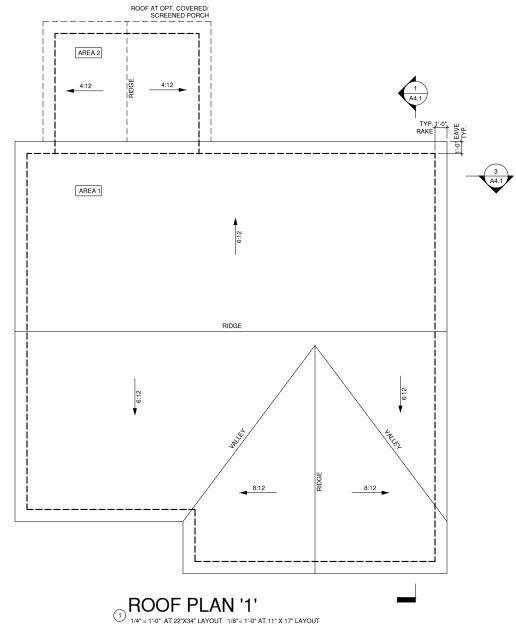


(3) ELEV 3 W/ OPT. PARTIAL BRICK



PROJECT TITLE:
CAMDEN
CONSTRUCTION SET
CLIENTS NAME: QUACKENBUSH HOMES
PROJECT NO:
SHEET TITLE:

NORTH CAROLINA OFFICE 102 POUNTAIN BROOK CIRCLE SUITE C CARY, NC 27511 PHONE: (919) 320-3022 THESE PLANS AND SPECIFICATIONS ARE PROTECTED UNDER FEDERAL COPYRIGHT LAWS © 2016. GMD DESIGN GROUP CAROLINAS, INC. MAINTAINS OWNERSHIP OF SUCH AND ALL RIGHTS AND PRIVILEGES.				
NO:	DATE:	REVISION:		
PROJECT TITLE:				
CAMDEN				



1/4" = 1'-0" AT 22"X34" LAYOUT 1/8" = 1'-0" AT 11" X 17" LAYOUT

1/150 RATIO:

GENERAL CONTRACTOR SHALL VERIFY THE NET FREE VENTILATION OF THE VENT PRODUCT SELECTED BY OWNER. VERIFY WITH MANUFACTURER OF HIGH AND LOW VENTS TO BE USED FOR MINIMUM CALCULATED VENTS REQUIRED. THE REQUIRED VENTILATION SHALL BE MAINTAINED. PROVIDE INSULATION STOP SUCH THAT INSULATION DOES NOT OBSTRUCT FREE AIR MOVEMENT AS REQUIRED BY THE BUILDING OFFICIAL.

ALL OVERLAP FRAMED ROOF AREAS SHALL HAVE OPENINGS BETWEEN THE ADJACENT ATTICS IN THE ROOF SHEATHING (AS ALLOWED BY THE STRUCTURAL ENGINEER) TO ALLOW PASSAGE AND ATTIC VENTILATION BETWEEN THE TWO OR ISOLATED ATTIC SPACES SHALL BE VENUED INFORMED ATTIC SPACES SHALL BE VENTED INDEPENDENTLY TO CBC REQUIREMENTS.

PER DEVELOPER, AT ALL CANTILEVERED FLOORS, CANTILEVERED DECORATIVE PROJECTIONS, AND ANY DOUBLE FRAMING PROJECTIONS THAT ARE SEPARATED FROM THE VENTING CALCULATIONS SHOWN ABOVE, PROVIDE A CONTINUOUS 2° CORROSION RESISTANT SOFFIT VENT AT UNDERSIDE OF FRAMED ELEMENT.

NOTES:

- ALL ROOF DRAINAGE SHALL BE PIPED TO STREET OR APPROVED DRAINAGE FACILITY.
 DASHED LINES INDICATE WALL BELOW.
 LOCATE GUTTER AND DOWNSPOUTS PER DWINGED
- BUILDER.

 PITCHED ROOFS AS NOTED.

 I
 TRUSS MANUFACTURER SHALL SUBMIT STRUCTURAL CALCS

 AND SHOP DRAWING TO THE BUILDER'S GENERAL
 CONTRACTOR AND BUILDING DEPARTMENT FOR REVIEW
 PRIOR TO FABRICATIONS. 1 ALL PLUMBING VENTS SHALL BE COMBINED INTO A MINIMUM AMOUNT OF ROOF PENETRATIONS. ALL ROOF PENETRATIONS SHALL OCCUR TO THE REAR OF THE MAIN RIDGE.

AS AN ALTERNATE TO THE 1/150 RATIO LISTED, THE NET FREE CROSS-VENTILATION AREA MAY BE REDUCED TO 1/300 WHEN A VAPOR BARRIER IS HAVING A TRANSMISSION RATE NOT EXCEEDING I-PERM INSTALLED ON THE WARM-IN-WINTER SIDE OF THE CEILING.

GENERAL CONTRACTOR SHALL VERIFY THE NET FREE VENTILATION OF THE VENT PRODUCT SELECTED BY OWNER. VERIFY WITH MANUFACTURER OF HIGH AND LOW VENTS TO BE USED FOR MINIMUM CALCULATED VENTS REQUIRED. THE REQUIRED VENTILATION SHALL BE MAINTAINED. PROVIDE INSULATION STOP SUCH THAT INSULATION DOES NOT OBSTRUCT FREE AIR MOVEMENT AS REQUIRED BY THE BUILDING OFFICIAL.

ALL OVERLAP FRAMED ROOF AREAS SHALL HAVE OPENINGS BETWEEN THE ADJACENT ATTICS IN THE ROOF SHEATHING (AS ALLOWED BY THE STRUCTURAL ENGINEER) TO ALLOW PASSAGE AND ATTIC VENTILATION BETWEEN THE TWO OR ISOLATED ATTIC SPACES SHALL BE VENTED INDEPENDENTLY TO CBC REQUIREMENTS.

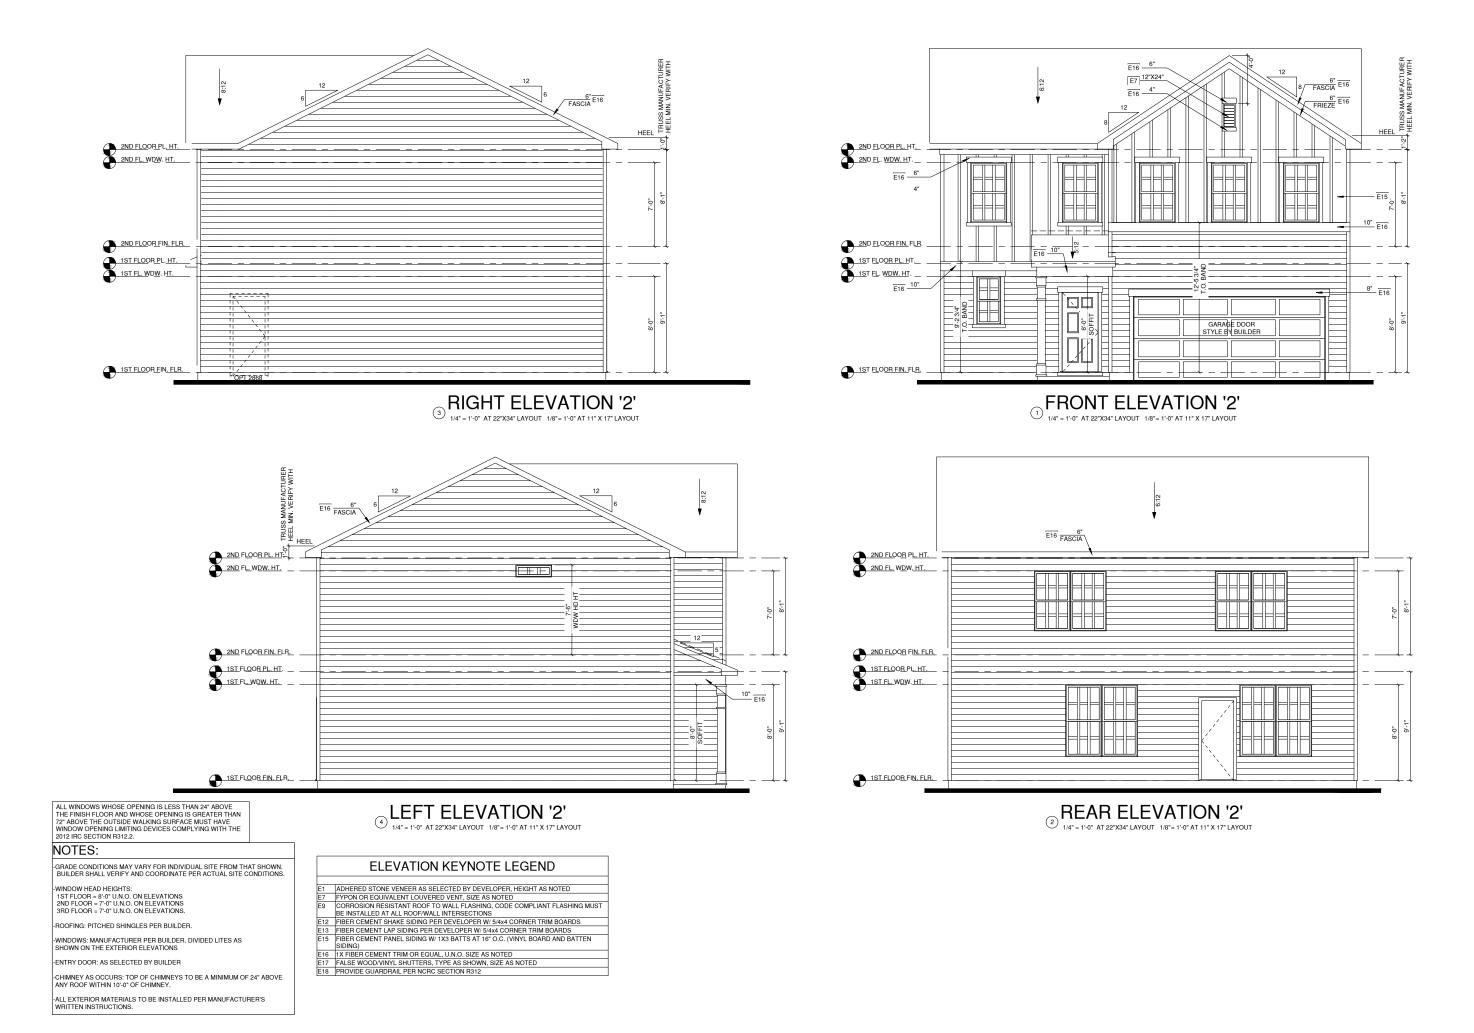
PER DEVELOPER, AT ALL CANTILEVERED FLOORS, CANTILEVERED DECORATIVE PROJECTIONS, AND ANY DOUBLE FRAMING PROJECTIONS THAT ARE SEPARATED FROM THE VENTING CALCULATIONS SHOWN ABOVE, PROVIDE A CONTINUOUS 2° CORROSION RESISTANT SOFFIT VENT AT UNDERSIDE OF FRAMED ELEMENT.

GENERAL CONTRACTOR SHALL VERIFY THE NET FREE

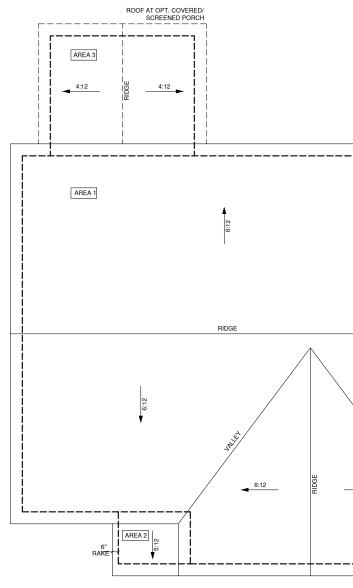
1/300 RATIO:

	ROOF VENT CALC. ELEV. 'A'				
Na	me	Area	1/300 RATIO AT HIGH & LOW	1/150 RATIO AT HIGH & LOW	
AREA 1	1	095 SF	262.88 in ²	525.76 in ²	
AREA 2	1	20 SF	28.80 in ²	57.60 in ²	

PARODER -	748 94 0 2 010 6	
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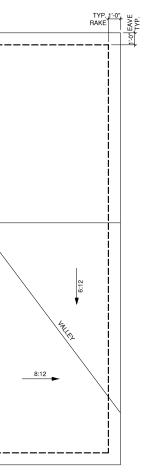
(1) **ROOF PLAN '2'** (1) 1/4* = 1*-0* AT 22*X34* LAYOUT 1/8* = 1*-0* AT 11* X 17* LAYOUT

1/150 RATIO:	1/300 RATIO:
GENERAL CONTRACTOR SHALL VERIFY THE NET FREE VENTILATION OF THE VENT PRODUCT SELECTED BY OWNER. VERIFY WITH MANUFACTURER OF HIGH AND LOW VENTS TO BE USED FOR MINIMUM CALCULATED VENTS REQUIRED. THE FROUIDED VENTIL ATTOR SHALL	AS AN ALTERNATE TO THE 1/150 RATIO LISTED, THE NET FREE CROSS-VENTILATION AREA MAY BE REDUCED TO 1/300 WHEN A VAPOR BARRIER IS HAVING A TRANSMISSION RATE NOT EXCEDING I-PERM INSTALLED ON THE WARM-IN- WINTER SIDE OF THE CEILING.
BE MAINTAINED. PROVIDE INSULATION STOP	GENERAL CONTRACTOR SHALL VERIFY THE NET FREE
SUCH THAT INSULATION DOES NOT OBSTRUCT FREE AIR MOVEMENT AS REQUIRED BY THE	VENTILATION OF THE VENT PRODUCT SELECTED BY OWNER, VERIEV WITH MANUFACTURER OF HIGH AND LOW
BUILDING OFFICIAL.	VENTS TO BE USED FOR MINIMUM CALCULATED VENTS REQUIRED. THE REQUIRED VENTILATION SHALL BE
ALL OVERLAP FRAMED ROOF AREAS SHALL	MAINTAINED. PROVIDE INSULATION STOP SUCH THAT
HAVE OPENINGS BETWEEN THE ADJACENT ATTICS IN THE ROOF SHEATHING (AS ALLOWED	INSULATION DOES NOT OBSTRUCT FREE AIR MOVEMENT AS REQUIRED BY THE BUILDING OFFICIAL.
BY THE STRUCTURAL ENGINEER) TO ALLOW	
PASSAGE AND ATTIC VENTILATION BETWEEN THE TWO OR ISOLATED ATTIC SPACES SHALL	ALL OVERLAP FRAMED ROOF AREAS SHALL HAVE OPENINGS BETWEEN THE ADJACENT ATTICS IN THE ROOF SHEATHING
BE VENTED INDEPENDENTLY TO CBC	(AS ALLOWED BY THE STRUCTURAL ENGINEER) TO ALLOW
REQUIREMENTS.	PASSAGE AND ATTIC VENTILATION BETWEEN THE TWO OR ISOLATED ATTIC SPACES SHALL BE VENTED
PER DEVELOPER, AT ALL CANTILEVERED	INDEPENDENTLY TO CBC REQUIREMENTS.
FLOORS, CANTILEVERED DECORATIVE PROJECTIONS, AND ANY DOUBLE FRAMING	PER DEVELOPER. AT ALL CANTILEVERED FLOORS.
PROJECTIONS THAT ARE SEPARATED FROM	CANTILEVERED DECORATIVE PROJECTIONS, AND ANY
THE VENTING CALCULATIONS SHOWN ABOVE,	DOUBLE FRAMING PROJECTIONS THAT ARE SEPARATED
PROVIDE A CONTINUOUS 2" CORROSION RESISTANT SOFFIT VENT AT UNDERSIDE OF	FROM THE VENTING CALCULATIONS SHOWN ABOVE, PROVIDE A CONTINUOUS 2" CORROSION RESISTANT SOFFIT
FRAMED ELEMENT.	VENT AT UNDERSIDE OF FRAMED ELEMENT.
NOTES:	
ALL ROOF DRAINAGE SHALL BE PIPED TO	TRUSS MANUFACTURER SHALL SUBMIT STRUCTURAL CALCS

- ALL ROOF DRAINAGE SHALL BE PIPED TO STREET OR APPROVED DRAINAGE FACILITY.
 DASHED LINES INDICATE WALL BELOW.
 LOCATE GUTTER AND DOWNSPOUTS PER BUILDER.
 PITCHED ROOFS AS NOTED.

ROOF VENT CALC. ELEV. 'B'				
Name	Area	1/300 RATIO AT HIGH & LOW	1/150 RATIO AT HIGH & LOW	
AREA 1	1095 SF	262.88 in ²	525.76 in ²	
AREA 2	26 SF	6.24 in ²	12.48 in ²	
AREA 3	120 SF	28.80 in ²	57.60 in ²	

TRUSS MANUFACTURER SHALL SUBMIT STRUCTURAL CALCS AND SHOP DRAWING TO THE BUILDER'S GENERAL CONTRACTOR AND BUILDING DEPARTMENT FOR REVIEW PRIOR TO FABRICATIONS. ALL PLUMBING VENTS SHALL BE COMBINED INTO A MINIMUM AMOUNT OF ROOF PENETRATIONS. ALL ROOF PENETRATIONS SHALL OCCUR TO THE REAR OF THE MAIN RIDGE.



ROOF PLAN '2'
PRINT DATE:
4-13-22
SHEET NO:
A5.2.1

ROOF PLAN '2'

SHEET TITLE:

PROJECT NO:

QUACKENBUSH HOMES

CLIENTS NAME:

CONSTRUCTION SET

CAMDEN

PROJECT TITLE:

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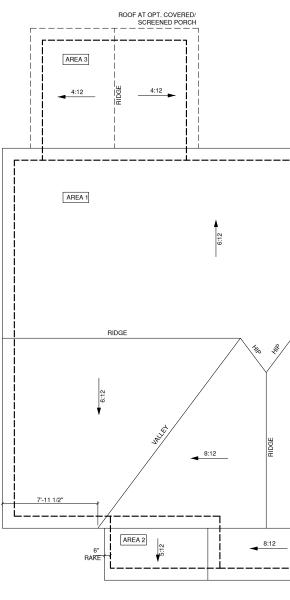
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-ALL EXTERIOR MATERIALS TO BE INSTALLED PER MANUFACTURER'S WRITTEN INSTRUCTIONS.

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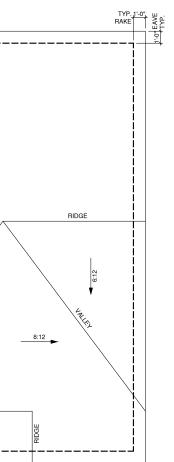


(1) **ROOF PLAN '4'** (1) 1/4"= 1'-0" AT 22"X34" LAYOUT 1/8"= 1'-0" AT 11" X 17" LAYOUT

1/150 RATIO:	1/300 RATIO:
GENERAL CONTRACTOR SHALL VERIFY THE	AS AN ALTERNATE TO THE 1/150 BATIO LISTED. THE NET
NET FREE VENTILATION OF THE VENT	FREE CROSS-VENTILATION AREA MAY BE REDUCED TO 1/300
PRODUCT SELECTED BY OWNER. VERIFY WITH	WHEN A VAPOR BARRIER IS HAVING A TRANSMISSION RATE
MANUFACTURER OF HIGH AND LOW VENTS TO	NOT EXCEEDING I-PERM INSTALLED ON THE WARM-IN-
BE USED FOR MINIMUM CALCULATED VENTS	WINTER SIDE OF THE CEILING.
REQUIRED. THE REQUIRED VENTILATION SHALL	
BE MAINTAINED. PROVIDE INSULATION STOP	GENERAL CONTRACTOR SHALL VERIFY THE NET FREE
SUCH THAT INSULATION DOES NOT OBSTRUCT	VENTILATION OF THE VENT PRODUCT SELECTED BY
FREE AIR MOVEMENT AS REQUIRED BY THE	OWNER. VERIFY WITH MANUFACTURER OF HIGH AND LOW
BUILDING OFFICIAL.	VENTS TO BE USED FOR MINIMUM CALCULATED VENTS
	REQUIRED. THE REQUIRED VENTILATION SHALL BE
ALL OVERLAP FRAMED ROOF AREAS SHALL	MAINTAINED. PROVIDE INSULATION STOP SUCH THAT
HAVE OPENINGS BETWEEN THE ADJACENT	INSULATION DOES NOT OBSTRUCT FREE AIR MOVEMENT AS
ATTICS IN THE ROOF SHEATHING (AS ALLOWED	REQUIRED BY THE BUILDING OFFICIAL.
BY THE STRUCTURAL ENGINEER) TO ALLOW	
PASSAGE AND ATTIC VENTILATION BETWEEN	ALL OVERLAP FRAMED ROOF AREAS SHALL HAVE OPENINGS
THE TWO OR ISOLATED ATTIC SPACES SHALL	BETWEEN THE ADJACENT ATTICS IN THE ROOF SHEATHING
BE VENTED INDEPENDENTLY TO CBC REQUIREMENTS.	(AS ALLOWED BY THE STRUCTURAL ENGINEER) TO ALLOW PASSAGE AND ATTIC VENTILATION BETWEEN THE TWO OR
REQUIREMENTS.	ISOLATED ATTIC SPACES SHALL BE VENTED
PER DEVELOPER. AT ALL CANTILEVERED	INDEPENDENTLY TO CBC REQUIREMENTS.
FLOORS, CANTILEVERED DECORATIVE	INDEPENDENTLY TO COC REQUIREMENTS.
PROJECTIONS, AND ANY DOUBLE FRAMING	PER DEVELOPER, AT ALL CANTILEVERED FLOORS.
PROJECTIONS THAT ARE SEPARATED FROM	CANTILEVERED DECORATIVE PROJECTIONS, AND ANY
THE VENTING CALCULATIONS SHOWN ABOVE.	DOUBLE FRAMING PROJECTIONS THAT ARE SEPARATED
PROVIDE A CONTINUOUS 2" CORROSION	FROM THE VENTING CALCULATIONS SHOWN ABOVE.
RESISTANT SOFFIT VENT AT UNDERSIDE OF	PROVIDE A CONTINUOUS 2" CORROSION RESISTANT SOFFIT
FRAMED ELEMENT.	VENT AT UNDERSIDE OF FRAMED ELEMENT.
NOTES:	
ALL ROOF DRAINAGE SHALL BE PIPED TO	TRUSS MANUFACTURER SHALL SUBMIT STRUCTURAL CALCS
STREET OR APPROVED DRAINAGE	AND SHOP DRAWING TO THE BUILDER'S GENERAL
FACILITY.	CONTRACTOR AND BUILDING DEPARTMENT FOR REVIEW
DASHED LINES INDICATE WALL BELOW.	PRIOR TO FABRICATIONS.
LOCATE GUTTER AND DOWNSPOUTS PER	ALL PLUMBING VENTS SHALL BE COMBINED INTO A MINIMUM
BUILDER.	AMOUNT OF ROOF PENETRATIONS. ALL ROOF PENETRATIONS
PITCHED ROOFS AS NOTED.	SHALL OCCUR TO THE REAR OF THE MAIN RIDGE.

ROOF VENT CALC. ELEV. 'D'

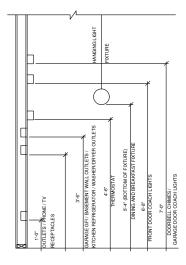
Name	Area	1/300 RATIO AT HIGH & LOW	1/150 RATIO AT HIGH & LOW
AREA 1	1082 SF	259.63 in ²	519.26 in ²
AREA 2	40 SF	9.49 in ²	18.98 in ²
AREA 3	120 SF	28.80 in ²	57.60 in ²



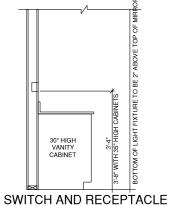
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102 FOUNTAIN BROOK CIRCLE SUITE C CARY, NC 27511 PHONE: (919) 320-3022		
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SHEET NO:

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STANDARD ELECTRICAL BOX HEIGHTS



BASE CABINET ÷

WALL ABINE

SWITCH AND RECEPTACLE BOXES OVER BATH CABINETS BOXES OVER KITCHEN CABINETS

NOTES:

PROVIDE GROUNDING ELECTRICAL ROD PER LOCAL CODES.

PROVIDE AND INSTALL ARC FAULT CIRCUIT-INTERRUPTERS (AFCI) AS REQUIRED BY NATIONAL ELECTRICAL CODE (NEC) AND MEETING THE REQURIEMENTS OF ALL GOVERNING CODES.

ALL EXHAUST FANS SHALL HAVE BACKDRAFT DAMPERS

FAN/LIGHTS IN WET/DAMP LOCATIONS SHALL BE LABLED "SUITABLE FOR WET OR DAMP LOCATIONS."

-ELECTRICAL SYSTEMS ARE SHOWN FOR INTENT ONLY. THESE SYSTEMS SHALL BE ENGINEERED BY OTHERS. THE CONTRACTOR SHALL BE RESPONSIBLE FOR PROPER INSTALLATION AND PLACEMENT.

PROVIDE AND INSTALL LOCALLY CERTIFIED SMOKE DETECTORS AND CO2 DETECTORS AS REQUIRED BY NATIONAL FIRE PROTECTION ASSOCIATION (NFPA) AND MEETING THE REQUIREMENTS OF ALL GOVERNING CODES.

-PROVIDE AND INSTALL GROUND FAULT CIRCUIT-INTERRUPTERS (GFI) AS REQUIRED BY NATIONAL ELECTRICAL CODE (NEC) AND MEETING THE REQUIREMENTS OF ALL GOVERNING CODES.

ELECTRICAL CONTRACTOR TO PROVIDE REQURIED DIRECT HOOK-UPS/CUTOFFS.

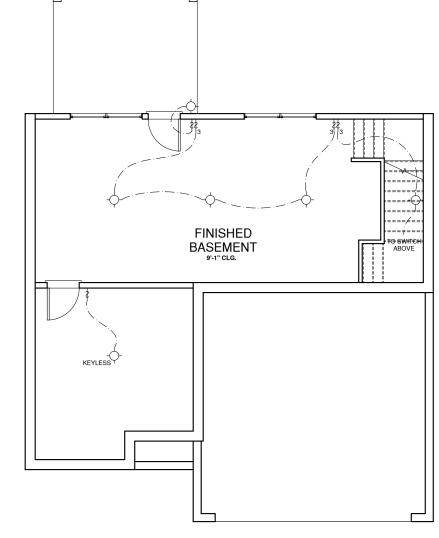
HVAC CONTRACTOR TO VERIFY THERMOSTAT LOCATIONS.

ALL ELECTRICAL AND MECHANICAL EQUIPMENT (FURNACES, A/C UNITS, ELECTRICAL PANELS, SANITARY SUMP PITS, DRAING TILE SUMP, AND WATER HEATERS) ARE SUBJECT TO RELOCATOIN DUE TO FIELD CONDITIONS.

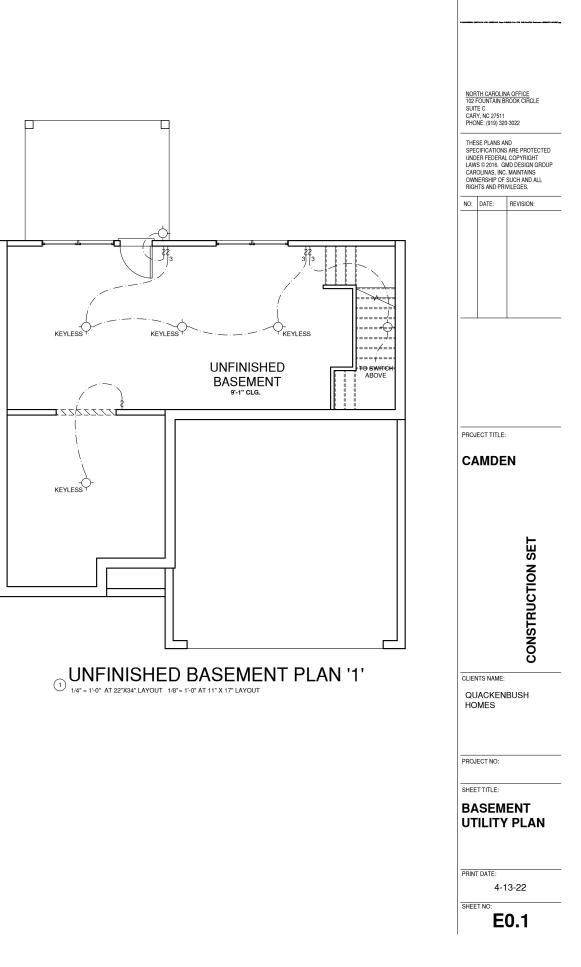
PROVIDE POWER, LIGHT AND SWITCH AS REQUIRED FOR ATTIC FURNACE PER CODE AND MANUFACTURER'S WRITTEN INSTRUCTIONS.

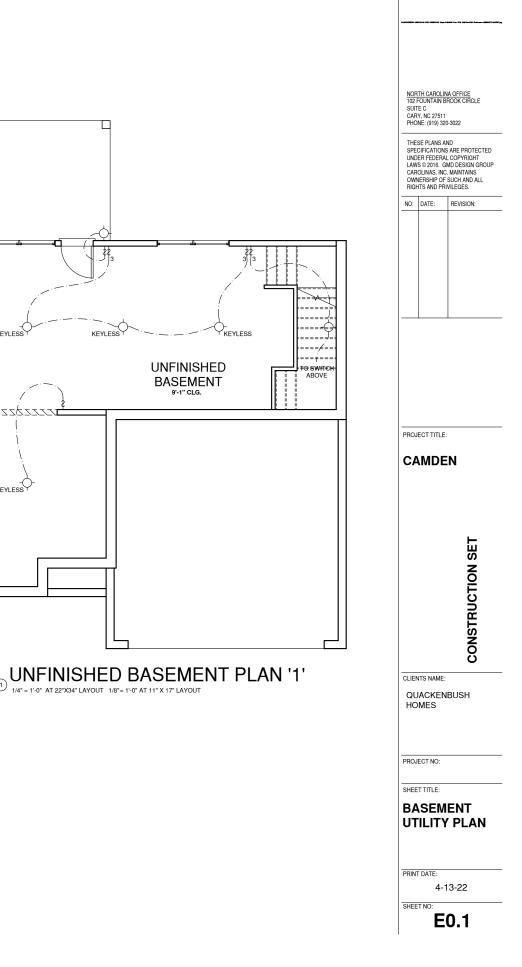
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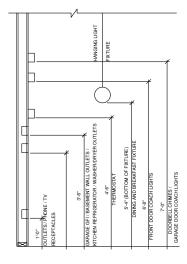
LEGE	ND:		
P	DUPLEX OUTLET	-0-	CEILING MOUNTED INCANDESCENT LIGHT FIXTURE
¶wp/gFi	WEATHERPROOF GFI DUPLEX OUTLET	-	WALL MOUNTED INCANDESCENT LIGHT FIXUTRE
₽gfi	GROUND-FAULT CIRCUIT- INTERRUPTER DUPLEX OUTLET	Å	RECESSED INCANDESCENT LIGHT FIXTURE
P	HALF-SWITCHED DUPLEX OUTLET	¥	(VP) = VAPOR PROOF
₽ 220V	220 VOLT OUTLET		EXHAUST FAN (VENT TO EXTERIOR)
J	REINFORCED JUNCTION BOX	-0-	EXHAUST FAN/LIGHT COMBINATION (VENT TO EXTERIOR)
\$	WALL SWITCH		<u> </u>
\$3	THREE-WAY SWITCH	\geq	FLUORESCENT LIGHT FIXTURE
\$4	FOUR-WAY SWITCH		. TECH HUB SYSTEM
СН	CHIMES		CEILING FAN
•	PUSHBUTTON SWITCH	\sim	(PROVIDE ADEQUATE SUPPORT)
SD	110V SMOKE DETECTOR W/ BATTERY BACKUP	S.	CEILING FAN WITH INCANDESCENT LIGHT FIXTURE
Co	CO2 DETECTOR		(PROVIDE ADEQUATE SUPPORT)
1	THERMOSTAT	⊢∞	GAS SUPPLY WITH VALVE
PH	TELEPHONE		
TV	TELEVISION	Нв	HOSE BIBB
Ô	ELECTRIC METER	-tw	1/4" WATER STUB OUT
	ELECTRIC PANEL	- 7	WALL SCONCE
-	DISCONNECT SWITCH	к	



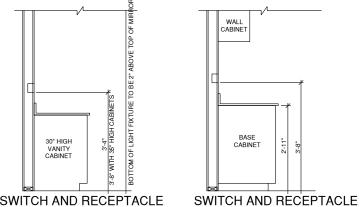
(2) FINISHED BASEMENT PLAN '1'







STANDARD ELECTRICAL BOX HEIGHTS



SWITCH AND RECEPTACLE BOXES OVER BATH CABINETS

NOTES:

PROVIDE GROUNDING ELECTRICAL ROD PER LOCAL CODES.

PROVIDE AND INSTALL ARC FAULT CIRCUIT-INTERRUPTERS (AFCI) AS REQUIRED BY NATIONAL ELECTRICAL CODE (NEC) AND MEETING THE REQURIEMENTS OF ALL GOVERNING CODES.

AN/LIGHTS IN WET/DAMP LOCATIONS SHALL BE LABLED "SUITABLE FOR WET OR DAMP LOCATIONS.

ELECTRICAL SYSTEMS ARE SHOWN FOR INTENT ONLY, THESE SYSTEMS SHALL BE ENGINEERED BY RACTOR SHALL BE RESPONSIBLE FOR PROPER INSTALLATION AND PLACEMENT

30VIDE AND INSTALL LOCALLY CERTIFIED SMOKE DETECTORS AND CO2 DETECTORS AS REQUIRED BY DCIATION (NFPA) AND MEETING THE REQUIREMENTS OF ALL GOVERNING CODES

BOXES OVER KITCHEN CABINETS

PROVIDE AND INSTALL GROUND FAULT CIRCUIT-INTERRUPTERS (GFI) AS REQUIRED BY NATIONAL ELECTRICAL CODE (NEC) AND MEETING THE REQUIREMENTS OF ALL GOVERNING CODES.

ELECTRICAL CONTRACTOR TO PROVIDE REQURIED DIRECT HOOK-UPS/CUTOFFS

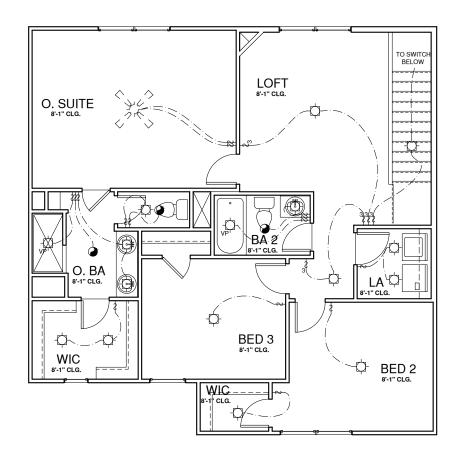
VAC CONTRACTOR TO VERIFY THERMOSTAT LOCATIONS.

ALL ELECTRICAL AND MECHANICAL EQUIPMENT (FURNACES, A/C UNITS, ELECTRICAL PANELS, SANITARY SUMP PITS, DRAING TILE SUMP, AND WATER HEATERS) ARE SUBJECT TO RELOCATOIN DUE TO FIELD CONDITIONS.

PROVIDE POWER, LIGHT AND SWITCH AS REQUIRED FOR ATTIC FURNACE PER CODE AND MANUFACTURER'S WRITTEN INSTRUCTIONS.

I EGEND.

P	DUPLEX OUTLET	-0- (CEILING MOUNTED INCANDESCENT LIGHT FIXTURE	
₩P/GFI	WEATHERPROOF GFI DUPLEX OUTLET	- WALL MOUNTED INCANDESCENT LIGHT FIXUTRE		
Pgfi	GROUND-FAULT CIRCUIT- INTERRUPTER DUPLEX OUTLET		STD. PKG. IS LED PUCK LIGHT	
P	HALF-SWITCHED DUPLEX OUTLET	OPT. PKG. IS RECESSED CAN LIGHT		
₽ 220V	220 VOLT OUTLET	O E	EXHAUST FAN (VENT TO EXTERIOR)	
J	REINFORCED JUNCTION BOX		EXHAUST FAN/LIGHT COMBINATION	
\$	WALL SWITCH		(
\$3	THREE-WAY SWITCH		FLUORESCENT LIGHT FIXTURE	
\$4	FOUR-WAY SWITCH		TECH HUB SYSTEM	
СН	CHIMES		CEILING FAN (PROVIDE ADEQUATE SUPPORT)	
P	PUSHBUTTON SWITCH	\sim		
SD	110V SMOKE DETECTOR W/ BATTERY BACKUP		CEILING FAN WITH INCANDESCENT LIGHT FIXTURE	
Co	CO2 DETECTOR	(PROVIDE ADEQUATE SUPPORT)		
T	THERMOSTAT	⊢⊗ (← S GAS SUPPLY WITH VALVE	
PH	TELEPHONE	-		
TV	TELEVISION			
0	ELECTRIC METER	-tw1	/4" WATER STUB OUT	
	ELECTRIC PANEL	м		
±	DISCONNECT SWITCH	י גרן	WALL SCONCE	



(2) SECOND FLOOR PLAN ELEV '1' - STD PKG

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O. BA

8'-1" CLG.

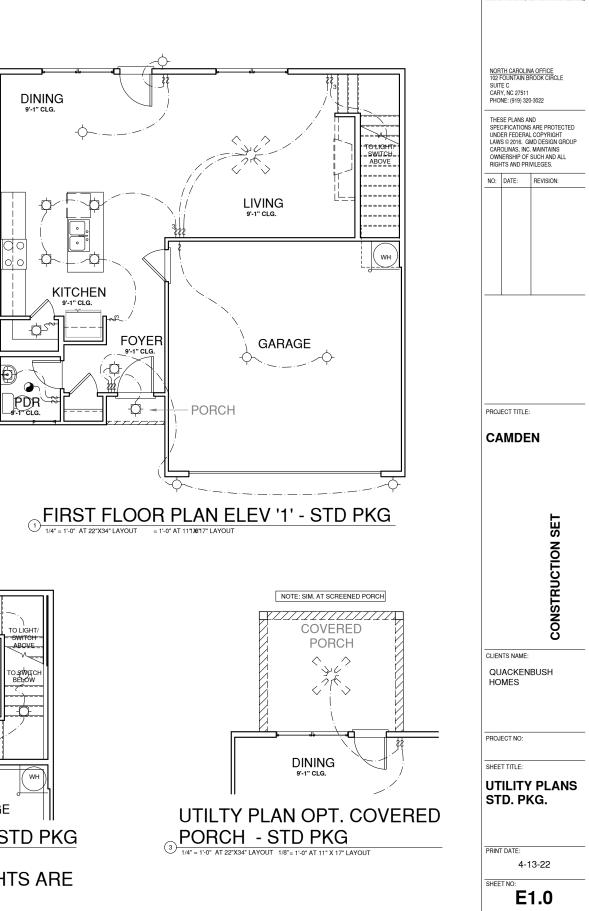
NOTE: OPT. UP

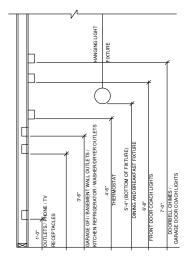
BATH #2 SIM.

0

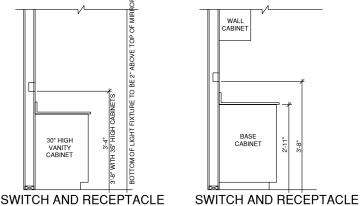
тотіднт LIVING BOY 9'-1" CLG. WH GARAGE (5) OPT. UP BATH #1 - STD PKG OPT. BASEMENT STAIR - STD PKG (4)-

> NOTE: SURFACE LIGHTS ARE LED PUCK LIGHTS





STANDARD ELECTRICAL BOX HEIGHTS



SWITCH AND RECEPTACLE BOXES OVER BATH CABINETS

NOTES:

PROVIDE GROUNDING ELECTRICAL ROD PER LOCAL CODES.

PROVIDE AND INSTALL ARC FAULT CIRCUIT-INTERRUPTERS (AFCI) AS REQUIRED BY NATIONAI ELECTRICAL CODE (NEC) AND MEETING THE REQURIEMENTS OF ALL GOVERNING CODES.

LL EXHAUST FANS SHALL HAVE BACKDRAFT DAMPER

AN/LIGHTS IN WET/DAMP LOCATIONS SHALL BE LABLED "SUITABLE FOR WET OR DAMP LOCATIONS.

ELECTRICAL SYSTEMS ARE SHOWN FOR INTENT ONLY, THESE SYSTEMS SHALL BE ENGINEERED BY THERS. THE CONTRACTOR SHALL BE RESPONSIBLE FOR PROPER INSTALLATION AND PLACEMENT

30VIDE AND INSTALL LOCALLY CERTIFIED SMOKE DETECTORS AND CO2 DETECTORS AS REQUIRED BY OCIATION (NFPA) AND MEETING THE REQUIREMENTS OF ALL GOVERNING CODES

BOXES OVER KITCHEN CABINETS

PROVIDE AND INSTALL GROUND FAULT CIRCUIT-INTERRUPTERS (GFI) AS REQUIRED BY NATIONAL ELECTRICAL CODE (NEC) AND MEETING THE REQUIREMENTS OF ALL GOVERNING CODES.

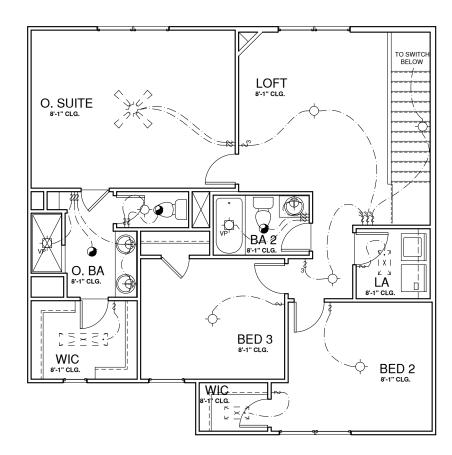
ELECTRICAL CONTRACTOR TO PROVIDE REQURIED DIRECT HOOK-UPS/CUTOFFS

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ALL ELECTRICAL AND MECHANICAL EQUIPMENT (FURNACES, A/C UNITS, ELECTRICAL PANELS, SANITARY SUMP PITS, DRAING TILE SUMP, AND WATER HEATERS) ARE SUBJECT TO RELOCATOIN DUE TO FIELD CONDITIONS.

PROVIDE POWER, LIGHT AND SWITCH AS REQUIRED FOR ATTIC FURNACE PER CODE AND MANUFACTURER'S WRITTEN INSTRUCTIONS.

LEGEND:				
P	DUPLEX OUTLET			
₩P/GFI	WEATHERPROOF GFI DUPLEX OUTLET	WALL MOUNTED INCANDESCENT LIGHT FIXUTRE		
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J	REINFORCED JUNCTION BOX	EXHAUST FAN/LIGHT COMBINATION (VENT TO EXTERIOR)		
\$	WALL SWITCH			
\$3	THREE-WAY SWITCH	FLUORESCENT LIGHT FIXTURE		
\$4	FOUR-WAY SWITCH	LECH HUB SYSTEM		
СН	CHIMES	CEILING FAN		
9	PUSHBUTTON SWITCH	(PROVIDE ADEQUATE SUPPORT)		
SD	110V SMOKE DETECTOR W/ BATTERY BACKUP	CEILING FAN WITH INCANDESCENT LIGHT FIXTURE		
Co	CO2 DETECTOR	(PROVIDE ADEQUATE SUPPORT)		
T	THERMOSTAT	←⊗ GAS SUPPLY WITH VALVE		
PH	TELEPHONE			
TV	TELEVISION	HB HOSE BIBB		
Ô	ELECTRIC METER	CW 1/4" WATER STUB OUT		
	ELECTRIC PANEL	<u>u</u>		
±	DISCONNECT SWITCH	-5 WALL SCONCE		



(2) SECOND FLOOR PLAN ELEV '1' 1/4" = 1'-0" AT 22"X34" LAYOUT 1/8" = 1'-0" AT 11" X 17" LAYOUT

FOYER

9'-1" CLG

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DINING 9'-1" CLG.

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KITCHEN

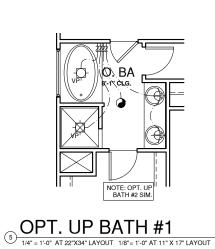
9'-1" CLG.

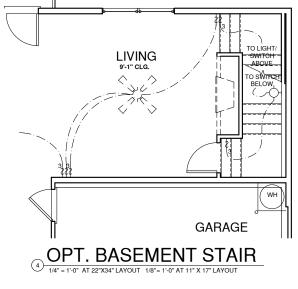
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PDR 9-1" CLG.





NOTE: SURFACE LIGHTS ARE **RECESSED CAN LIGHTS**

